

# **24-36 LANGSTON PLACE, EPPING**

## **Overshadowing and Solar Impact Assessment Peer Review**

**Prepared for:**

Langston R&J Pty Ltd  
Level 4, 398-402 Sussex Street  
HAYMARKET NSW 2000

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## BASIS OF REPORT

This report has been prepared by SLR Consulting Australia Pty Ltd with all reasonable skill, care and diligence, and taking account of the timescale and resources allocated to it by agreement with Langston R&J Pty Ltd (the Client). Information reported herein is based on the interpretation of data collected, which has been accepted in good faith as being accurate and valid.

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## DOCUMENT CONTROL

Reference	Date	Prepared	Checked	Authorised
610.17098-R05-v1.0	29 August 2018	James Cleary	Neihad Al-Khalidy	Neihad Al-Khalidy

## EXECUTIVE SUMMARY

SLR Consulting Australia Pty Ltd (SLR) has been engaged by Langston R&J Pty Ltd (Langston R&J) to conduct a detailed solar access analysis for the site and surrounds of the proposed 24-36 Langston Place, Epping development. Specific attention is focused around the proposed site and surrounds impact upon the neighbouring CBUS development at 12-22 Langston Place.

The State Environmental Planning Policy (SEPP) 65, supported by the Apartment Design Guide - Part 04 is relevant to the assessment of the daylight access into residential component of the proposed development. The above regulation states that:

- Living rooms and private open spaces of at least 70% of apartments in a building receive a minimum of 2 hours direct sunlight between 9 am and 3 pm at mid-winter in the Sydney Metropolitan Area and in the Newcastle and Wollongong local government areas.
- In all other areas, living rooms and private open spaces of at least 70% of the apartments in a building receive a minimum of 3 hours direct sunlight between 9 am and 3 pm at mid-winter.
- A maximum of 15% of apartments in a building receive no direct sunlight between 9 am and 3 pm at mid-winter.

The ADG also outlines the following design guidance:

- To maximise the benefit to residents of direct sunlight within living rooms and private open spaces, a minimum of  $1m^2$  of direct sunlight, measured at 1m above floor level is achieved for at least 15 minutes.

### Impact on CBUS Development at 12-22 Langston Place

From the model provided SLR has calculated the below summarised ADG assessed direct sunlight to residential apartment results for June 21, between the hours of 9.00 am and 3.00 pm, accounting for multiple relevant surrounding schemes:

- Assessing solar access solely to the 12-22 Langston Place development with no other future proposed surrounds, SLR found that 68.0% (315 of 463) of apartments within the 12-22 Langston Place development would achieve 2hrs direct solar access.
- Assessing solar access against surrounds for the current proposed DA design 24-36 Langston Place, SLR found that 56.2% (260 of 463) of apartments within the 12-22 Langston Place development would achieve 2hrs direct solar access.
  - The proposed current DA for 24-36 Langston Place will reduce solar access to 12-22 Langston Place by 11.8%.
- Assessing solar access against surrounds for the ADG compliant massing to 24-36 Langston Place, SLR found that 58.8% (272 of 463) of apartments within the 12-22 Langston Place development would achieve 2hrs direct solar access.
  - The ADG compliant massing for 24-36 Langston Place will reduce solar access to 12-22 Langston Place by 9.2%.

## EXECUTIVE SUMMARY

- Assessing solar access against surrounds for the ADG compliant massing to 24-36 Langston Place plus the future proposed northern development, SLR found that 55.5% (257 of 463) of apartments within the 12-22 Langston Place development would achieve 2hrs direct solar access.
  - The ADG compliant massing for 24-36 Langston Place plus the future proposed northern development will reduce solar access to 12-22 Langston Place by 12.5%.

From the model provided SLR has also conducted an assessment of direct sunlight to residential apartments for June 21, between the hours of 8.00 am and 4.00 pm, finding the below:

- Assessing solar access solely to the 12-22 Langston Place development with no other future proposed surrounds, SLR found that 77.5% (359 of 463) of apartments within the 12-22 Langston Place development would achieve 2hrs direct solar access.
- Assessing solar access against surrounds for the current proposed DA design 24-36 Langston Place, SLR found that 68.9% (319 of 463) of apartments within the 12-22 Langston Place development would achieve 2hrs direct solar access.
- Assessing solar access against surrounds for the ADG compliant massing to 24-36 Langston Place, SLR found that 70.4% (326 of 463) of apartments within the 12-22 Langston Place development would achieve 2hrs direct solar access.
- Assessing solar access against surrounds for the ADG compliant massing to 24-36 Langston Place plus the future proposed northern development, SLR found that 67.1% (311 of 463) of apartments within the 12-22 Langston Place development would achieve 2hrs direct solar access.

### Impact on CBUS Development Communal Open Space and Landscaped Area

In assessing solar access to the landscaped podium of Tower 1 and 2 for the CBUS development SLR noted the following:

- Considering existing surrounds the Tower 1 and 2 landscaped area of the CBUS development will achieve solar access to greater than 74% of open area for 2 hrs.
- Considering the proposed DA + Future Northern Development surrounds the Tower 1 and 2 landscaped area of the CBUS development will achieve solar access to greater than 35% of open area for 2 hrs.
- Considering the ADG compliant DA + Future Northern Development surrounds the Tower 1 and 2 landscaped area of the CBUS development will achieve solar access to greater than 36% of open area for 2 hrs.

### Solar Access to Proposed DA for 24-36 Langston Place

With respect to solar access to 24-36 Langston Place when considering future surrounds SLR found the development will meet solar access requirements across June 21, between 9.00 am and 3.00 pm, with:

- 70.30% (71 of 101) of apartments achieving 2 hours solar access across June 21, between 9.00 am and 3.00 pm.
- 9.90% (10 of 101) of apartments achieving no solar access across June 21, between 9.00 am and 3.00 pm.

## CONTENTS

<b>1</b>	<b>INTRODUCTION.....</b>	<b>7</b>
1.1	Proposed Development Description.....	7
1.2	CBUS Development Description .....	8
<b>2</b>	<b>MODELLING .....</b>	<b>9</b>
2.1	Site Orientation.....	9
<b>3</b>	<b>SOLAR ACCESS.....</b>	<b>10</b>
3.1	Daylighting Considerations .....	10
3.2	Scope of Assessment .....	10
<b>4</b>	<b>RESULTS.....</b>	<b>11</b>
4.1	Overshadowing Impact on CBUS Development Apartment Solar Access .....	11
4.2	Overshadowing Impact on CBUS Development Communal Open Space.....	12
4.3	Solar Access to Proposed DA for 24-36 Langston Place .....	13
<b>5</b>	<b>DISCUSSION .....</b>	<b>14</b>
5.1	Overshadowing Impact on CBUS Development Apartment Solar Access .....	14
5.1.1	Current DA Scheme	14
5.1.2	ADG Massing	14
5.1.3	ADG Massing + Future Northern Development	15
5.2	Overshadowing Impact on CBUS Development Communal Open Space.....	16
5.3	Solar Access to CBUS Development Apartment T3-02-05 and Similar .....	17
5.4	Solar Access to 24-36 Langston Place 804 and Similar .....	18
<b>6</b>	<b>CONCLUSION .....</b>	<b>19</b>

## TABLES

Table 1	Solar Access Summary to Residential Apartments between 9.00 am and 3.00 pm on June 21 .....	11
Table 2	Solar Access Summary to Residential Apartments between 8.00 am and 4.00 pm on June 21 .....	11
Table 3	Solar Access to Tower 1 and 2 Landscaped Area .....	12
Table 4	Solar Access Summary for 24-36 Langston Place DA Scheme between 9.00 am and 3.00 pm on June 21.....	13

## CONTENTS

### FIGURES

Figure 1	Site Location .....	7
Figure 2	Perspective View of Proposed Site.....	8
Figure 3	3D Model in ECOTECT.....	9
Figure 4	Impact of Proposed DA 24-36 Langston Place .....	14
Figure 5	Impact of ADG Compliant Massing 24-36 Langston Place .....	15
Figure 6	Impact of ADG Compliant Massing 24-36 Langston Place + Future Northern Development .....	16
Figure 7	CBUS Tower 1 and 2 Communal Open Space.....	16
Figure 8	Area Assessed for Solar Access to T3-02-05 .....	17
Figure 9	Solar Access to Apartment T3-15-05 at 1300 and 1315.....	17
Figure 10	Solar Access to 24-36 Langston Place at 1300.....	18
Figure 11	Solar Access to 24-36 Langston Place at 1315.....	18

### APPENDICES

Appendix A	Provided Drawings Used in Assessments
Appendix B	Survey Data
Appendix C	Sun Eye Views DA Scheme
Appendix D	Sun Eye Views ADG Massing
Appendix E	Sun Eye Views ADG Massing + Future Northern Development
Appendix F	Sun Eye Views CBUS Development with no other Proposed Development
Appendix G	Solar Access to Private Living Space Calculation DA Scheme
Appendix H	Solar Access to Private Living Space Calculation ADG Massing
Appendix I	Solar Access to Private Living Space Calculation ADG Massing + Future Northern Development
Appendix J	Solar Access to Private Living Space Calculation CBUS Development with no other Proposed Development
Appendix K	Shadow Diagrams Existing surrounds to Tower 1 and 2
Appendix L	Shadow Diagrams DA + Future Northern Development surrounds to Tower 1 and 2
Appendix M	Shadow Diagrams ADG + Future Northern Development surrounds to Tower 1 and 2
Appendix N	Sun Eye Views DA Scheme + Future Northern Development
Appendix O	Solar Access to Private Living Space Calculation 24-36 Langston Place

## 1 Introduction

SLR Consulting Australia Pty Ltd (SLR) has been engaged by Langston R&J Pty Ltd (Langston R&J) to conduct a detailed solar access analysis for the surrounds of the proposed 24-36 Langston Place, Epping development. Specific attention is focused around the proposed sites impact upon the neighbouring CBUS development at 12-22 Langston Place.

**Figure 1 Site Location**



### 1.1 Proposed Development Description

The proposed development will include:

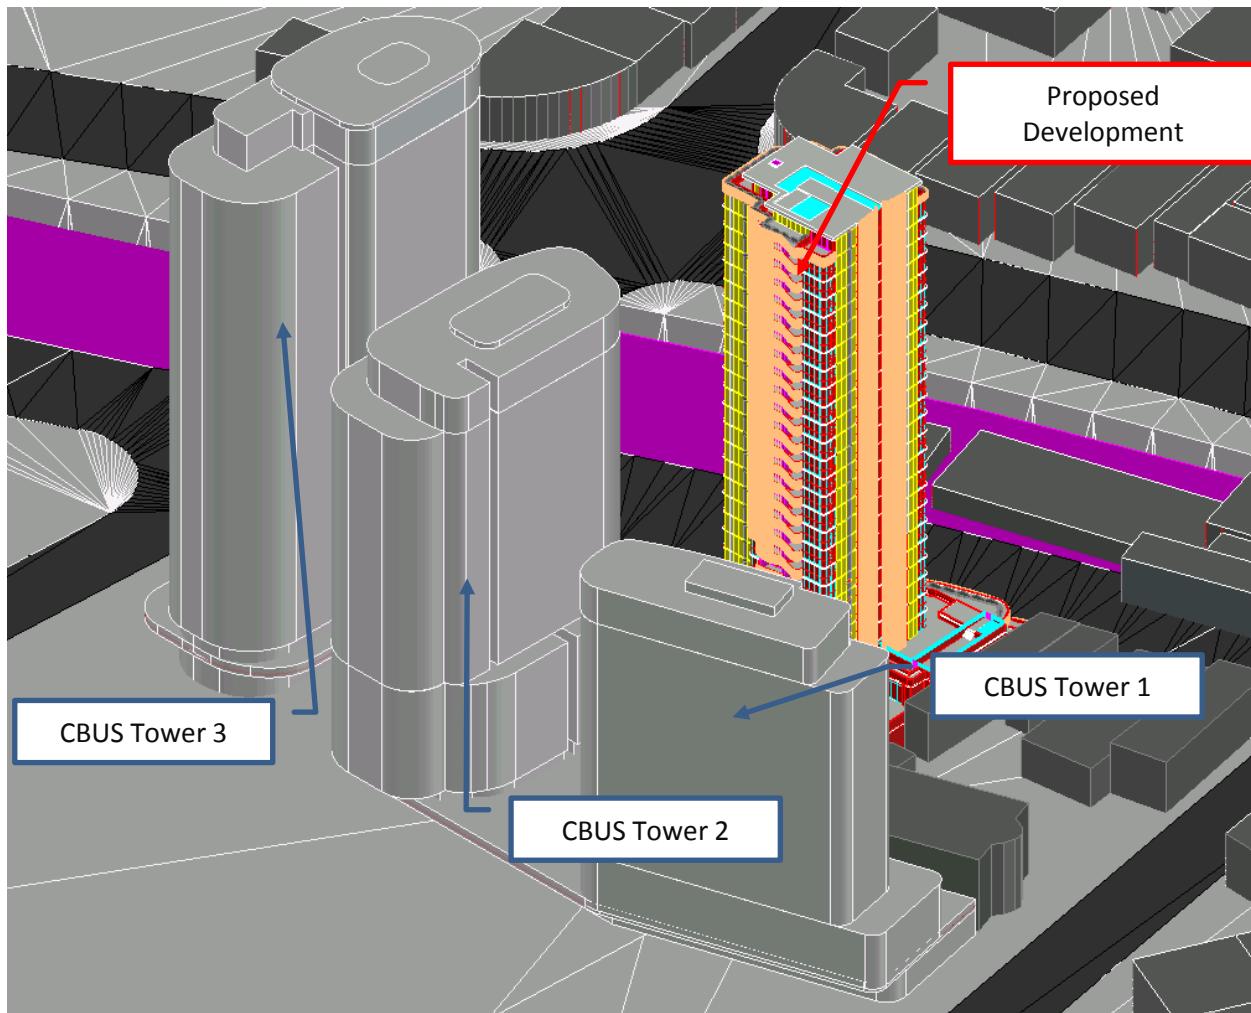
- 5 levels of basement car parking.
- Residential Entry Lobby on Ground Floor.
- Retail and Commercial tenancies on Ground Floor and Level 1, including a large, landscaped terrace on the eastern half of the site at Level 1 connected to a BBQ-terrace area.
- Residential units on Level 2 to Level 26.

## 1.2 CBUS Development Description

The neighbouring CBUS development will include:

- 4 levels of basement car parking.
- Retail Tenancies and Residential Entry Lobby's on Ground Floor.
- Residential apartments and communal open areas on Level 1 (Podium).
- Tower 1 with residential apartments from Level 1 to Level 18, 91 apartments in total.
- Tower 2 with residential apartments from Level 1 to Level 23, 179 apartments in total.
- Tower 3 with residential apartments from Level 1 to Level 28, 193 apartments in total.
- 463 residential apartments total across the site.

**Figure 2 Perspective View of Proposed Site**



## 2 Modelling

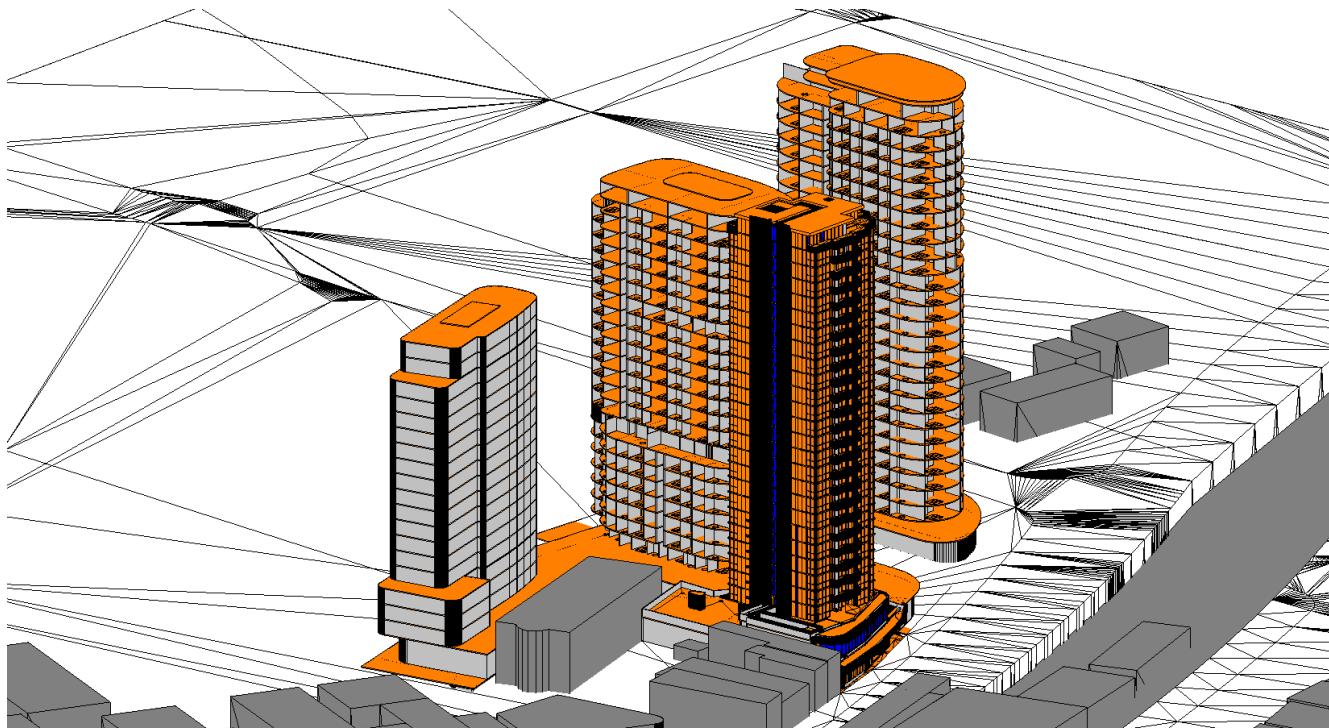
The 3D CAD files, listed below, provided by PTW Architects (PTW) were utilised to conduct the solar analysis (Refer **Figure 3**). CAD files used in assessment:

- PA014879\_Langston\_AA\_FA\_DA\_C4R - 3D View.dwg, received Thursday 26 July 2018.
- 3DView.dwg, received Monday 30 July 2018.
- 3DView-CBUS.dwg, received Monday 30 July 2018.
- 3DView\_ADG compliant\_Future North.dwg, received Thursday 2 August 2018.
- 3DView\_DA building.dwg, received Wednesday 22 August 2018.

SLR used DA architectural plans DA1005 to DA1024 along with elevations DA2000 to DA2007, attached in **Appendix A**, prepared by Architectus Sydney and provided by PTW, to review the layouts of the 12-22 Langston Place development.

SLR used the amended DA architectural plans DA-1003 to DA-1004 along with elevations DA-2001 to DA-2003, dated 30 July 2018, prepared by PTW, to review the layouts of the 24-36 Langston Place development.

**Figure 3 3D Model in ECOTECT**



### 2.1 Site Orientation

SLR used the True North direction shown in the site survey (REF: 7217, dated 04/11/2016), attached **Appendix B**, prepared by SDG Land Development Solutions for Langston R&J. This was found to be in line with the True North of the model provided by PTW.

## 3 Solar Access

### 3.1 Daylighting Considerations

The State Environmental Planning Policy (SEPP) 65, supported by the Apartment Design Guide - Part 04 is relevant to the assessment of the daylight access into residential component of the proposed development. The above regulation states that:

- Living rooms and private open spaces of at least 70% of apartments in a building receive a minimum of 2 hours direct sunlight between 9 am and 3 pm at mid-winter in the Sydney Metropolitan Area and in the Newcastle and Wollongong local government areas.
- In all other areas, living rooms and private open spaces of at least 70% of the apartments in a building receive a minimum of 3 hours direct sunlight between 9 am and 3 pm at mid-winter.
- A maximum of 15% of apartments in a building receive no direct sunlight between 9 am and 3 pm at mid-winter.

The ADG also outlines the following design guidance:

- To maximise the benefit to residents of direct sunlight within living rooms and private open spaces, a minimum of  $1m^2$  of direct sunlight, measured at 1m above floor level is achieved for at least 15 minutes.

SLR has been instructed to assess against the ADG requirements. Specific interest therefore lies in the solar access through living area windows and to balconies of residential apartments during the winter solstice, June 21, between the hours of 9.00 am and 3.00 pm.

### 3.2 Scope of Assessment

In line with assessments that have been carried out to date, SLR has been requested to assess solar access to the 12-22 Langston Place development accounting for multiple schemes for the proposed 24-36 Langston Place development and surrounds, these will include:

- Current DA scheme for 24-36 Langston Place.
- ADG Compliant Scheme for 24-36 Langston Place.
- ADG Compliant Scheme for 24-36 Langston Place + Future Northern Development.
- No Development to either of 24-36 Langston Place and the Future Northern Site (Current Surrounds).

In addition SLR will also assess solar access to the Tower 1 and 2 landscaped area of the CBUS development for:

- No Development to either of 24-36 Langston Place and the Future Northern Site (Current Surrounds).
- Current DA Scheme for 24-36 Langston Place + Future Northern Development
- ADG Compliant Scheme for 24-36 Langston Place + Future Northern Development.

Furthermore SLR will assess solar access to apartments within the 24-36 Langston Place for the proposed DA scheme, accounting for future proposed surrounds. SLR will assess solar access for the above across June 21, between 9.00 am and 3.00 pm.

## 4 Results

### 4.1 Overshadowing Impact on CBUS Development Apartment Solar Access

SLR imported the AutoCAD 3D model into ECOTECT and sun's eye view diagrams were generated for each 15 minute interval between 8.00 am and 4.00 pm on the Winter Solstice (21 June). These can be seen in attached appendices listed below:

- **Appendix C – Sun Eye Views DA Scheme**
- **Appendix D – Sun Eye Views ADG Massing**
- **Appendix E – Sun Eye Views ADG Massing + Future Northern Development**
- **Appendix F – Sun Eye Views CBUS Development with no other Proposed Development**

Results to solar access to living rooms and private open spaces of apartments in the assessed CBUS buildings on June 21 (winter solstice) between the hours of 9.00 am and 3.00 pm inclusive are summarised in the table below, detailed results can be found in **Appendices G – J**.

**Table 1 Solar Access Summary to Residential Apartments between 9.00 am and 3.00 pm on June 21**

Assessed Surrounds	Number of Apartments	No. of Apartment living areas with at least 2hr of direct sunlight	Percentage of Apartments living areas with 2hr of direct sunlight
No other Future Building	463	315	68.0%
DA Scheme	463	260	56.2%
ADG Massing	463	272	58.8%
ADG + Future North	463	257	55.5%

Based off **Table 1**, SLR has concluded that no proposed scheme for the surrounds of the CBUS development would see the building achieve the required 70% solar access to living rooms and balconies.

In addition to the above, solar access to apartments has also been assessed between the hours of 8.00 am and 4.00 pm, with results summarised in the table below.

**Table 2 Solar Access Summary to Residential Apartments between 8.00 am and 4.00 pm on June 21**

Assessed Surrounds	Number of Apartments	No. of Apartment living areas with at least 2hr of direct sunlight	Percentage of Apartments living areas with 2hr of direct sunlight
No other Future Building	463	359	77.5%
DA Scheme	463	319	68.9%
ADG Massing	463	326	70.4%
ADG + Future North	463	311	67.1%

Based off **Table 2**, a noticeably significant improvement in solar access results can be observed between 8.00 am and 4.00 pm, with all schemes achieving close to 70%.

## 4.2 Overshadowing Impact on CBUS Development Communal Open Space

Through the ECOTECT model shadow diagrams were generated for each 15 minute interval between 9.00 am and 3.00 pm on the Winter Solstice (21 June). Based off council's assessment the "The open space of Tower 3 is already substantially overshadowed by the tower immediately above it" SLR has limited the assessed area to the landscaped area between towers 1 and 2. The referenced shadow diagrams are included in the following Appendices:

- **Appendix K** – Shadow Diagrams Existing surrounds to Tower 1 and 2
- **Appendix L** – Shadow Diagrams DA + Future Northern Development surrounds to Tower 1 and 2
- **Appendix M** – Shadow Diagrams ADG + Future Northern Development surrounds to Tower 1 and 2

Solar access to the landscaped area shared by towers 1 and 2 has been calculated and compared in **Table 3**. The 2 hour window that yielded the highest percentage of solar access is highlighted in each scenario.

**Table 3 Solar Access to Tower 1 and 2 Landscaped Area**

Time	Solar Access with Existing surrounds (%)	Solar Access with DA + Future Northern Development surrounds (%)	Solar Access with ADG + Future Northern Development surrounds (%)
0900	17.01%	17.01%	17.01%
0915	16.01%	16.01%	16.01%
0930	15.27%	15.27%	15.27%
0945	14.08%	13.74%	13.74%
1000	15.42%	12.93%	12.93%
1015	19.01%	12.96%	12.29%
1030	24.08%	16.62%	17.06%
1045	33.02%	24.05%	24.35%
1100	41.26%	29.70%	30.54%
1115	42.88%	29.91%	30.02%
1130	45.95%	31.09%	30.85%
1145	47.19%	31.12%	29.21%
1200	50.47%	32.59%	29.74%
1215	56.53%	33.87%	31.96%
1230	63.77%	34.20%	34.78%
1245	69.70%	35.14%	36.72%
1300	75.09%	39.34%	39.72%
1315	78.22%	41.98%	43.10%
1330	83.87%	46.35%	47.13%
1345	86.68%	47.65%	48.09%
1400	86.05%	45.86%	46.80%
1415	85.73%	44.09%	44.56%
1430	82.90%	40.88%	42.86%

Time	Solar Access with Existing surrounds (%)	Solar Access with DA + Future Northern Development surrounds (%)	Solar Access with ADG + Future Northern Development surrounds (%)
1445	80.42%	36.21%	37.33%
1500	74.37%	28.35%	29.49%

From **Table 3** the following conclusions can be drawn:

- Considering existing surrounds the Tower 1 and 2 landscaped area of the CBUS development will achieve solar access to greater than 74% of open area for 2 hrs.
- Considering the proposed DA + Future Northern Development surrounds the Tower 1 and 2 landscaped area of the CBUS development will achieve solar access to greater than 35% of open area for 2 hrs.
- Considering the ADG compliant DA + Future Northern Development surrounds the Tower 1 and 2 landscaped area of the CBUS development will achieve solar access to greater than 36% of open area for 2 hrs.

### 4.3 Solar Access to Proposed DA for 24-36 Langston Place

SLR has produced a further set of sun eye views from ECOTECT generated for each 15 minute interval between 9.00 am and 3.00 pm on the Winter Solstice (21 June), taking into account the CBUS and Future Northern development along with the proposed DA design to 24-36 Langston Place; these can be found in **Appendix N**.

Results for solar access to living rooms and private open spaces of apartments in the 24-36 Langston Place development on June 21 (winter solstice) between the hours of 9.00 am and 3.00 pm inclusive, were generated and summarised in the table below, detailed results can be found in **Appendices O**.

**Table 4 Solar Access Summary for 24-36 Langston Place DA Scheme between 9.00 am and 3.00 pm on June 21**

Number of Apartments	Percentage of Apartment living areas with at least 2hr of direct sunlight	Percentage of Apartment living areas with no direct sunlight
101	70.30% (71 of 101)	9.90% (10 of 101)

Based off **Table 4**, it is shown that the proposed development for 24-36 Langston Place will meet solar access requirements across June 21, between 9.00 am and 3.00 pm.

## 5 Discussion

### 5.1 Overshadowing Impact on CBUS Development Apartment Solar Access

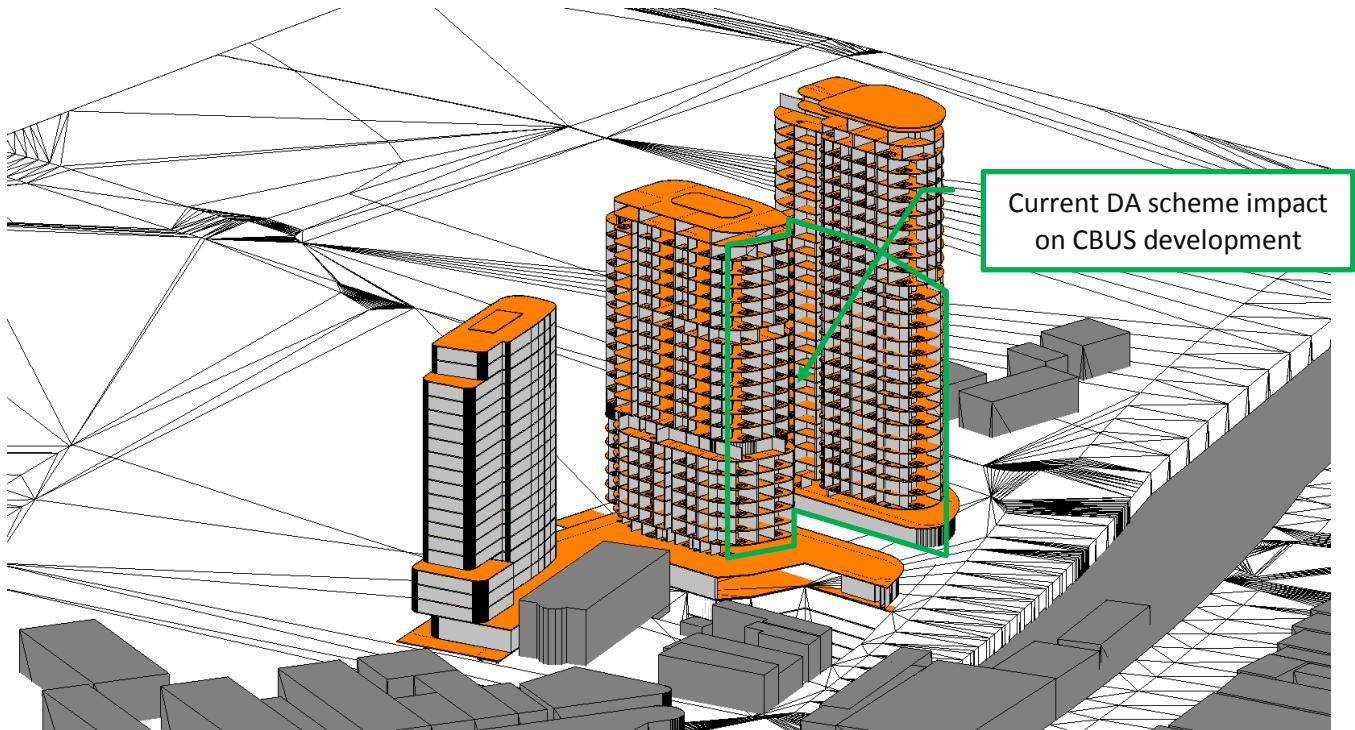
Based on the outlined results the following can be observed for the surrounding schemes assessed.

#### 5.1.1 Current DA Scheme

The current DA scheme will impact the Tower 2 and Tower 3 of the 12-22 Langston Place development, with shadows cast up to the 23<sup>rd</sup> floor, mainly to the western side of the development.

- The impact will result in a reduction of 54 apartments achieving the ADG 2hrs solar access criterion, which equates to an 11.8% reduction in solar Access to the CBUS site between 9.00 am and 3.00 pm.

Figure 4 Impact of Proposed DA 24-36 Langston Place

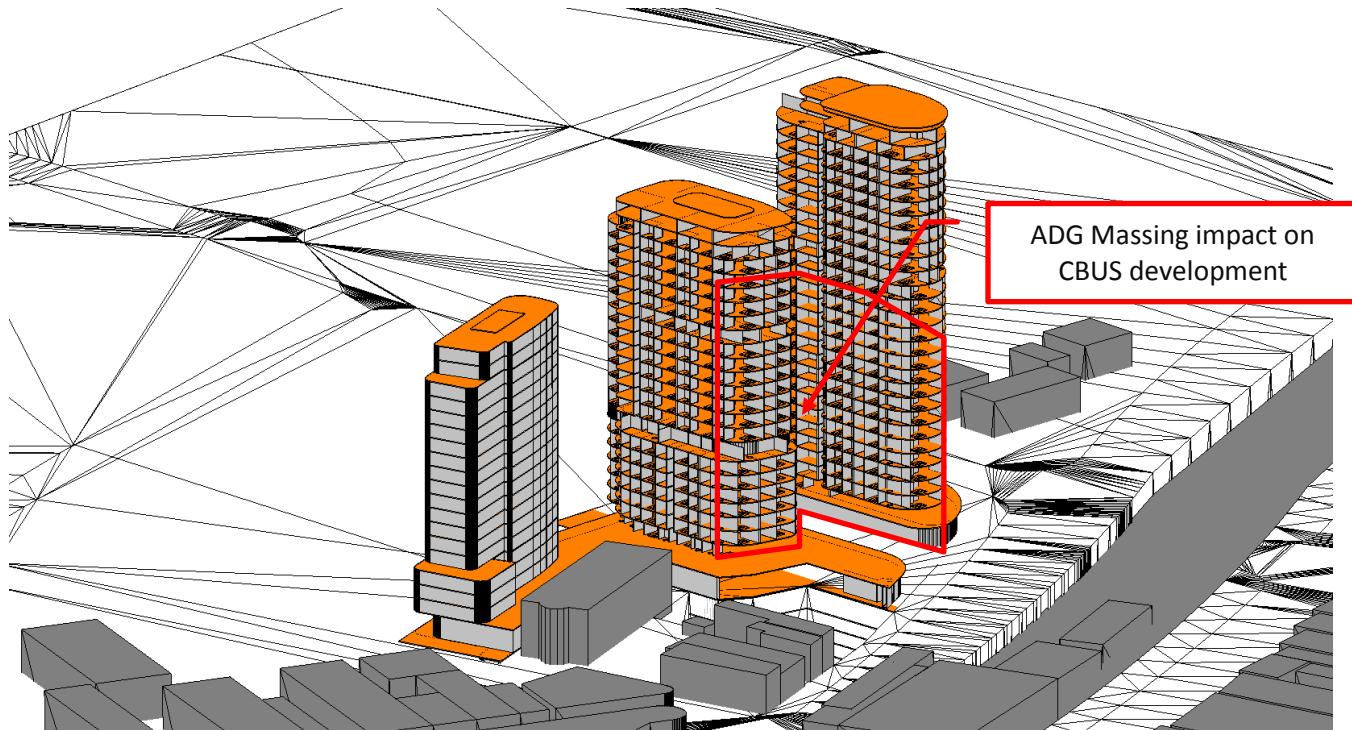


#### 5.1.2 ADG Massing

The ADG compliant massing will impact the Tower 2 and Tower 3 of the 12-22 Langston Place development, with shadows cast up to the 19<sup>th</sup> floor, mainly to the western side of the development.

- The impact will result in a reduction of 43 apartments achieving the ADG 2hrs solar access criterion, which equates to a 9.2% reduction in solar Access to the CBUS site between 9.00 am and 3.00 pm.

**Figure 5 Impact of ADG Compliant Massing 24-36 Langston Place**

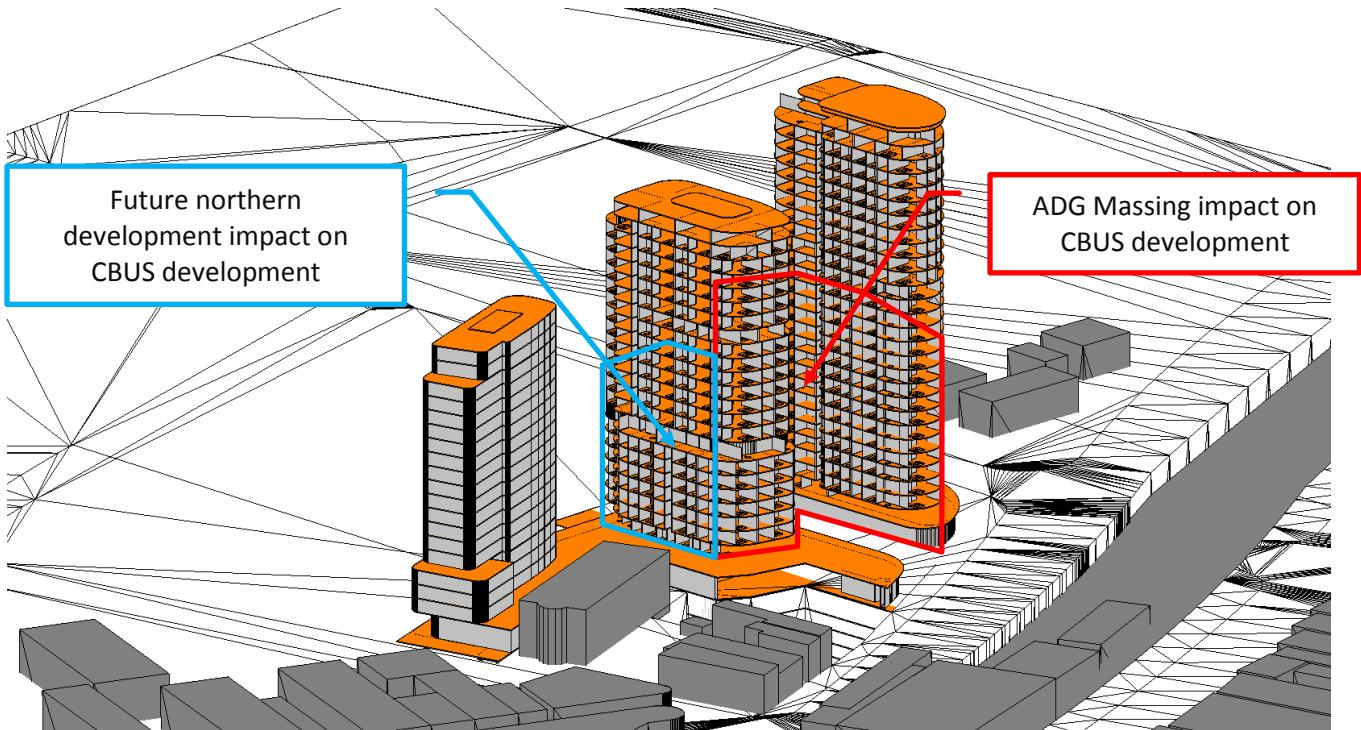


### 5.1.3 ADG Massing + Future Northern Development

In addition to the ADG compliant massing, the proposed future northern development will impact the Tower 2 of the 12-22 Langston Place development, with shadows cast up to the 19<sup>th</sup> floor, mainly to the western side of the development.

- The impact will result in a reduction of 58 apartments achieving the ADG 2hrs solar access criterion, which equates to a 12.5% reduction in solar Access to the CBUS site between 9.00 am and 3.00 pm.

Figure 6 Impact of ADG Compliant Massing 24-36 Langston Place + Future Northern Development



## 5.2 Overshadowing Impact on CBUS Development Communal Open Space

Based off the solar access assessment to the landscaped areas of the Tower 1 and 2, there was a significant reduction in direct sunlight to the space when accounting for future surrounds. However it would be unreasonable to assume the entirety of the space be proposed as communal open space, given this when assessing the shadow diagrams SLR noted the locations that were best suited across all scenarios. These can be seen in **Figure 7**.

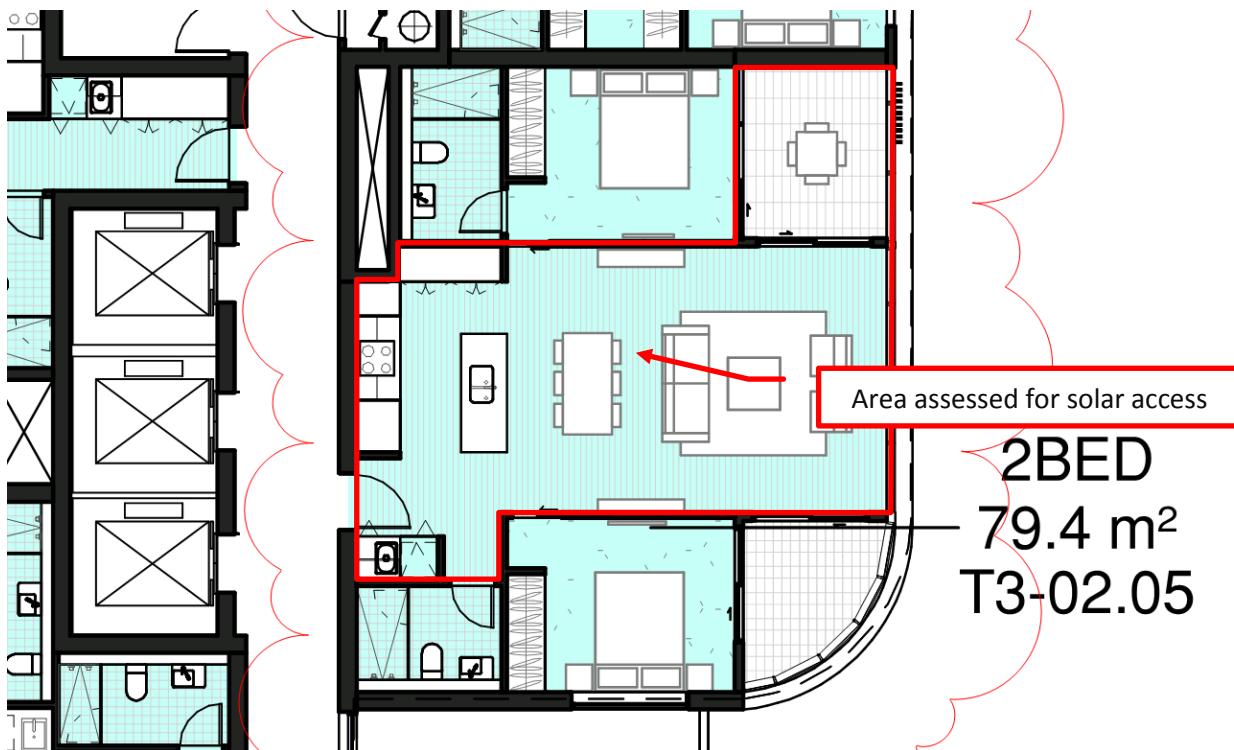
Figure 7 CBUS Tower 1 and 2 Communal Open Space



### 5.3 Solar Access to CBUS Development Apartment T3-02-05 and Similar

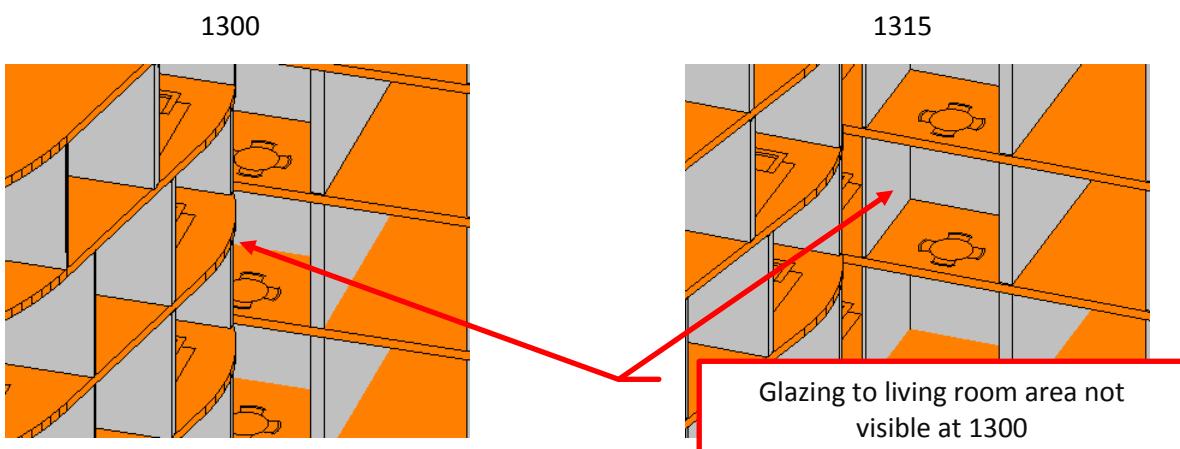
In assessing solar access to CBUS apartment T3-02-05 and similar, SLR has elected to assess solar access to one of the balconies along with the living room, rather than subjecting both balconies to the 2 hours solar access criterion.

**Figure 8 Area Assessed for Solar Access to T3-02-05**



In assessing solar access along the above guidelines the results for the relevant apartments have improved, however SLR has noted that apartments below level 19 are still impacted by the Tower 2 (T2) CBUS development building. Specifically the living room to the outlined apartments is obstructed from 9.00 am until after 1.00 pm, resulting in the apartment living room not achieving the required 2 hours solar access.

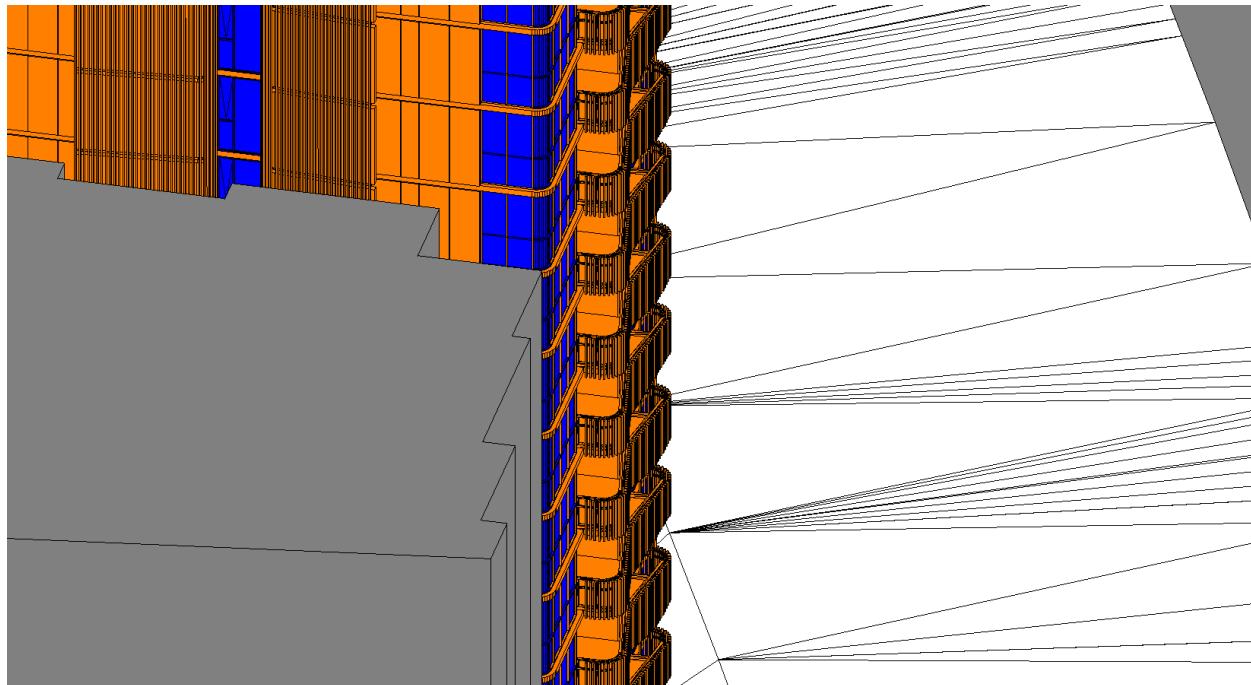
**Figure 9 Solar Access to Apartment T3-15-05 at 1300 and 1315**



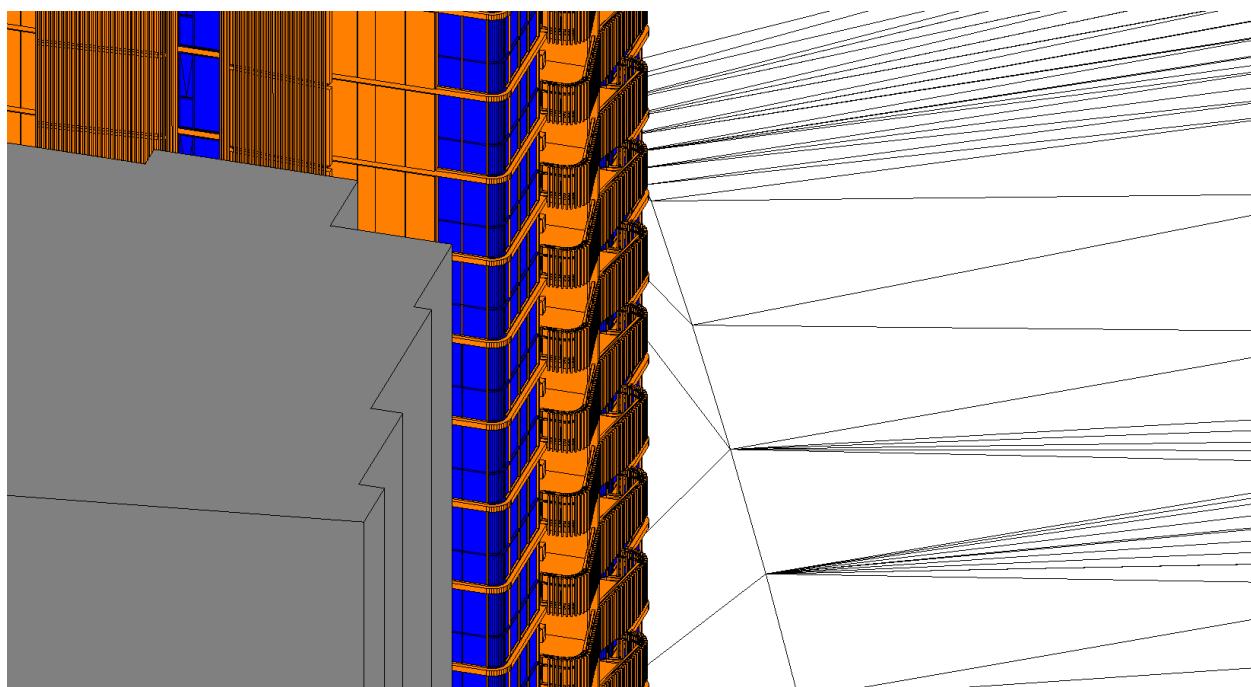
## 5.4 Solar Access to 24-36 Langston Place 804 and Similar

Sun eye views for the solar access to 24-36 Langston Place have been included in **Appendix N**, however for clarity regarding solar access to apartment 804 and similar, additional enhanced images have been outlined in **Figure 10** and **Figure 11**.

**Figure 10 Solar Access to 24-36 Langston Place at 1300**



**Figure 11 Solar Access to 24-36 Langston Place at 1315**



## 6 Conclusion

SLR Consulting Australia Pty Ltd (SLR) has been engaged by Langston R&J Pty Ltd (Langston R&J) to conduct a detailed solar access analysis for the site and surrounds of the proposed 24-36 Langston Place, Epping development. Specific attention is focused around the proposed site and surrounds impact upon the neighbouring CBUS development at 12-22 Langston Place.

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- In all other areas, living rooms and private open spaces of at least 70% of the apartments in a building receive a minimum of 3 hours direct sunlight between 9 am and 3 pm at mid-winter.
- A maximum of 15% of apartments in a building receive no direct sunlight between 9 am and 3 pm at mid-winter.

The ADG also outlines the following design guidance:

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From the model provided SLR has calculated the below summarised ADG assessed direct sunlight to residential apartment results for June 21, between the hours of 9.00 am and 3.00 pm, accounting for multiple relevant surrounding schemes:

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- Assessing solar access against surrounds for the current proposed DA design 24-36 Langston Place, SLR found that 56.2% (260 of 463) of apartments within the 12-22 Langston Place development would achieve 2hrs direct solar access.
  - The proposed current DA for 24-36 Langston Place will reduce solar access to 12-22 Langston Place by 11.8%.
- Assessing solar access against surrounds for the ADG compliant massing to 24-36 Langston Place, SLR found that 58.8% (272 of 463) of apartments within the 12-22 Langston Place development would achieve 2hrs direct solar access.
  - The ADG compliant massing for 24-36 Langston Place will reduce solar access to 12-22 Langston Place by 9.2%.
- Assessing solar access against surrounds for the ADG compliant massing to 24-36 Langston Place plus the future proposed northern development, SLR found that 55.5% (257 of 463) of apartments within the 12-22 Langston Place development would achieve 2hrs direct solar access.

- The ADG compliant massing for 24-36 Langston Place plus the future proposed northern development will reduce solar access to 12-22 Langston Place by 12.5%.

From the model provided SLR has also conducted an assessment of direct sunlight to residential apartments for June 21, between the hours of 8.00 am and 4.00 pm, finding the below:

- Assessing solar access solely to the 12-22 Langston Place development with no other future proposed surrounds, SLR found that 77.5% (359 of 463) of apartments within the 12-22 Langston Place development would achieve 2hrs direct solar access.
- Assessing solar access against surrounds for the current proposed DA design 24-36 Langston Place, SLR found that 68.9% (319 of 463) of apartments within the 12-22 Langston Place development would achieve 2hrs direct solar access.
- Assessing solar access against surrounds for the ADG compliant massing to 24-36 Langston Place, SLR found that 70.4% (326 of 463) of apartments within the 12-22 Langston Place development would achieve 2hrs direct solar access.
- Assessing solar access against surrounds for the ADG compliant massing to 24-36 Langston Place plus the future proposed northern development, SLR found that 67.1% (311 of 463) of apartments within the 12-22 Langston Place development would achieve 2hrs direct solar access.

In assessing solar access to the landscaped podium of Tower 1 and 2 for the CBUS development SLR noted the following:

- Considering existing surrounds the Tower 1 and 2 landscaped area of the CBUS development will achieve solar access to greater than 74% of open area for 2 hrs.
- Considering the proposed DA + Future Northern Development surrounds the Tower 1 and 2 landscaped area of the CBUS development will achieve solar access to greater than 35% of open area for 2 hrs.
- Considering the ADG compliant DA + Future Northern Development surrounds the Tower 1 and 2 landscaped area of the CBUS development will achieve solar access to greater than 36% of open area for 2 hrs.

With respect to solar access to 24-36 Langston Place when considering future surrounds SLR found the development will meet solar access requirements across June 21, between 9.00 am and 3.00 pm, with:

- 70.30% (71 of 101) of apartments achieving 2 hours solar access across June 21, between 9.00 am and 3.00 pm.
- 9.90% (10 of 101) of apartments achieving no solar access across June 21, between 9.00 am and 3.00 pm.

# APPENDIX A

Provided Drawings used in Assessments

DA1005



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Issue	Amendment	Date
E	ISSUE FOR DRAFT DA ISSUE	03/11/2015
E	ISSUE FOR INFORMATION	16/11/2015
F	DRAFT DA ISSUE	22/12/2015
G	FINAL DRAFT DA ISSUE	04/02/2016
H	FINAL DA ISSUE	11/02/2016
J	DA SUBMISSION	11/02/2016
K	DA SUBMISSION RESPONSE AMENDMENTS	24/02/2016
L	AMENDED DA SUBMISSION	27/02/2016
M	FOR INFORMATION	24/11/2016
N	DRAFT DA ISSUE	05/12/2016
O	AMENDED DA SUBMISSION	09/12/2016
P	AMENDED DA ISSUE	09/06/2017
Q	AMENDED DA SUBMISSION	09/06/2017

Unit Types		RL Schedule - Level 1	
		Level	RL
1BED		Level 1	107.35
1BED-S			
2BED			
2BED-S			

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project  
12-22 LANGSTON PLACE, EPPING

drawing  
Level 1 Floor Plan

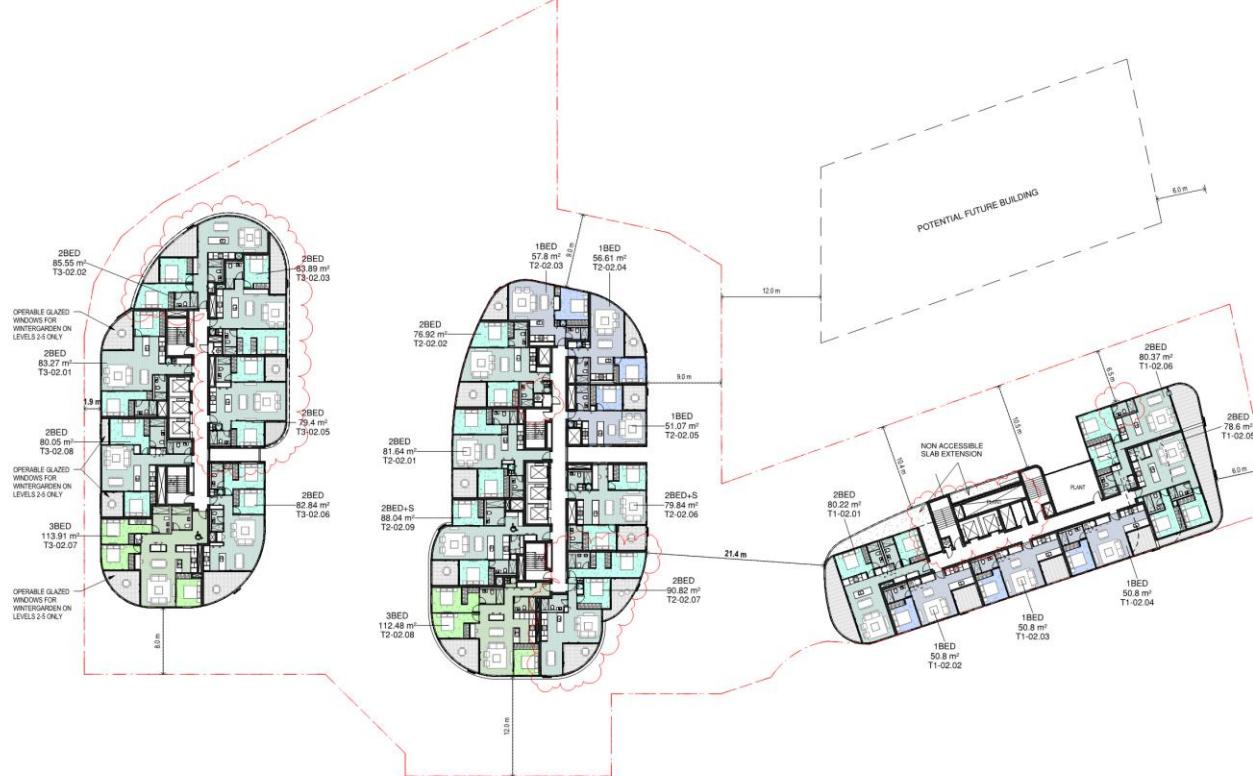
drawing no.  
DA1005  
issue  
Q

5/6/2017 7:27:29 PM

DA1006



DA1007



**Thermal comfort:**  
Glazing: Double glazing.  
External walls: Insulation thickness: 100mm. U-Value: 0.40 (up to or below roof) SHGC: 0.51 (10%). U-Value: 0.40 (up to or below roof) SHGC: 0.59 (10%).  
Aluminium framed box or clear glass at all other locations. U-Value: 0.40 (up to or below roof) SHGC: 0.63 (10%).  
Doors: Internal doors are PTFE. Solid external doors.  
**Roof:**  
Concrete roof no insulation. Default light colour  
Plasterboard ceiling: R2.0 insulation where exposed roof is above  
Note: No insulation required for plasterboard ceiling unless an assessor certifies  
Note: No insulation required for plasterboard ceiling unless an assessor certifies  
Note: Loss of ceiling insulation due to penetrations from down lights and recessed spotlights. Insulation must be replaced with BCA Technical Note J and assume non-ventilated LED down lights.

**External wall:**  
External walls with R1.5 insulation, furring channel, plasterboard  
lined internally  
External walls with R1.5 insulation, furring channel, plasterboard  
lined internally  
External walls with R1.5 insulation, furring channel, plasterboard  
lined internally  
**Internal Party walls:**  
Internal party walls with R1.2 (20mm) insulation to consider  
walls - no requirement for insulation between neighbour  
Note: No insulation required to fit draft and fire stairs walls with R1.2 (20mm) insulation.  
Note: No insulation required to fit draft and fire stairs walls with R1.2 (20mm) insulation.  
**Walls with in dwellings:**  
Plasterboard on studs - no insulation  
**Floors:**  
Floors between levels no insulation  
Concrete - suspended open slab with an R1.2 insulation as per  
BCA Technical Note I  
**Floor coverings:**  
Carpet in bedrooms, tiles in bathrooms and laundry. Timber to living  
**Central rainwater storage:**  
Rainwater tank: Rainwater tank from 1200L rain area can be collected from T1 & T2 roof tops. Connected to outdoor tap for irrigation of all landscaping areas.  
**Fire sprinkler systems:**  
Fire sprinkler test water to be contained in a closed system  
**Hot water system:**  
Hot water system: Hot water with R3.0 (25mm) insulation to ring main and supply pipes

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D	AMENDMENT FOR C	23/10/2015
E	DRAFT DA ISSUE	23/10/2015
F	AMENDED DA ISSUE	23/10/2015
G	FINAL DRAFT DA ISSUE	04/02/2016
I	DA SUBMISSION	09/02/2016
K	DA SUBMISSION RESPONSE AMENDMENTS	10/02/2016
Z	AMENDED DA ISSUE	24/02/2016
L	DRAFT DA ISSUE	25/11/2016
M	AMENDED DA ISSUE	25/11/2016
N	AMENDED PI PLAN SUBMISSION	03/02/2017
P	AMENDED DA SUBMISSION	05/02/2017

Unit Types		
1BED	Level	RL
2BED	Level 2	110.40
2BED+S	Level 3	113.45
3BED		

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drawn AR/NR/MC/PL/HN project no. 140309.00  
drawing no. DA1006 issue P  
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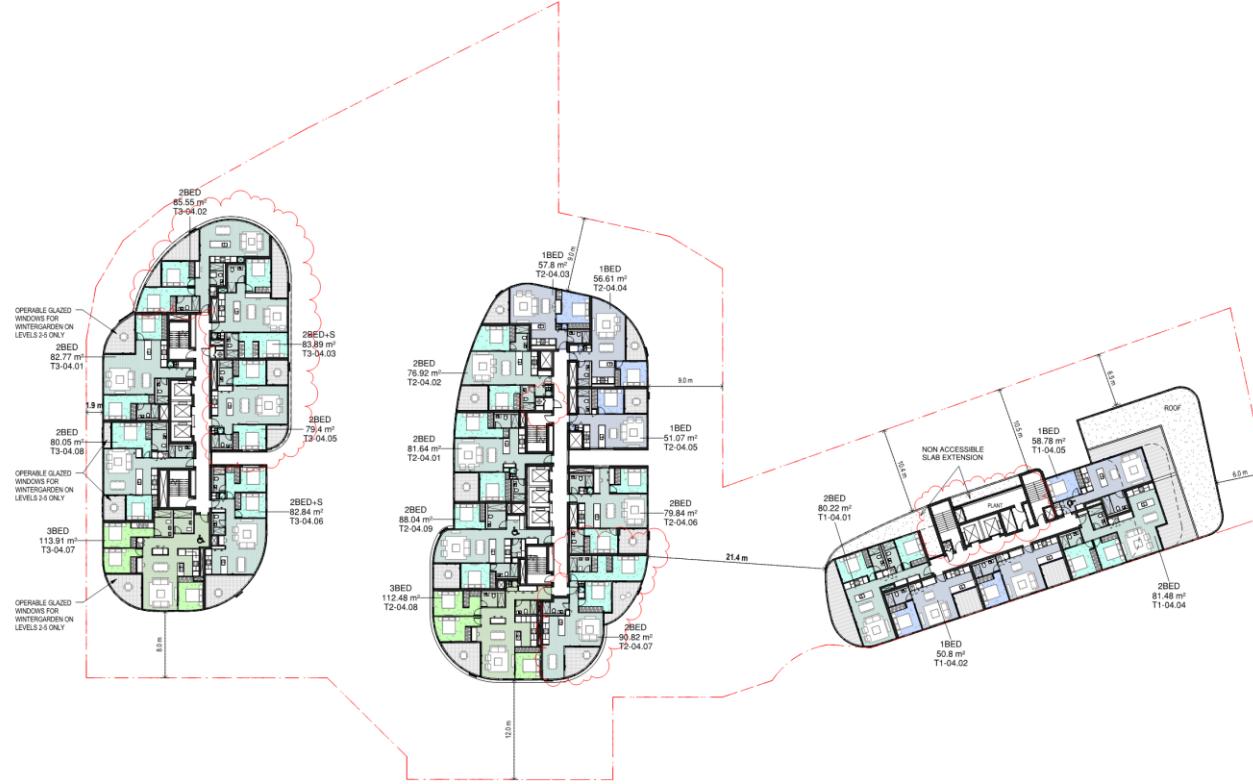
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12-22 LANGSTON PLACE, EPPING

Levels 2-3 Floor Plan

SLR

DA1008



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Unit Types	RL Schedule - Level 4	
	Level	RL
1BED		
2BED	Level 4	116.50
2BED+S		
3BED		

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project

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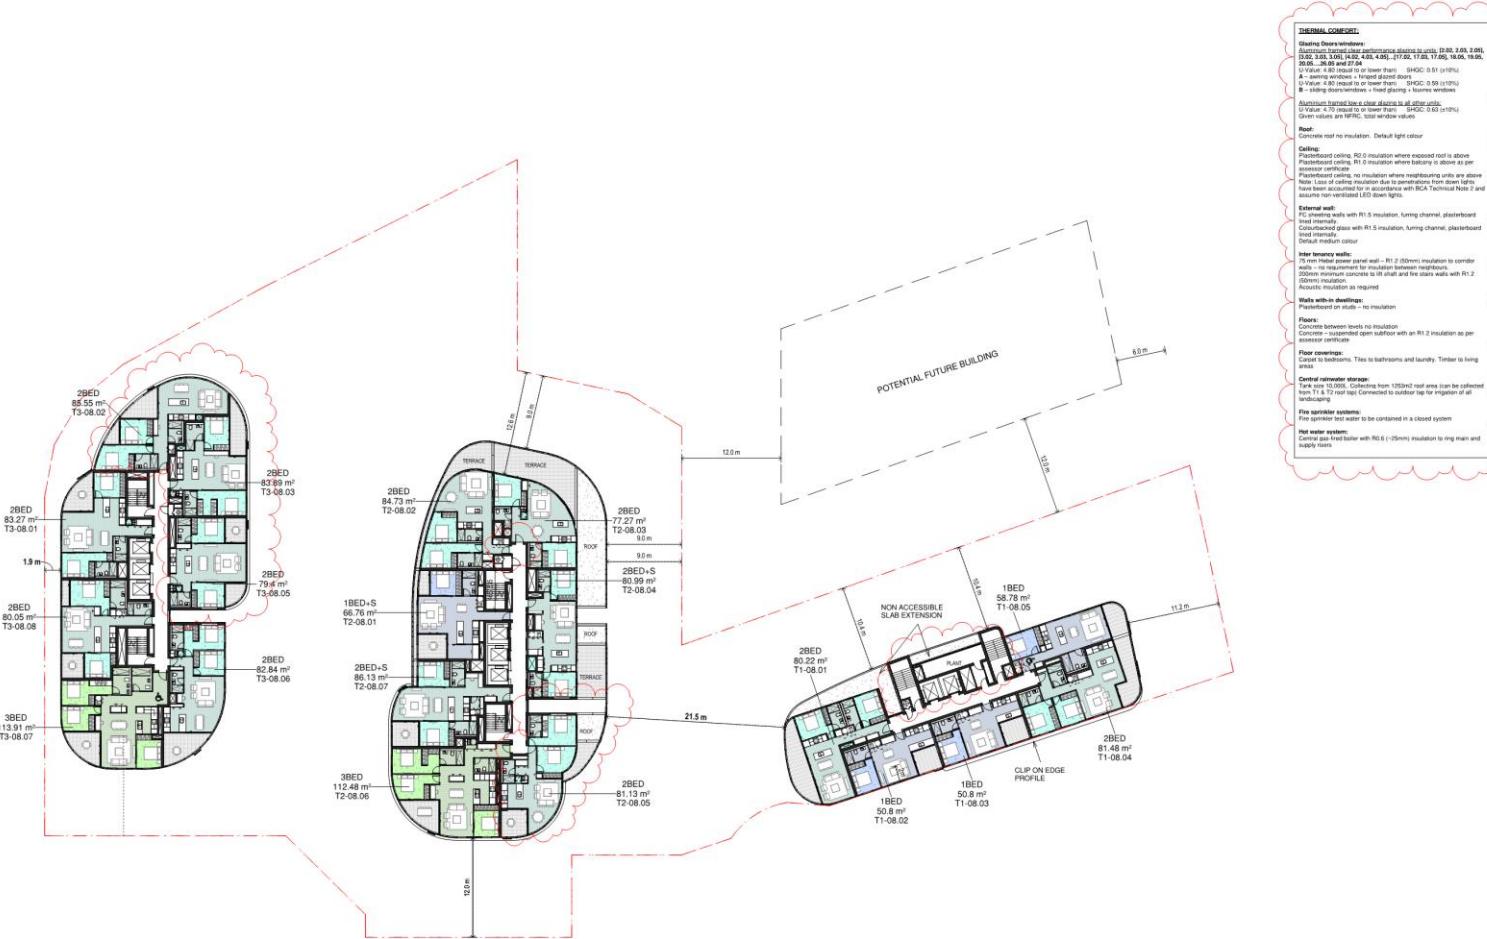
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B	DRAFT DA ISSUE	22/01/2015
C	FINAL DRAFT DA ISSUE	30/03/2015
D	DA SUBMISSION	24/03/2015
E	DA SUBMISSION - RESPONSE AMENDMENTS	11/05/2015
F	FOR INFORMATION	24/11/2014
G	DRAFT DA ISSUE	29/11/2014
H	DRAFT DA ISSUE	03/12/2014
I	AMENDED DA AN SUBMISSION	03/03/2015
J	AMENDED DA AN SUBMISSION	03/03/2015
K	AMENDED DA SUBMISSION	06/04/2015

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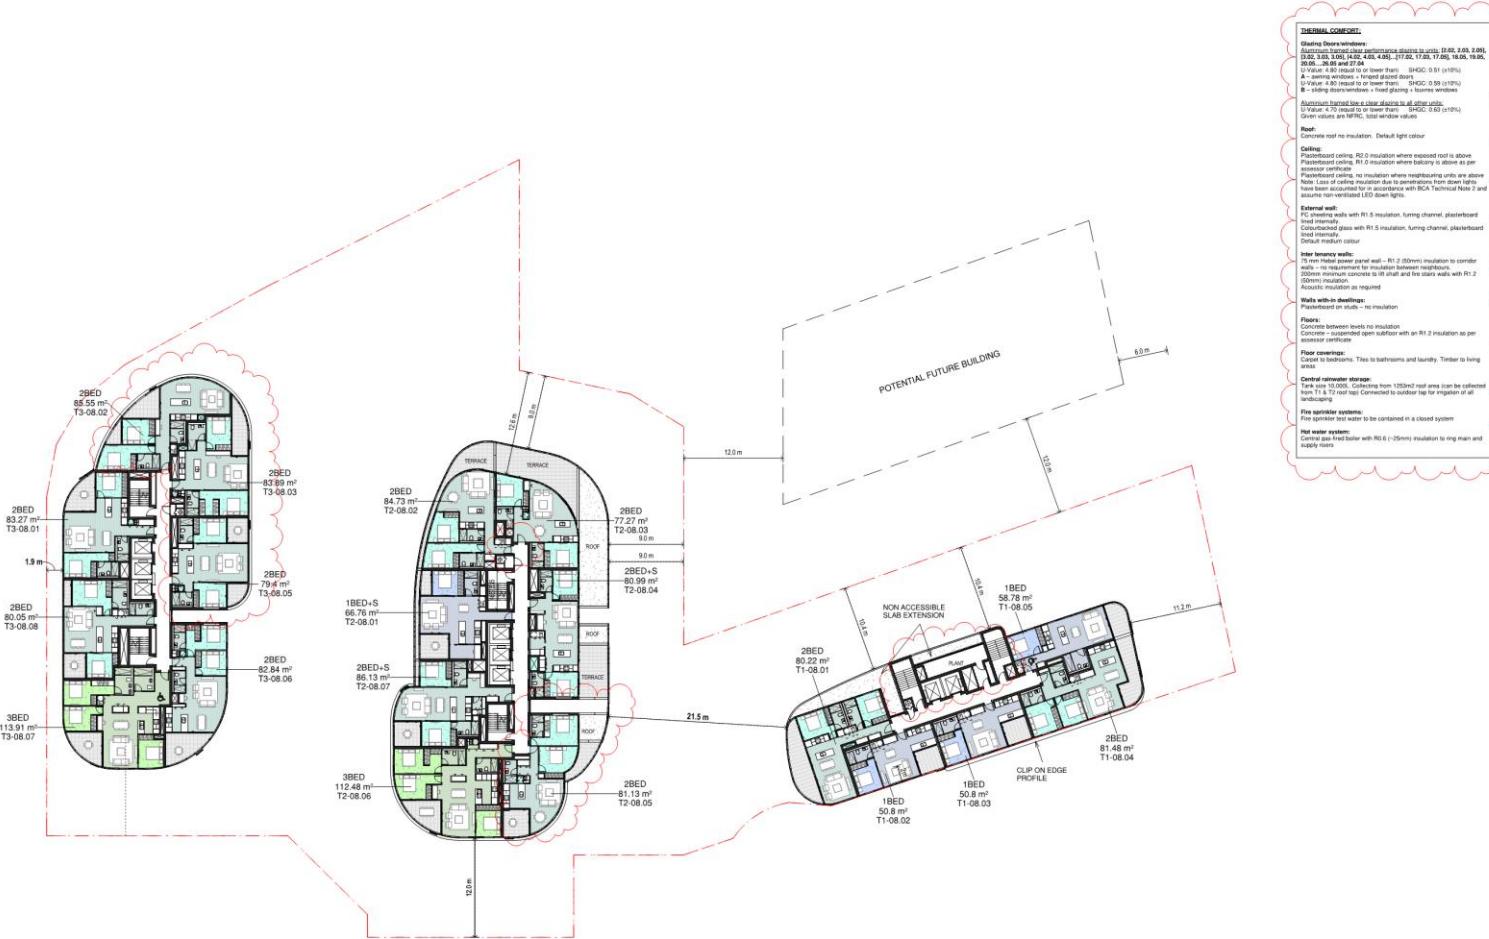
Project: 12-22 LANGSTON PLACE, EPPING

drawing: Level 8 Floor Plan

drawing no.: DA1009

issue: K



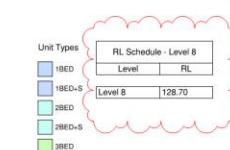


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A	DRAFT DA ISSUE	22/12/2018
B	DRAFT DA ISSUE	22/12/2018
C	AMENDED DA ISSUE	04/01/2019
D	DA ISSUE	08/02/2019
E	DA SUBMISSION	11/02/2019
F	AMENDED DA RESPONSE AMENDMENTS	24/02/2019
G	FOR INFORMATION	24/02/2019
H	DRAFT DA ISSUE	25/11/2019
I	DRAFT DA ISSUE	30/11/2019
J	AMENDED DA ISSUE	03/12/2019
K	AMENDED DA SUBMISSION	05/04/2020



AMENDED DA ISSUE

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project.

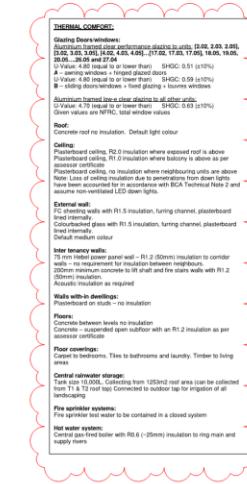
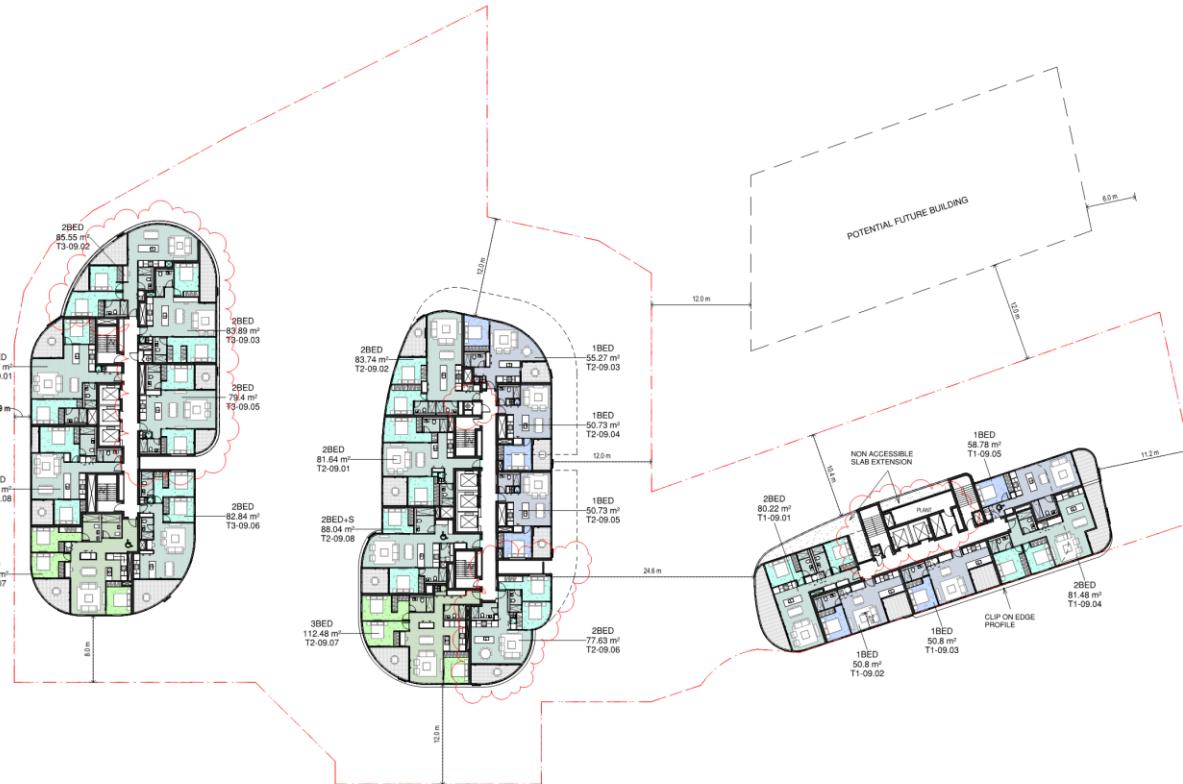
Level 8 Floor Plan

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drawing no. \_\_\_\_\_ issue no. \_\_\_\_\_

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B	ISSUE FOR INFORMATION	16/10/2012
C	FOR INFORMATION	21/10/2012
D	ISSUES FOR Q5	03/11/2012
E	FOR INFORMATION	23/11/2012
F	DRAFT DA ISSUE	22/01/2013
G	DRAFT DA ISSUE	04/02/2013
H	DA ISSUE	05/02/2013
I	DA SUBMISSION	11/02/2013
J	FOR INFORMATION	14/02/2013
K	FOR INFORMATION	24/11/2014
L	FOR INFORMATION	25/11/2014
M	DRAFT DA ISSUE	03/12/2014
N	AMENDED DA SUBMISSION	05/06/2017
O	AMENDED DA SUBMISSION	05/06/2017

Unit Types		RL Schedule - Level 9	
		Level	RL
■	1BED		
■	2BED		
■	2BED+S		
■	3BED		
		Level 9	131.75

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checked: FH scale: 1:2500/A1  
drawn: AR/NR/MC-PL/HN project no: 140309.00  
drawing no.: DA1010 issue: O

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12-22 LANGSTON PLACE, EPPING

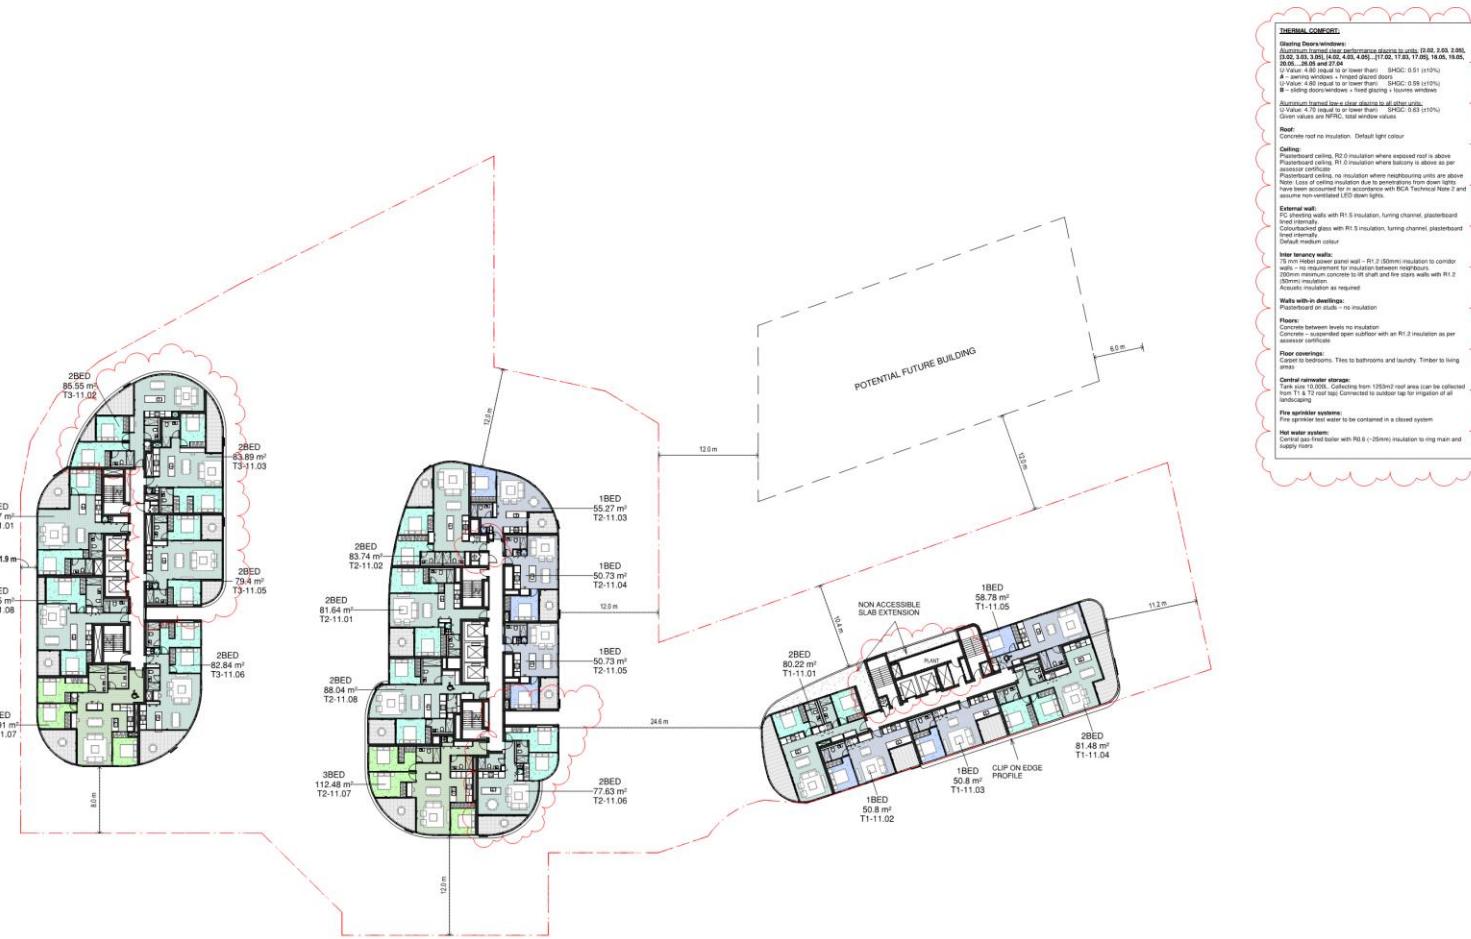
drawing:

Level 9 Floor Plan

drawing no. issue

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C	ISSUE FOR INFORMATION	21/10/2015
D	ISSUE FOR INFORMATION	03/11/2015
E	DRAFT DA ISSUE	22/12/2015
F	DRAFT DA ISSUE	22/01/2016
G	DRAFT DA ISSUE	22/01/2016
H	DA ISSUE	08/02/2016
I	DA SUBMISSION	11/02/2016
J	AMENDED DA SUBMISSION - RESPONSE AMENDMENTS	11/02/2016
K	FOR INFORMATION	24/01/2016
L	DRAFT DA ISSUE	25/01/2016
M	DRAFT DA ISSUE	02/02/2016
N	AMENDED DA SUBMISSION	03/02/2016
O	AMENDED DA SUBMISSION	05/06/2017



Unit Type

Unit Types	RL Score
1BED	Level 1
2BED	Level 1
3BED	Level 1
	Level 1

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12-22 LANGSTON PLACE, EPPING

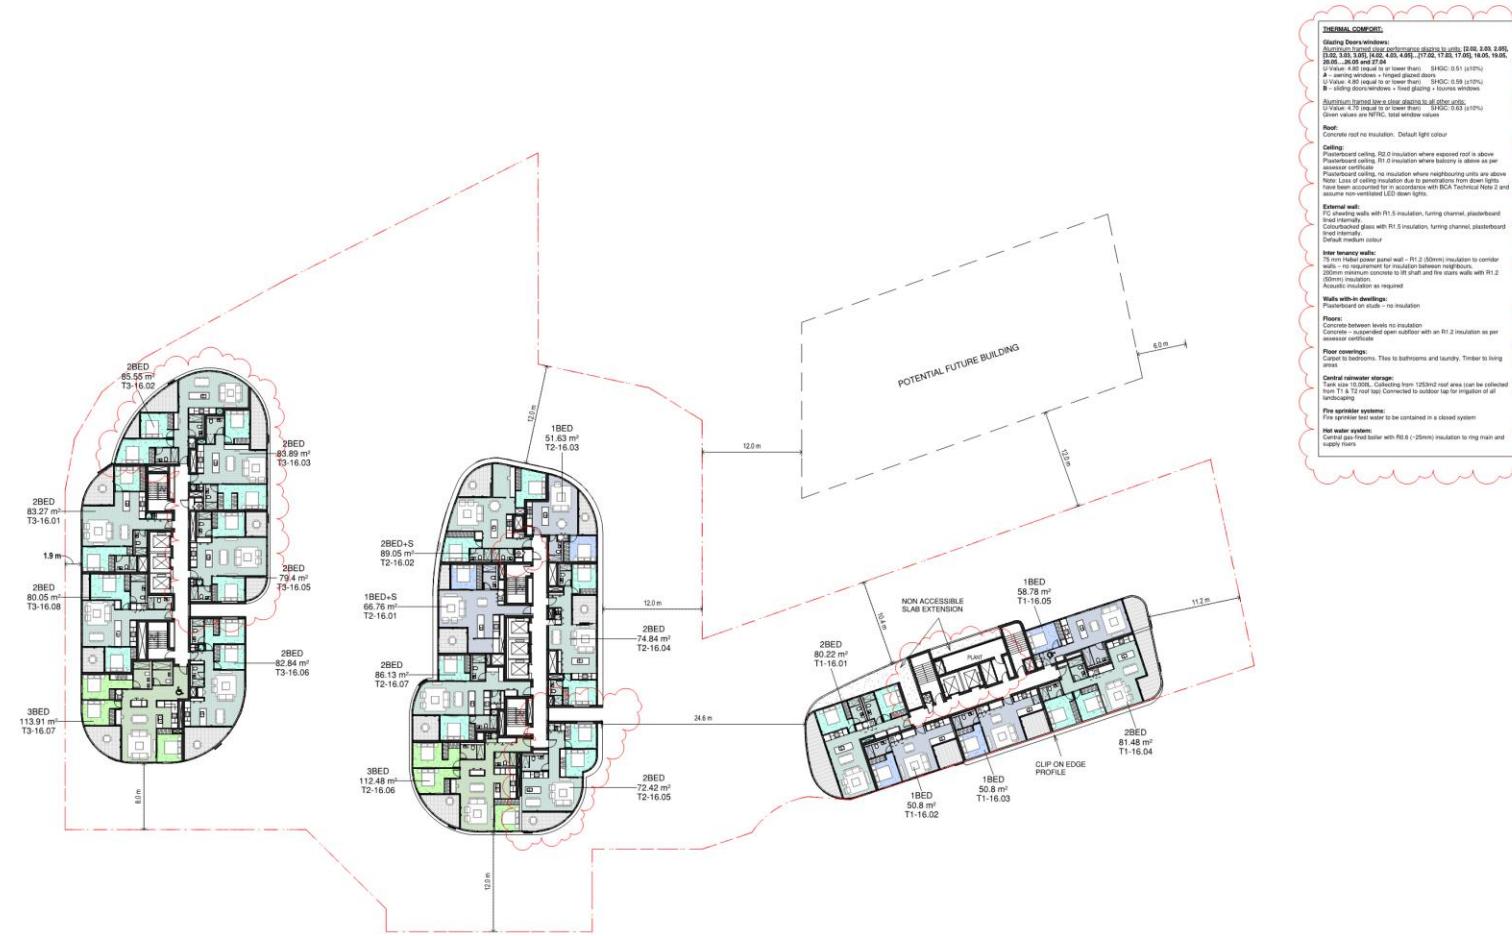
Levels 11-15 Floor Plans

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issue	amendment	date
A	DRAFT DA ISSUE	23/11/2000
B	DRAFT DA ISSUE	22/01/2001
C	AMENDMENT TO DA ISSUE	04/02/2001
D	DA ISSUE	04/02/2001
E	DA SUBMISSION	11/02/2001
F	DA SUBMISSION RESPONSE AMENDMENTS	04/03/2001
G	DA SUBMISSION	04/03/2001
H	DRAFT DA ISSUE	25/11/2001
I	DRAFT DA ISSUE	01/07/2002
J	AMENDED DA PLAN SUBMISSION	03/03/2003
K	AMENDED DA SUBMISSION	05/06/2003



Unit Test

Unit Types

A legend box containing four entries: '1BED+S' with a blue square, '2BED' with a light green square, '2BED+S' with a light green square, and '3BED' with a lime green square.

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project  
12-22 LANGSTON PLACE, EPPING

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drawing

Level 16 Floor Plan

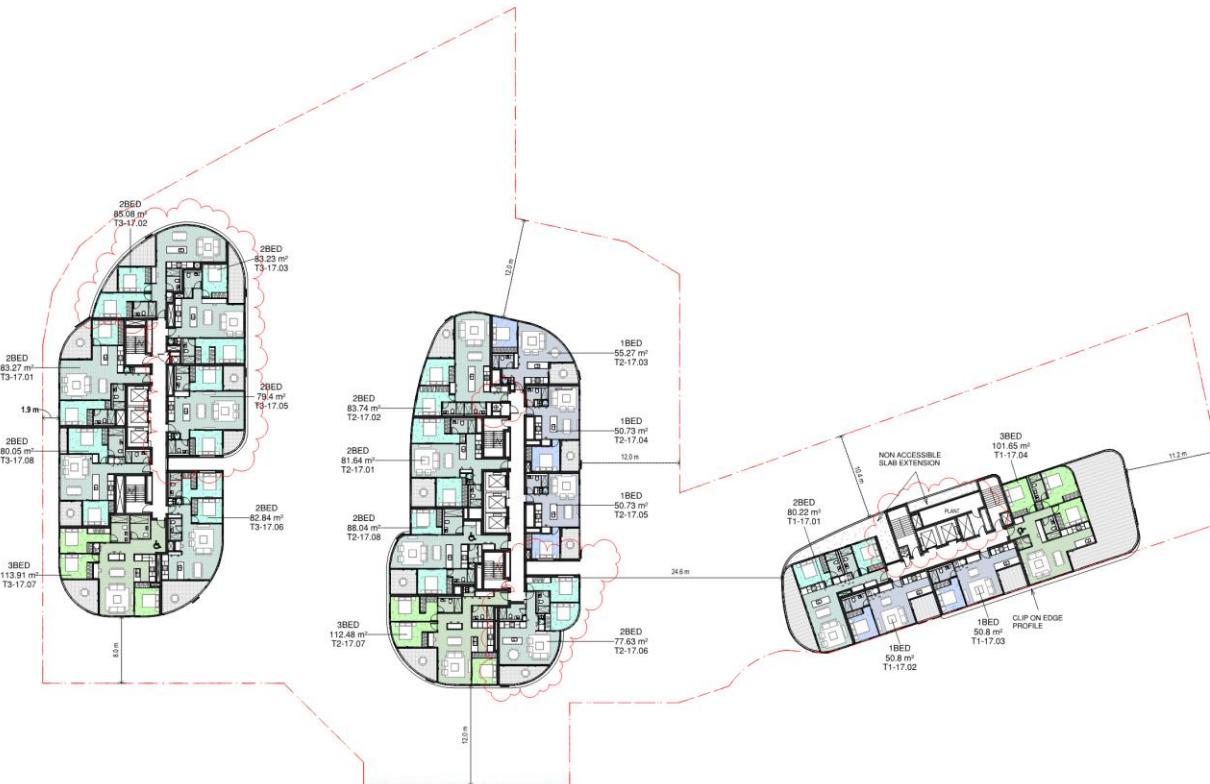
drawing no. 00000

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issue	amendment	date
B	ISSUE FOR INFORMATION	16/01/2011
C	ISSUE FOR INFORMATION	21/11/2010
D	AMENDED DRAFT ISSUE	08/02/2011
E	DRAFT DA ISSUE	22/11/2010
F	DRAFT DA ISSUE	20/01/2011
G	PROPOSED DRAFT DA ISSUE	08/02/2011
H	DA ISSUE	08/02/2011
I	DA SUBMISSION	11/02/2011
J	AMENDED DA SUBMISSION	11/02/2011
K	FOR INFORMATION	34/11/2010
L	DRAFT DA ISSUE	25/11/2010
M	AMENDED DRAFT DA ISSUE	03/02/2011
N	AMENDED DA SUBMISSION	03/02/2011
O	AMENDED DA SUBMISSION	05/06/2011



Unit Types	RL Schedule - Level 17	
	Level	RL
1BED		
2BED	Level 17	156.15
3BED		

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project

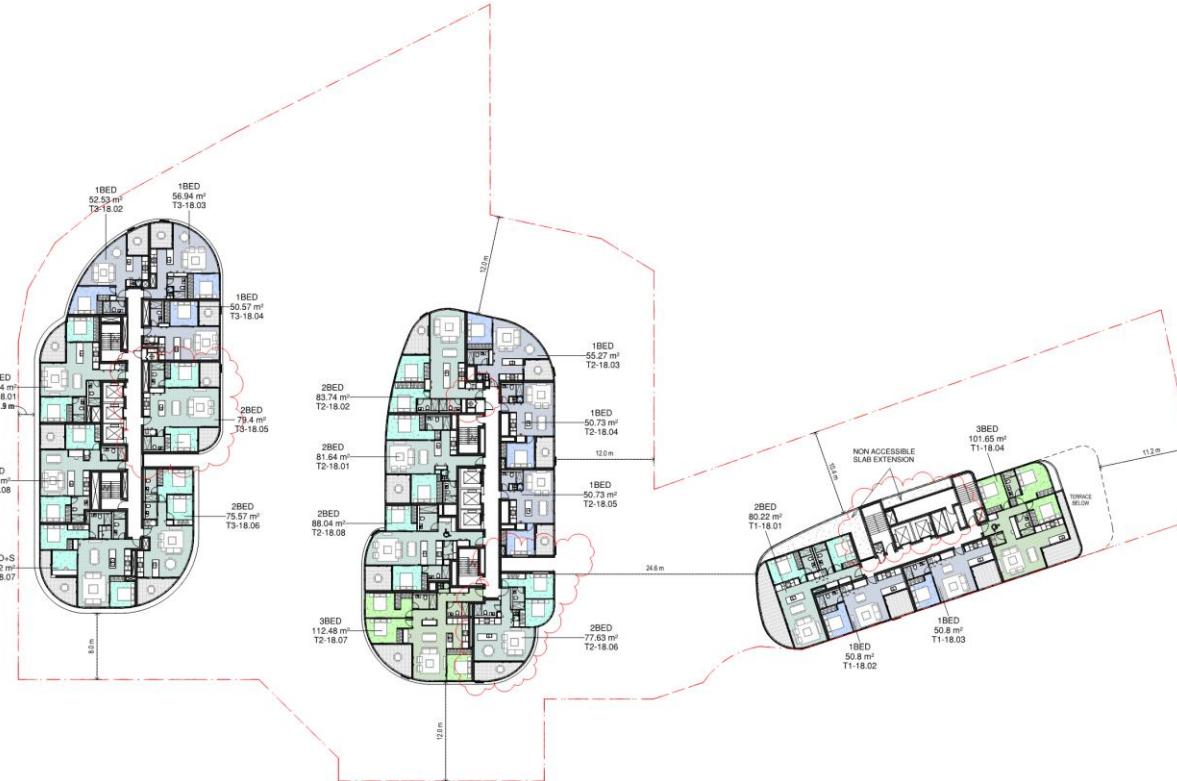
## GSTON PLACE, EPPING

卷之三

9

SLR

DA1015



**THERMAL COMFORT:**  
Glazing: Double glazing.  
External walls: Plasterboard ceiling, R2.0 insulation where eaves roof is above. No requirement for insulation between external wall and internal wall. Assessor certificate: No. Loss of ceiling insulation due to penetrations from down lights. Assume no insulation between external wall and internal wall with BCA Technical Note 2 and assume no ventilation LED down lights.

**Roof:** Concrete no insulation. Default light colour.

**External wall:** Plasterboard ceiling, R2.0 insulation where eaves roof is above. No requirement for insulation between external wall and internal wall. Assessor certificate: No. Loss of ceiling insulation due to penetrations from down lights. Assume no insulation between external wall and internal wall with BCA Technical Note 2 and assume no ventilation LED down lights.

**Internal wall:** Internal walls with R1.5 insulation, tiling channel, plasterboard. Insulation: No insulation. Internal glass with R1.5 insulation, tiling channel, plasterboard. Insulation: No insulation. Internal colour: No insulation required.

**Inter tenancy walls:** Internal walls - R1.2 20mm insulation to render with - no requirement for insulation between internal walls and the start walls with R1.2 (Gypsum) insulation.

**Floors:** Between levels no insulation. Concrete - suspended open slab with an R1.2 insulation as per BCA Technical Note 2.

**Floor coverings:** Carpet to bedrooms, Tiles to bathrooms and laundry, Timber to living areas.

**Central rainwater storage:** Rainwater tank with R2.0 insulation from T1 & T2 roof tops. Connected to outdoor tap for irrigation of all areas.

**Fire sprinkler system:** Fire sprinkler test water to be contained in a closed system.

**Hot water system:** Hot water cylinder with R0.6 (-25mm) insulation to ring main and supply lines.

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B	ISSUE FOR INFORMATION	16/10/2014
C	ISSUE FOR INFORMATION	21/10/2014
D	ISSUE FOR GS	23/11/2014
E	AMENDED DA ISSUE	22/01/2015
F	DRAFT DA ISSUE	22/01/2014
G	AMENDED DA ISSUE	24/02/2014
H	DA ISSUE	14/02/2014
I	DA SUBMISSION	11/02/2014
J	DA SUBMISSION AMENDMENTS	27/02/2014
K	FORM INFORMATION	24/11/2014
L	DA SUBMISSION	25/11/2014
M	DRAFT DA ISSUE	30/11/2014
N	AMENDED DA SUBMISSION	28/02/2014
O	AMENDED DA SUBMISSION	05/06/2017

Unit Types		RL Schedule - Level 18	
Level	RL	Level	RL
1BED		1BED	
2BED		2BED	
2BED-S		2BED-S	
3BED		3BED	

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12-22 LANGSTON PLACE, EPPING

drawing

Level 18 Floor Plan

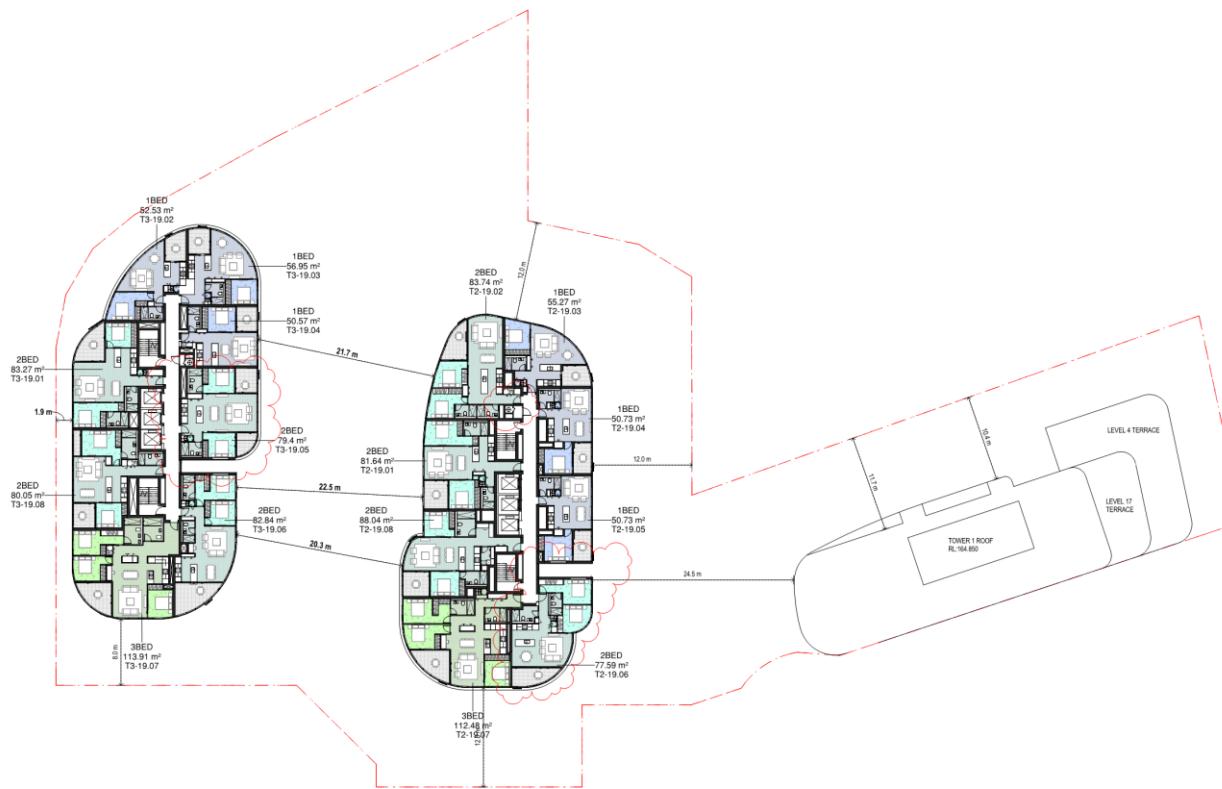
drawing no.

DA1015

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DA1016



**THERMAL COMFORT:**  
Glazing: Double glazing.  
Plasterboard ceiling: R2.0 insulation where eaves roof is above (24.00, 3.03, 3.05, 3.02, 3.03, 3.05, 4.02, 4.03, 4.05, 4.06, 4.07, 4.08, 17.05, 18.05, 18.06, 19.05, 19.06, 19.07).  
U-Value = 0.85 (ceil to or lower than) SH2C: 0.13 (10%)  
U-Value = 0.80 (ceil to or lower than) SH2C: 0.09 (10%)  
U-Value = 0.80 (ceil to or lower than) SH2C: 0.09 (10%)  
Aluminum framed have a clear glazing to all other units.  
U-Value = 0.70 (ceil to or lower than) SH2C: 0.03 (10%)  
U-Value = 0.70 (ceil to or lower than) SH2C: 0.03 (10%)

**Roof:**  
Concrete roof no insulation. Default light colour.

**External wall:**  
Plasterboard ceiling, R2.0 insulation where eaves roof is above (24.00, 3.03, 3.05, 3.02, 3.03, 3.05, 4.02, 4.03, 4.05, 4.06, 4.07, 4.08, 17.05, 18.05, 18.06, 19.05, 19.06, 19.07).  
Note: Loss of ceiling insulation due to penetrations from down lofts and assume non-ventilated LED down lights.

**External wall:**  
Brick walls with R1.5 insulation, tiling channel, plasterboard  
Brick internally  
Brick externally  
Brick internally  
Brick externally  
Brick internally  
Brick externally

**Inter tenancy walls:**  
Brick walls with R1.5 insulation - T1 & T2 20mm insulation to render  
with = no requirement for insulation between the brick walls and the start walls with R1.2 (20mm) insulation.  
Note: Loss of ceiling insulation due to penetrations from down lofts and assume non-ventilated LED down lights.

**Walls within dwellings:**  
Plasterboard or stud - no insulation.

**Floors:**  
Concrete - suspended open slab with an R1.2 insulation as per BCA Technical Note 2.

**Floor coverings:**  
Carpet to bedrooms, Tiles to bathrooms and laundry, Timber to living areas.

**Central rainwater storage:**  
Central rainwater tank (1250L) and area can be collected from T1 & T2 roof tops. Connected to outdoor tap for irrigation of all external areas.

**Fire sprinkler system:**  
Fire sprinkler test water to be contained in a closed system.

**Hot water system:**  
Hot water cylinder and boiler with R0.6 (-25mm) insulation to ring main and supply mains.

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C	ISSUE FOR INFORMATION	17/10/2014
D	ISSUE FOR GS	33/11/2014
E	AMENDED DA ISSUE	22/01/2015
F	DRAFT DA ISSUE	22/01/2015
G	AMENDED DA ISSUE	24/02/2015
H	DA ISSUE	24/02/2015
I	AMENDED DA ISSUE	24/02/2015
J	DA SUBMISSION	11/03/2015
K	FOR INFORMATION	24/11/2014
L	AMENDED DA SUBMISSION	25/03/2015
M	DRAFT DA ISSUE	30/11/2014
N	AMENDED DA SUBMISSION	25/03/2015
O	AMENDED DA SUBMISSION	30/06/2017

Unit Type	RL Schedule - Level 19
1BED	Level RL
2BED	Level 19   162.25
3BED	

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12-22 LANGSTON PLACE, EPPING

drawing

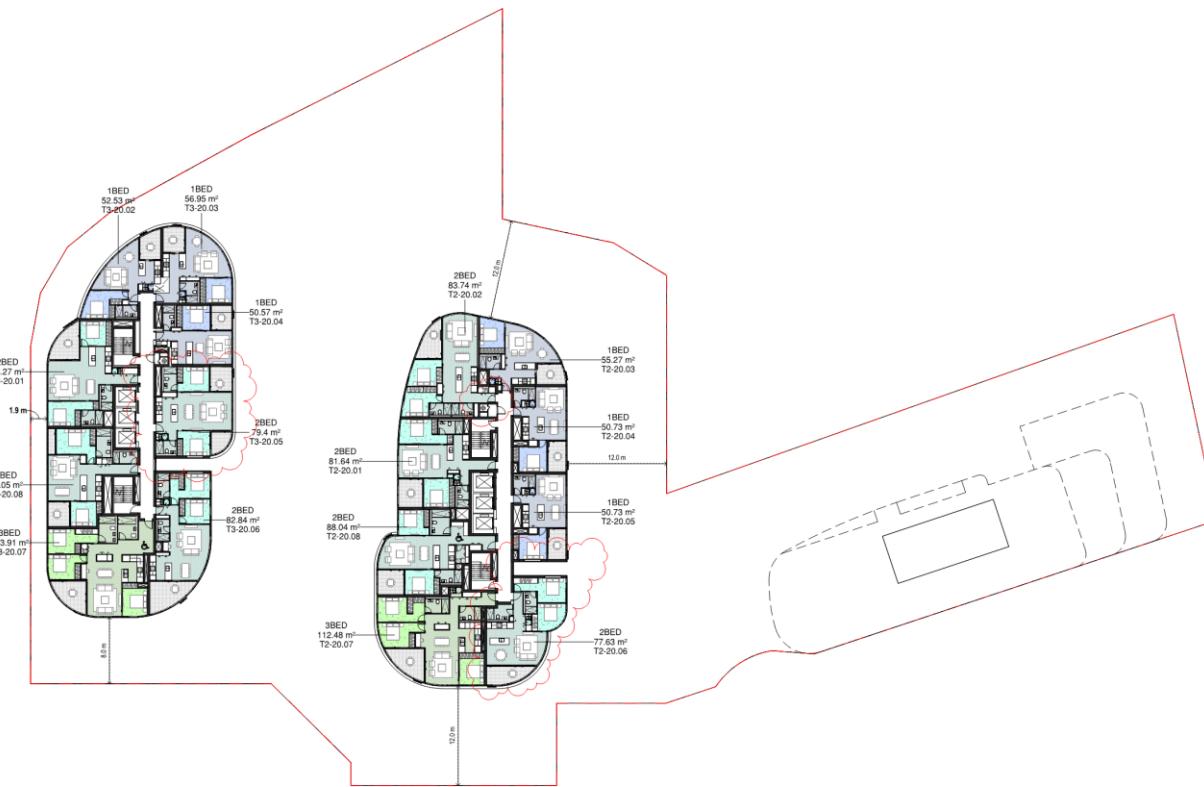
Levels 19 Floor Plan

drawing no. issue

DA1016

O

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**THERMAL COMFORT:**  
Glazing: Double glazing.  
External wall: Plasterboard ceiling, R2.0 insulation where eaves roof is above. No insulation where neighbours ceiling is above. U-Value = 0.85 (ceil to or lower than) SH2C: 0.13 (10%)  
U-Value = 0.85 (ceil to or lower than) SH2C: 0.13 (10%)  
U-Value = 0.85 (ceil to or lower than) SH2C: 0.13 (10%)  
Aluminum framed have a clear glazing to all other units.  
U-Value = 0.70 (ceil to or lower than) SH2C: 0.13 (10%)  
U-Value = 0.70 (ceil to or lower than) SH2C: 0.13 (10%)  
**Roof:**  
Concrete roof no insulation. Default light colour  
Plasterboard ceiling, R2.0 insulation where eaves roof is above. No insulation where neighbours ceiling is above. U-Value = 0.85 (ceil to or lower than) SH2C: 0.13 (10%)  
No loss of ceiling insulation due to penetrations from down lights. Assume non-ventilated LED down lights.  
**External wall:**  
External walls with R1.5 insulation, tiling channel, plasterboard  
Island internally  
External glass with R1.5 insulation, tiling channel, plasterboard  
Island internally  
Default light colour  
**Inter tenancy walls:**  
External walls - RH 2.0mm insulation to render  
RH = requirement for insulation thermal bridge  
RH = requirement for insulation thermal bridge  
RH = requirement for insulation thermal bridge  
**Walls within dwellings:**  
Plasterboard or stud - no insulation  
**Floors:**  
Concrete between levels no insulation  
Concrete - suspended open slabfloor with an R1.2 insulation as per  
**Floor coverings:**  
Carpet to bedrooms, Tiles to bathrooms and laundry, Timber to living  
**Central rainwater storage:**  
Rainwater tank with a capacity from 1250m<sup>3</sup> and area from the collected from T1 & T2 roof tops. Connected to outdoor tap for irrigation of all  
**Fire sprinkler system:**  
Fire sprinkler test water to be contained in a closed system  
**Hot water system:**  
Hot water cylinder and boiler with R6.0 (-25mm) insulation to ring main and supply lines

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D	ISUE FOR GS	33/11/2014
E	ISUE FOR GS	23/12/2014
F	DRAFT DA ISSUE	22/01/2015
G	AMENDED DA ISSUE	24/01/2015
H	DA ISSUE	14/02/2015
I	DA SUBMISSION	11/03/2015
J	DA SUBMISSION	12/03/2015
K	FOR INFORMATION	24/11/2014
L	FOR INFORMATION	25/11/2014
M	DRAFT DA ISSUE	30/11/2014
N	AMENDED DA SUBMISSION	03/02/2015
O	AMENDED DA SUBMISSION	05/06/2017

Unit Types	RL Schedule - Level 20-21	
	Level	RL
1BED	Level 20	165.30
2BED	Level 21	168.35
3BED		

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12-22 LANGSTON PLACE, EPPING

drawing

Level 20-21 Floor Plan

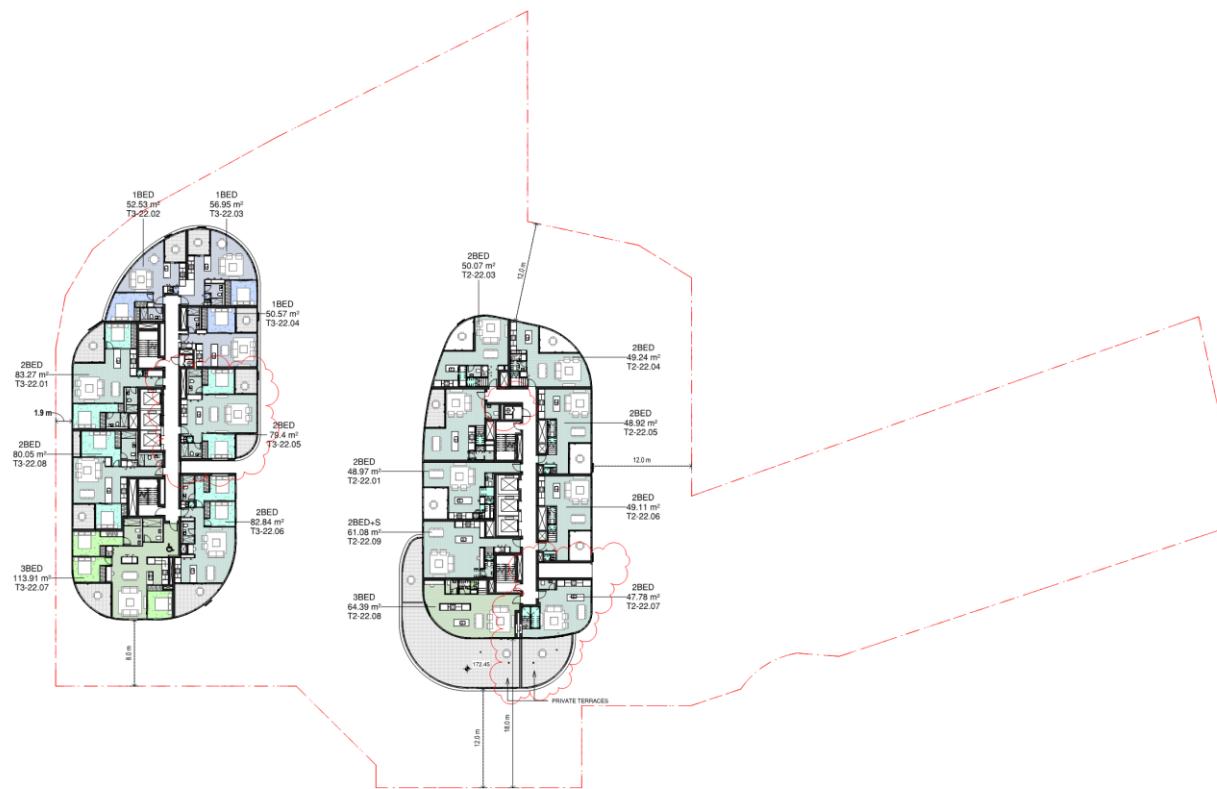
drawing no.

issue

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E	DRAFT DA ISSUE	22/12/2010
F	DRAG DA ISSUE	22/12/2010
G	FINAL DRAFT DA ISSUE	04/01/2011
H	DA ISSUE	06/01/2011
I	DA SUBMISSION	11/01/2011
J	DA SUBMISSION AMENDMENTS	30/01/2011
K	FOR INFORMATION	01/02/2011
L	DRAFT DA ISSUE	25/11/2010
M	DRAFT DA ISSUE	03/12/2010
N	AMENDED DA SUBMISSION	03/01/2011
O	AMENDED DA SUBMISSION	05/06/2011



Unit Types	RL Schedule - L	
	Level	
1BED		
2BED	Level 22	171
2BED+S		
+		

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 ABN 49 131 245 000

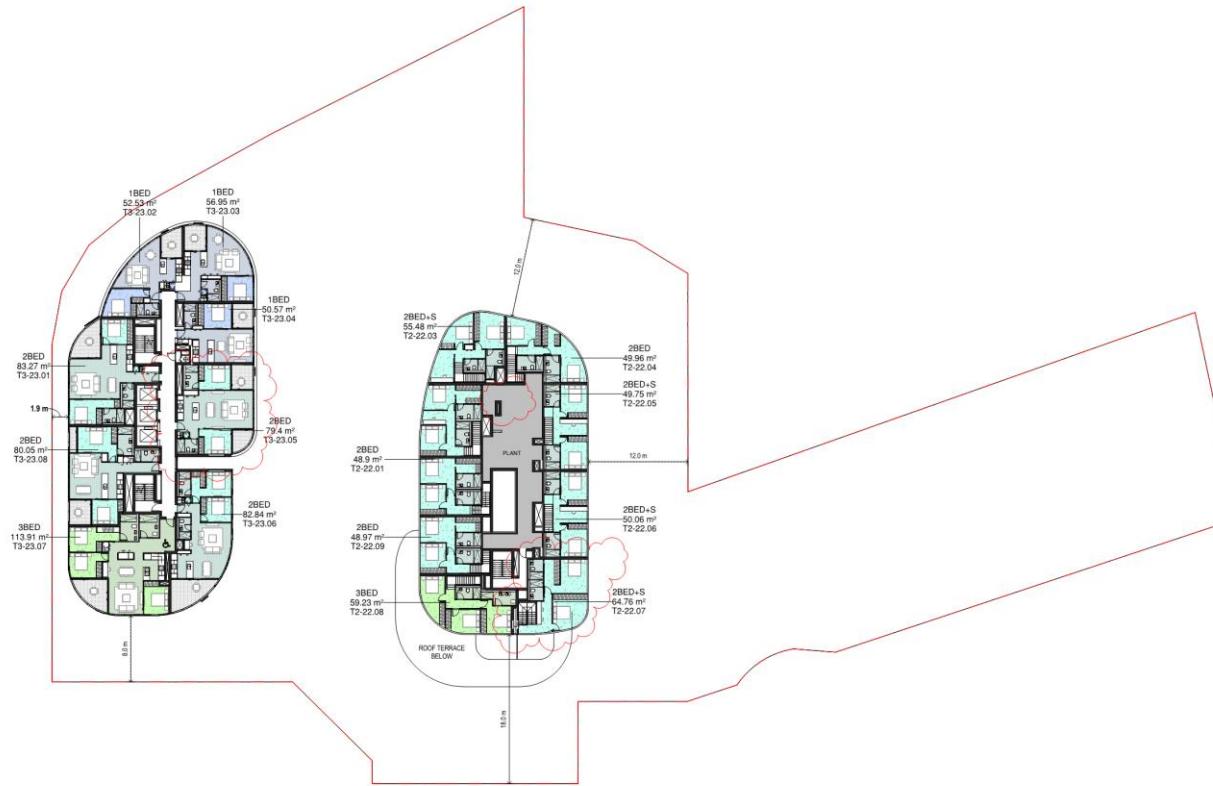
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project

Level 22 Floor Plan

88

ANSWER



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F	DRAFT DA ISSUE	22/01/2015
G	AMENDED DA ISSUE	24/01/2015
H	DA ISSUE	14/02/2015
I	AMENDED DA ISSUE	14/02/2015
J	DA SUBMISSION	11/02/2015
K	FOR INFORMATION	24/11/2014
L	AMENDED DA ISSUE	25/11/2014
M	DRAFT DA ISSUE	30/11/2014
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O	AMENDED DA SUBMISSION	25/06/2017

RL Schedule - Level 23	
Level	RL
Level 23	174.45

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Scale 1:250 @ A1  
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12-22 LANGSTON PLACE, EPPING

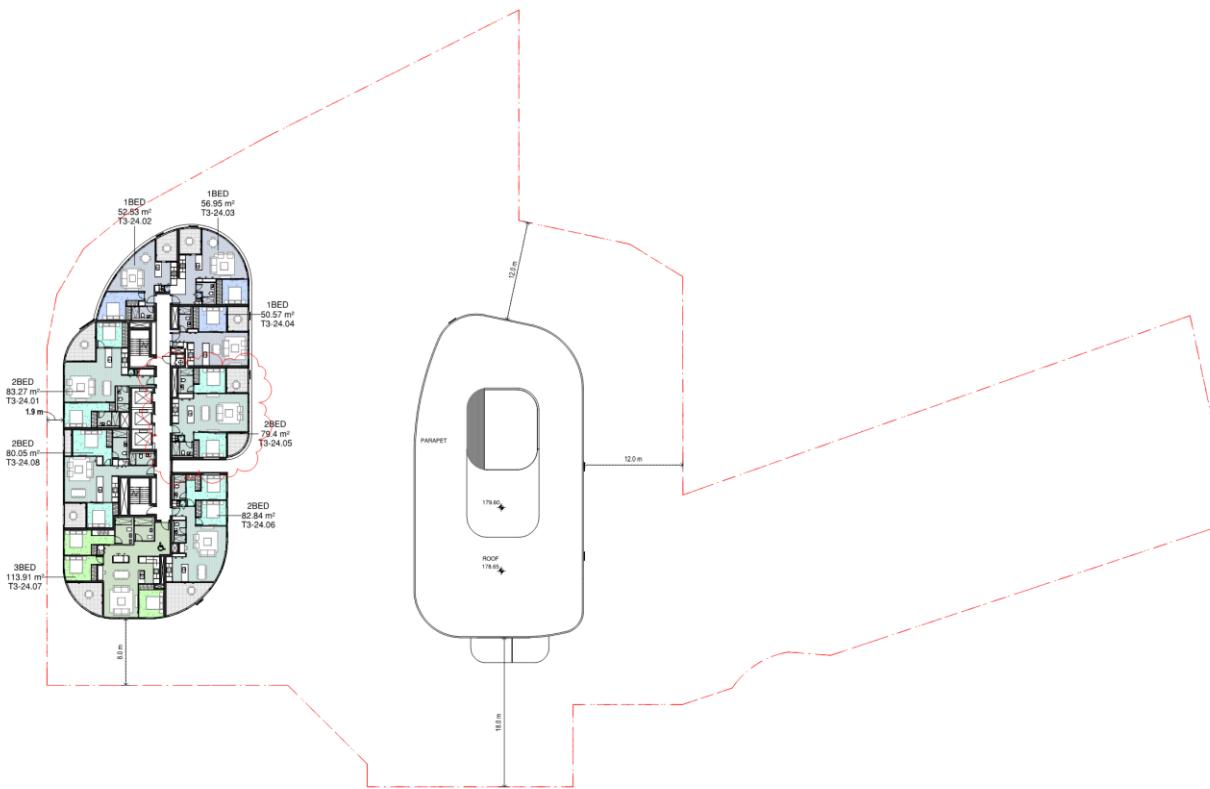
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drawing  
Level 23 Floor Plan

DA1019  
O





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D	DRAFT DA ISSUE	22/10/2010
E	DRAFT DA ISSUE	22/10/2010
F	AMENDED DRAFT DA ISSUE	04/11/2010
G	DA SUBMISSION	16/10/2010
H	DA SUBMISSION	16/10/2010
I	AMENDED DA SUBMISSION	08/11/2010
J	AMENDED DA SUBMISSION	08/11/2010
K	DRAFT DA ISSUE	25/11/2010
L	DRAFT DA ISSUE	08/12/2010
M	AMENDED DA SUBMISSION	09/12/2010
N	AMENDED DA SUBMISSION	05/01/2011

Unit Types	RL Schedule
1BED	Level
2BED	Level 24
3BED	


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 drawn AR/IN/MC/PL/HN project no 140309  
 Scale 1:250 @ A1

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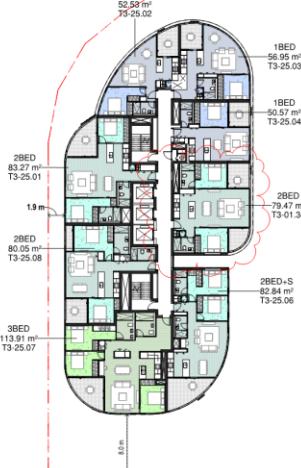
project

Level 24 Floor Plan

drawing no. 1882

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DA1021



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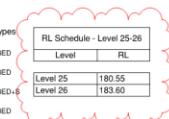


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D	AMENDED DA ISSUE	29/01/2015
E	FINAL DRAFT DA ISSUE	04/02/2014
F	DA SUBMISSION	09/02/2014
G	DA SUBMISSION	11/02/2014
H	DA FOR INFORMATION	24/11/2014
I	DA FOR INFORMATION	27/11/2014
J	DRAFT DA ISSUE	03/12/2014
K	AMENDED DA SUBMISSION	05/02/2014
L	AMENDED DA SUBMISSION	05/06/2017



Unit Types	RL Schedule - Level 25-26
1BED	Level   RL,
2BED	Level 25   180.55
2BED+S	Level 26   183.60
3BED	



checked  
Scale 1:250 @ A1  
F1 scale  
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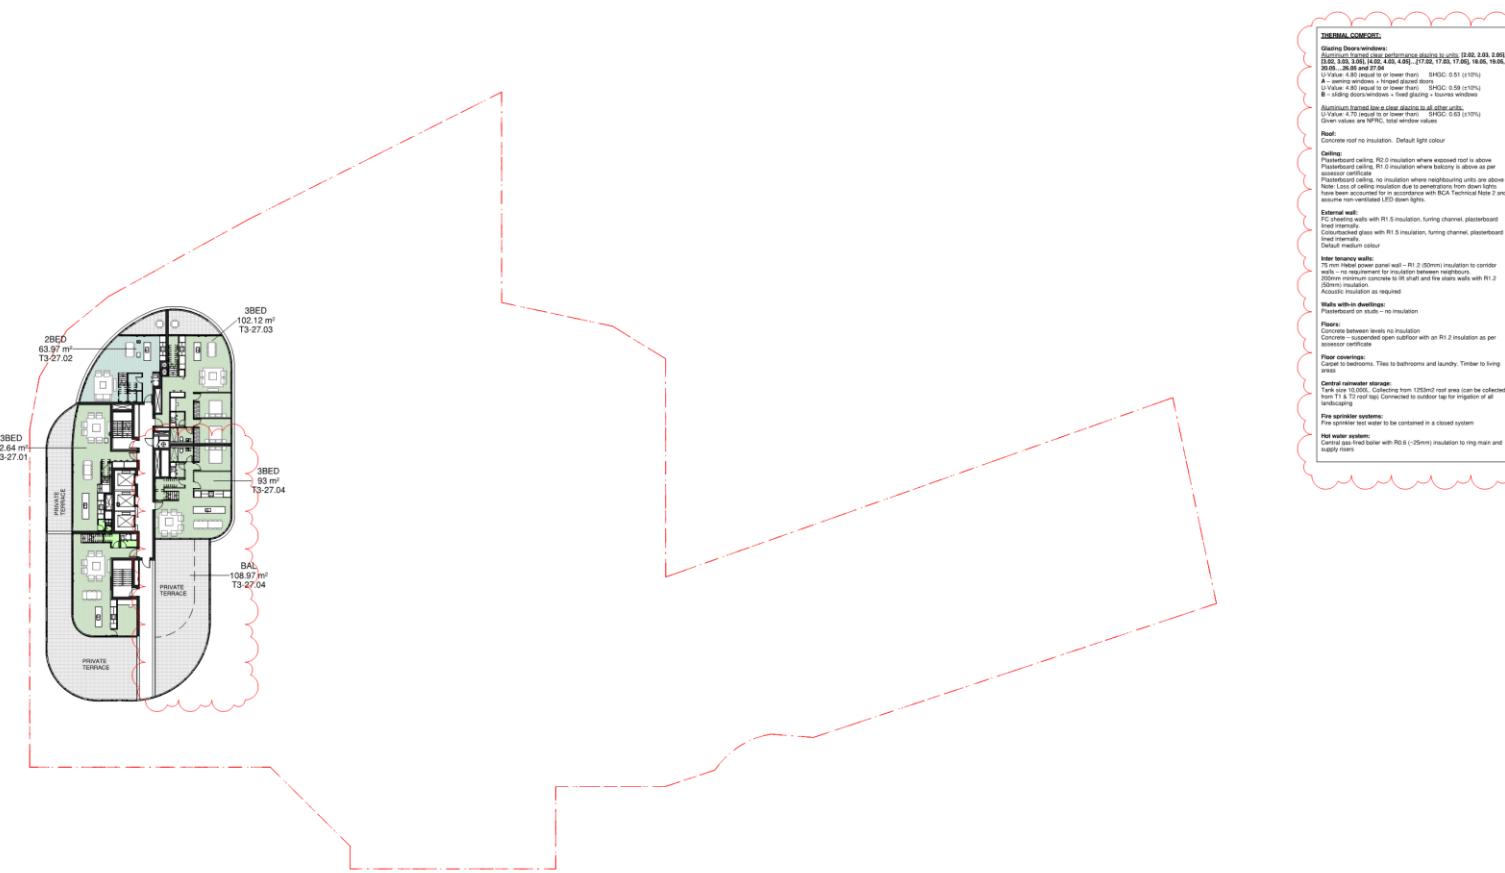
12-22 LANGSTON PLACE, EPPING

drawing  
Level 25-26 Floor Plan

drawing no.  
DA1021 L

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RL Schedule - L

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project

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RI/HN/RW/SD project no 14030

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DA1023



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E	AMENDED DA SUBMISSION	05/06/2017



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12-22 LANGSTON PLACE, EPPING

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ARINRMCPLHN/PW/SD project no. 140309.00

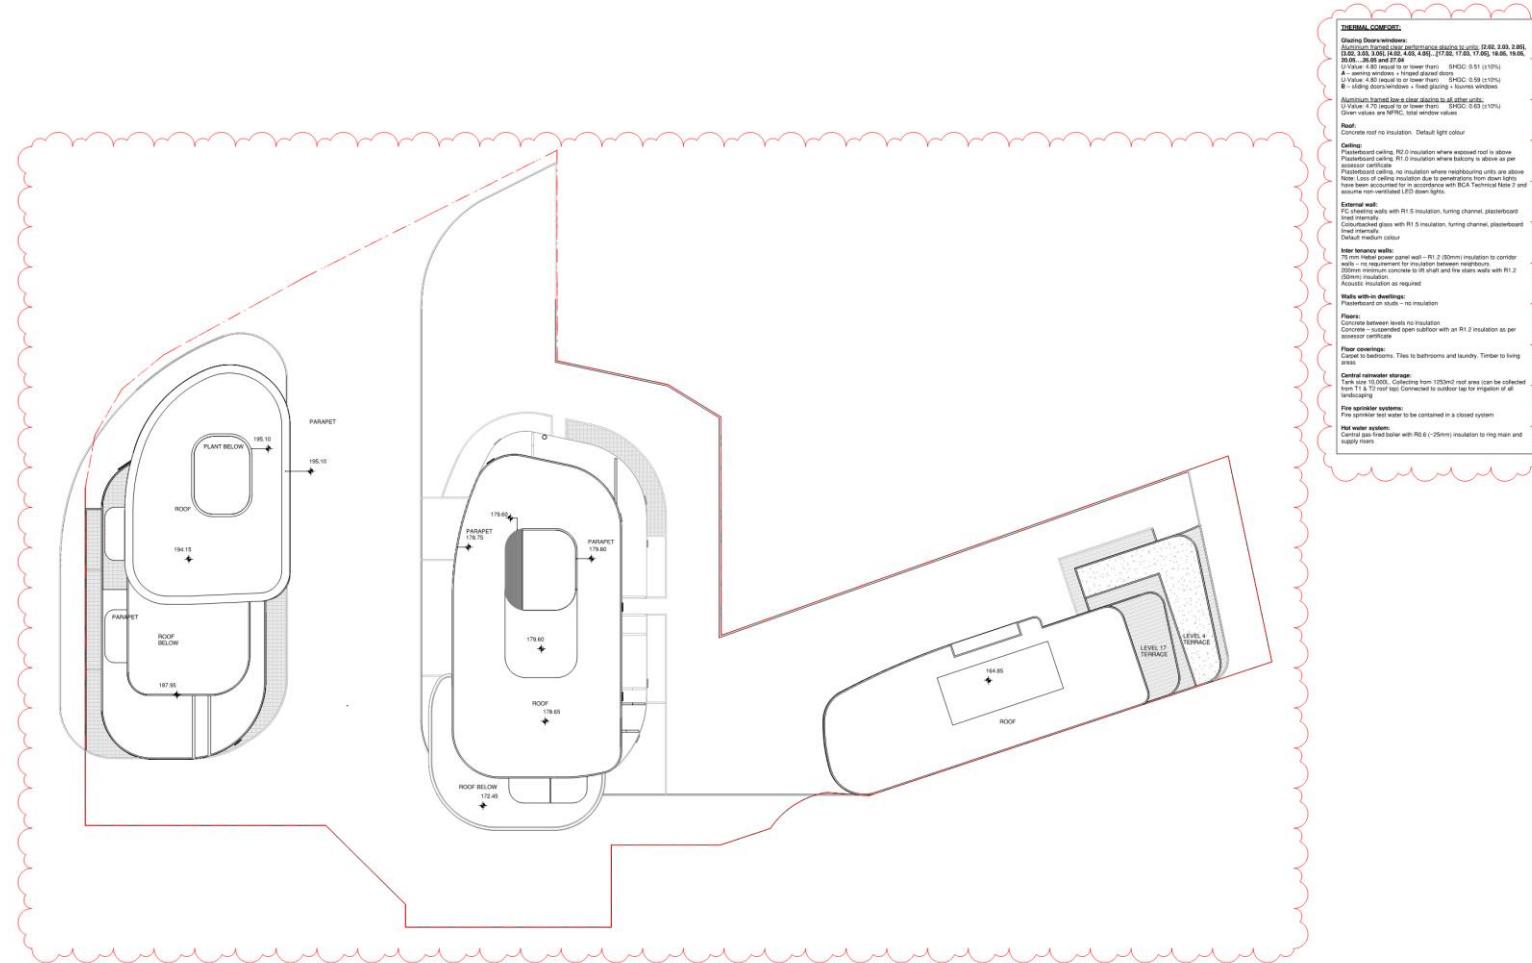
drawing Level 28 Floor Plan

drawing no. issue

DA1023

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D	DA SUBMISSION	11/02/2014
E	DA SUBMISSION	24/02/2014
F	DA SUBMISSION	05/03/2014
G	DRAFT DA ISSUE	05/11/2014
H	DRAFT DA ISSUE	05/12/2014
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12-22 LANGSTON PLACE, EPPING

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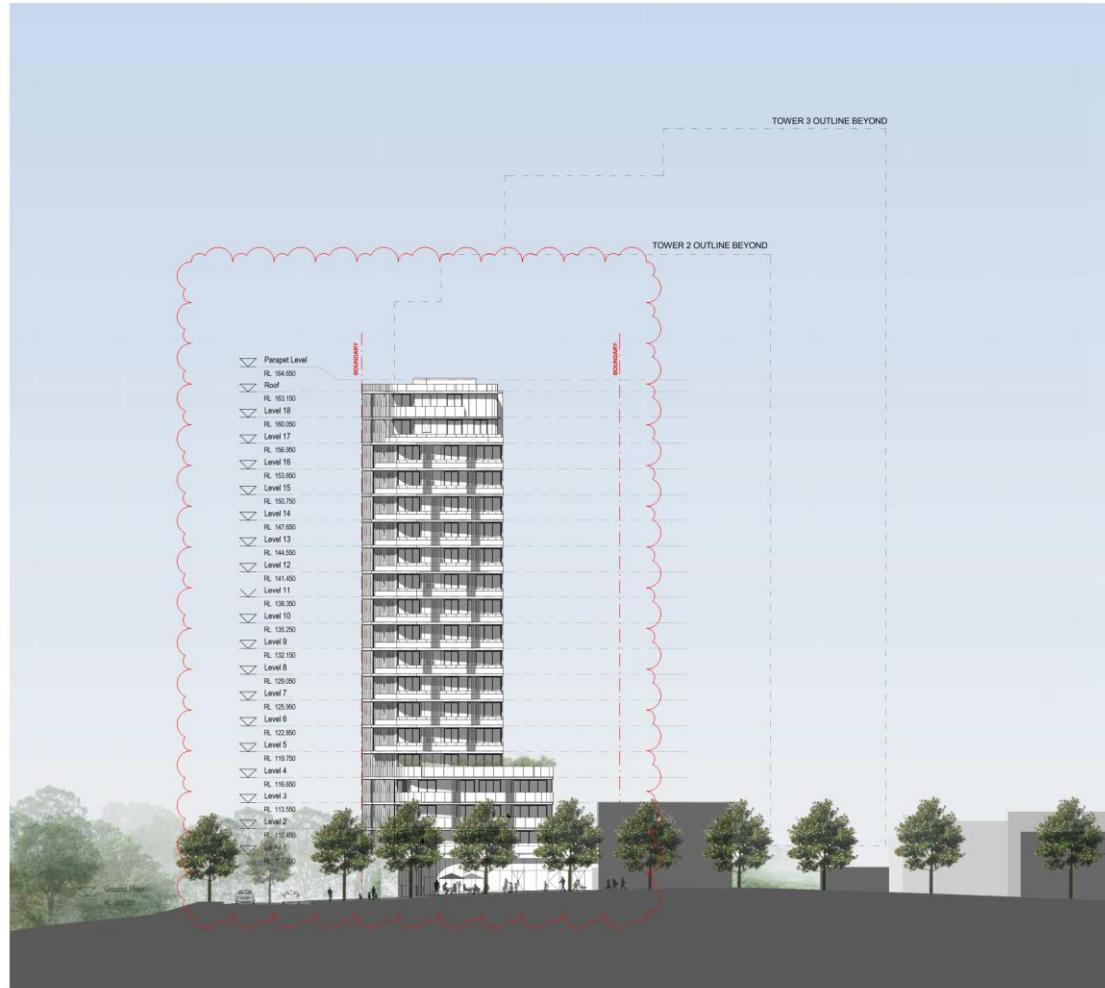
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T 02 8688 8400  
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sydney@architectus.com.au  
ABN 99 121 085 644

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Roof Plan  
drawing no. DA1024  
issue J

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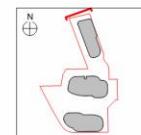


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E	DRAFT DA ISSUE	15/02/2016
F	DRAFT DA ISSUE	25/11/2016
G	AMENDED DA SUBMISSION	03/02/2017
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I	AMENDED DA SUBMISSION	05/02/2017



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project  
12-22 LANGSTON PLACE, EPPING

drawing  
North Elevation - Tower 1

drawing no.  
DA2000

issue  
I

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DA2001

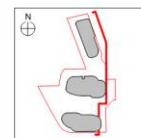


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C	DA ISSUE	04/02/2016
D	DA AMENDMENT	15/02/2016
E	DRAFT DA ISSUE	25/11/2016
F	DA AMENDMENT	03/02/2017
G	AMENDED DA SUBMISSION	03/02/2017
H	AMENDED DA SUBMISSION	05/02/2017
I	AMENDED DA SUBMISSION	05/02/2017



## AMENDED DA ISSUE

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project  
12-22 LANGSTON PLACE, EPPING

drawing  
East Elevation

drawing no.  
DA2001

issue  
I

checked  
drawn  
TEAM project no. 140309\_000

Scale 1:250 @ A1 10 12.5m drawn 30/05/2017 6:44:07 PM

DA2002



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project 12-22 LANGSTON PLACE, EPPING

drawings South Elevation

drawing no. DA2002

issue I

checked drawn TEAM project no. 140309.00

Scale 1:250 (A1) P14 date 30/05/2017

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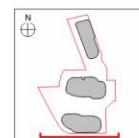
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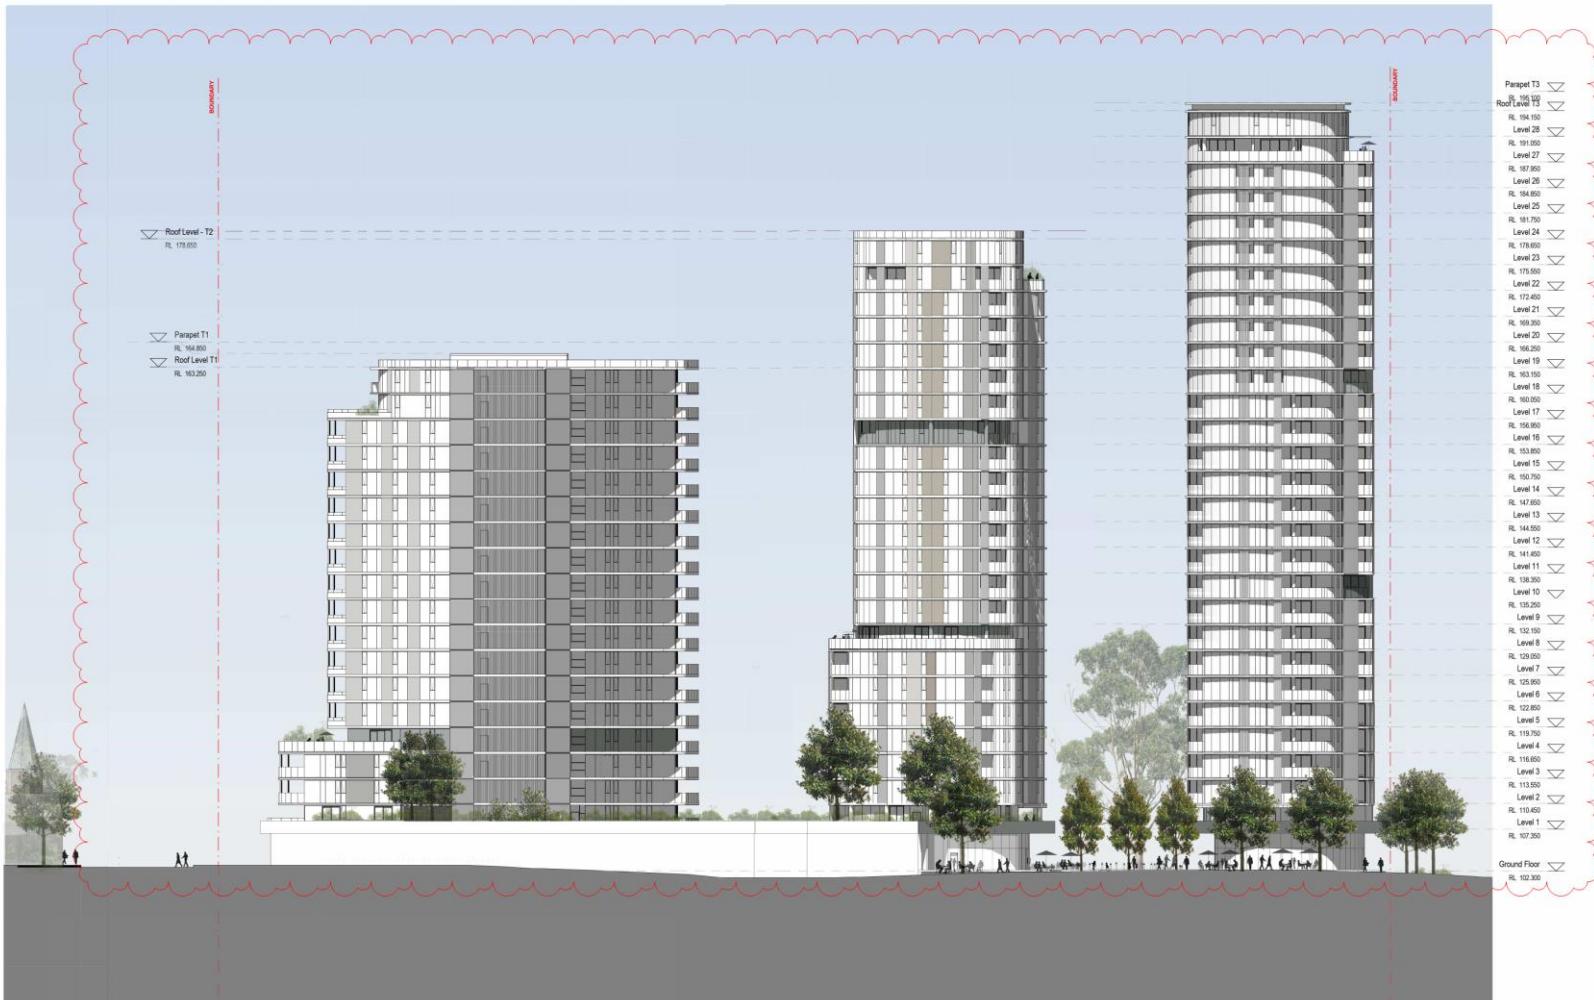


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E	AMENDED DA SUBMISSION	09/02/2016
F	DRAFT DA ISSUE	25/11/2016
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H	AMENDED PLAN SUBMISSION	03/02/2017
I	AMENDED DA SUBMISSION	05/06/2017



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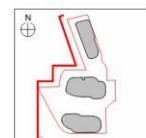


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D	DA AMENDMENT	15/02/2016
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F	DA ISSUE	03/12/2016
G	AMENDED PLAN SUBMISSION	03/02/2017
H	AMENDED DA SUBMISSION	05/02/2017
I	AMENDED DA SUBMISSION	05/02/2017



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project  
12-22 LANGSTON PLACE, EPPING

drawing  
West Elevation

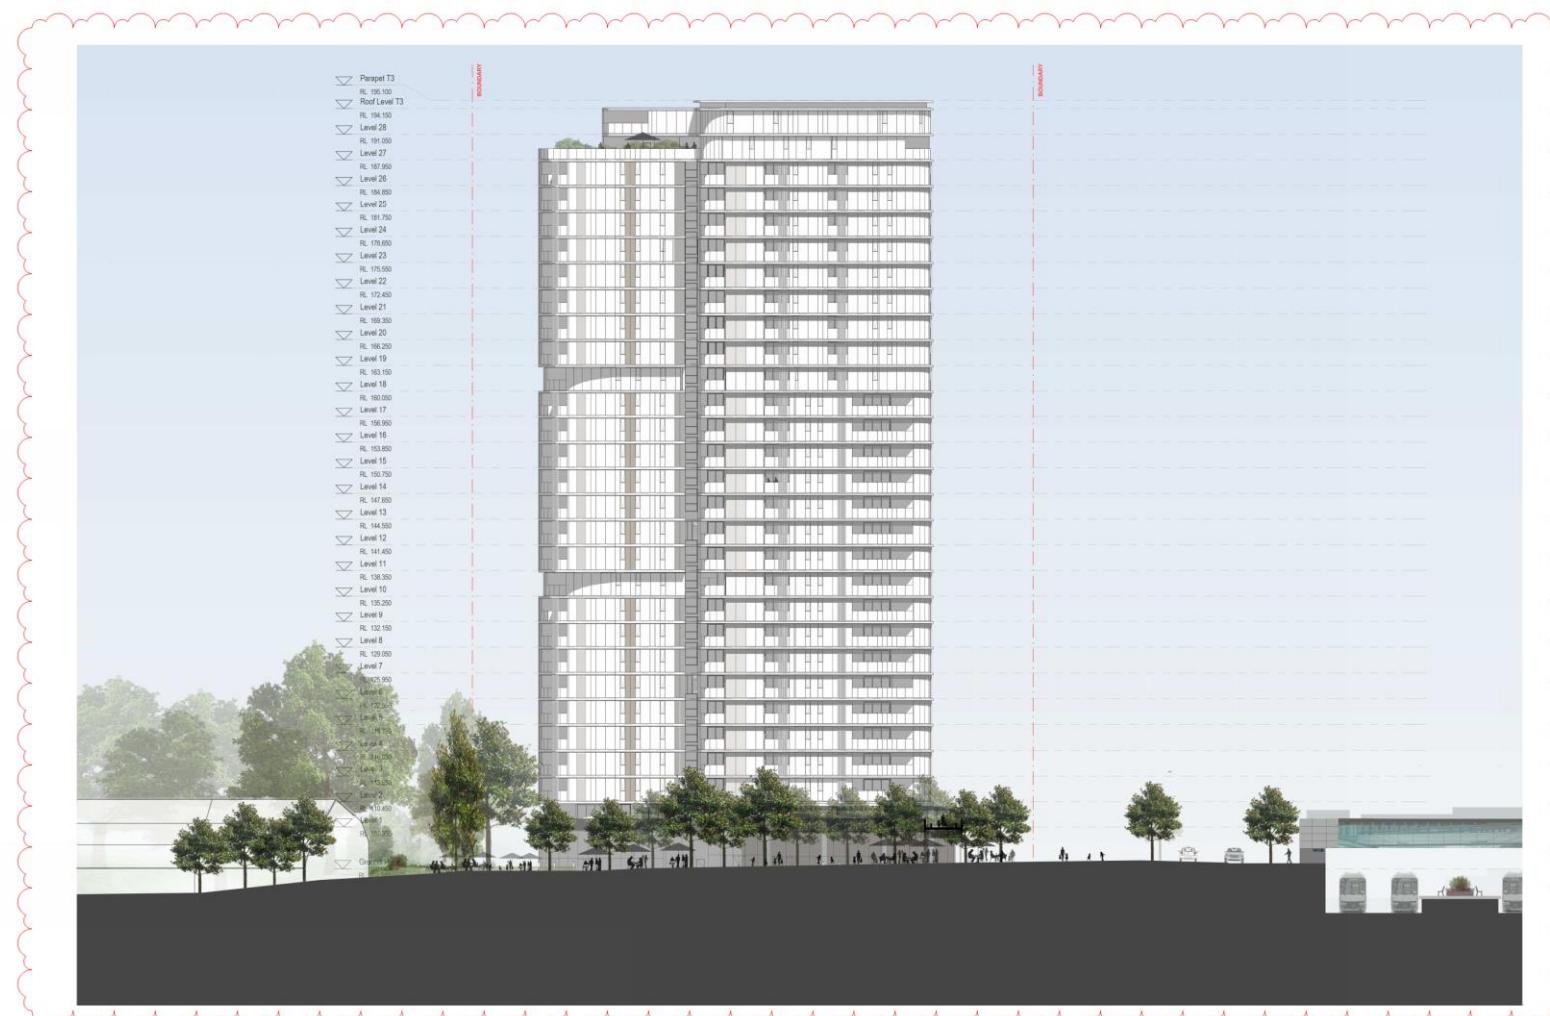
drawing no.  
DA2003

issue  
I

Scale 1:250 @ A1  
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drawn  
TEAM project no. 140309.00

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DA2004

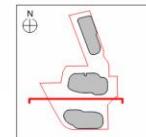


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E	DA APPROVAL	25/02/2016
F	DRAFT DA ISSUE	03/12/2016
G	AMENDED DA SUBMISSION	03/02/2017
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project 12-22 LANGSTON PLACE, EPPING

drawings

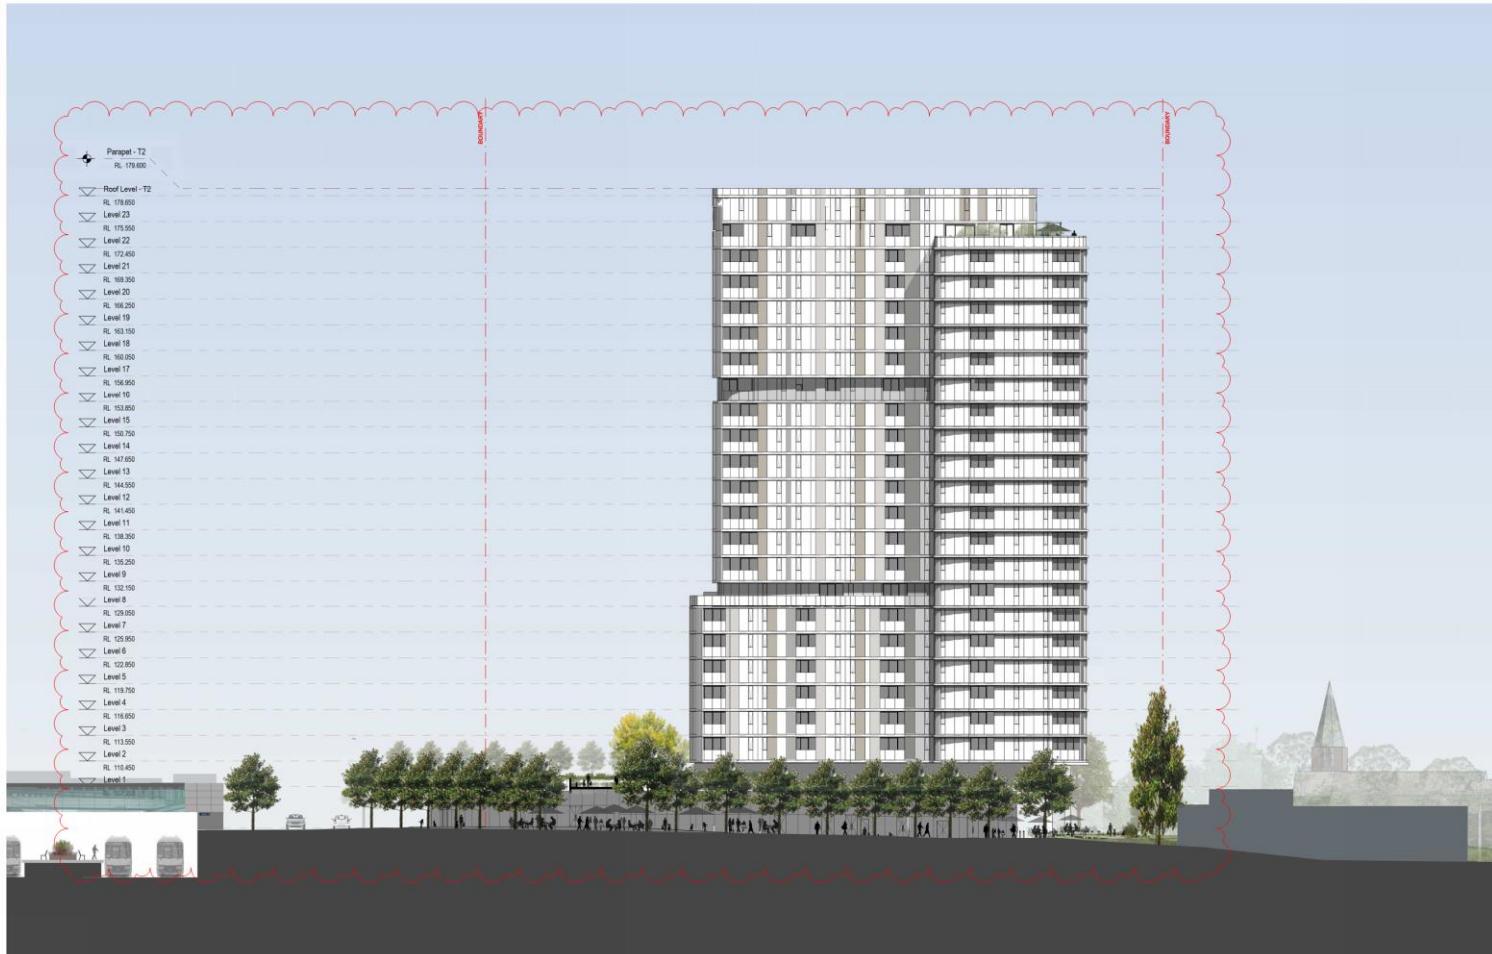
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drawing no. DA2004

issue H

30/05/2017 6:41:11 PM

DA2005

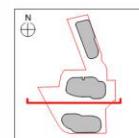


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D	DA SUBMISSION	11/02/2016
E	DRAFT DA ISSUE	25/12/2016
F	DRAFT DA ISSUE	03/12/2016
G	DA SUBMISSION	03/12/2016
H	FOR INFORMATION	05/01/2017
I	AMENDED DA SUBMISSION	05/06/2017



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project  
12-22 LANGSTON PLACE, EPPING

drawing  
South Link Elevation

drawing no.  
DA2005

issue  
I

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DA2006



**AMENDED DA ISSUE**

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project  
12-22 LANGSTON PLACE, EPPING

drawing  
East Context Elevation

drawing no.  
DA2006

issue  
G

DA2007

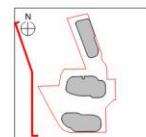


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Do not scale drawings. Verify all dimensions on site.

issue	amendment	date
A	DA ISSUE	09/02/2014
B	DRAFT DA ISSUE	21/11/2013
C	DRAFT DA ISSUE	20/12/2014
D	DA PLAN SUBMISSION	27/02/2015
E	FOR INFORMATION	20/01/2017
F	AMENDED DA SUBMISSION	05/06/2017



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checked  
drawn  
Scale 1:250 @ A1  
PH date  
TEAM project no. 140309.00

project  
12-22 LANGSTON PLACE, EPPING

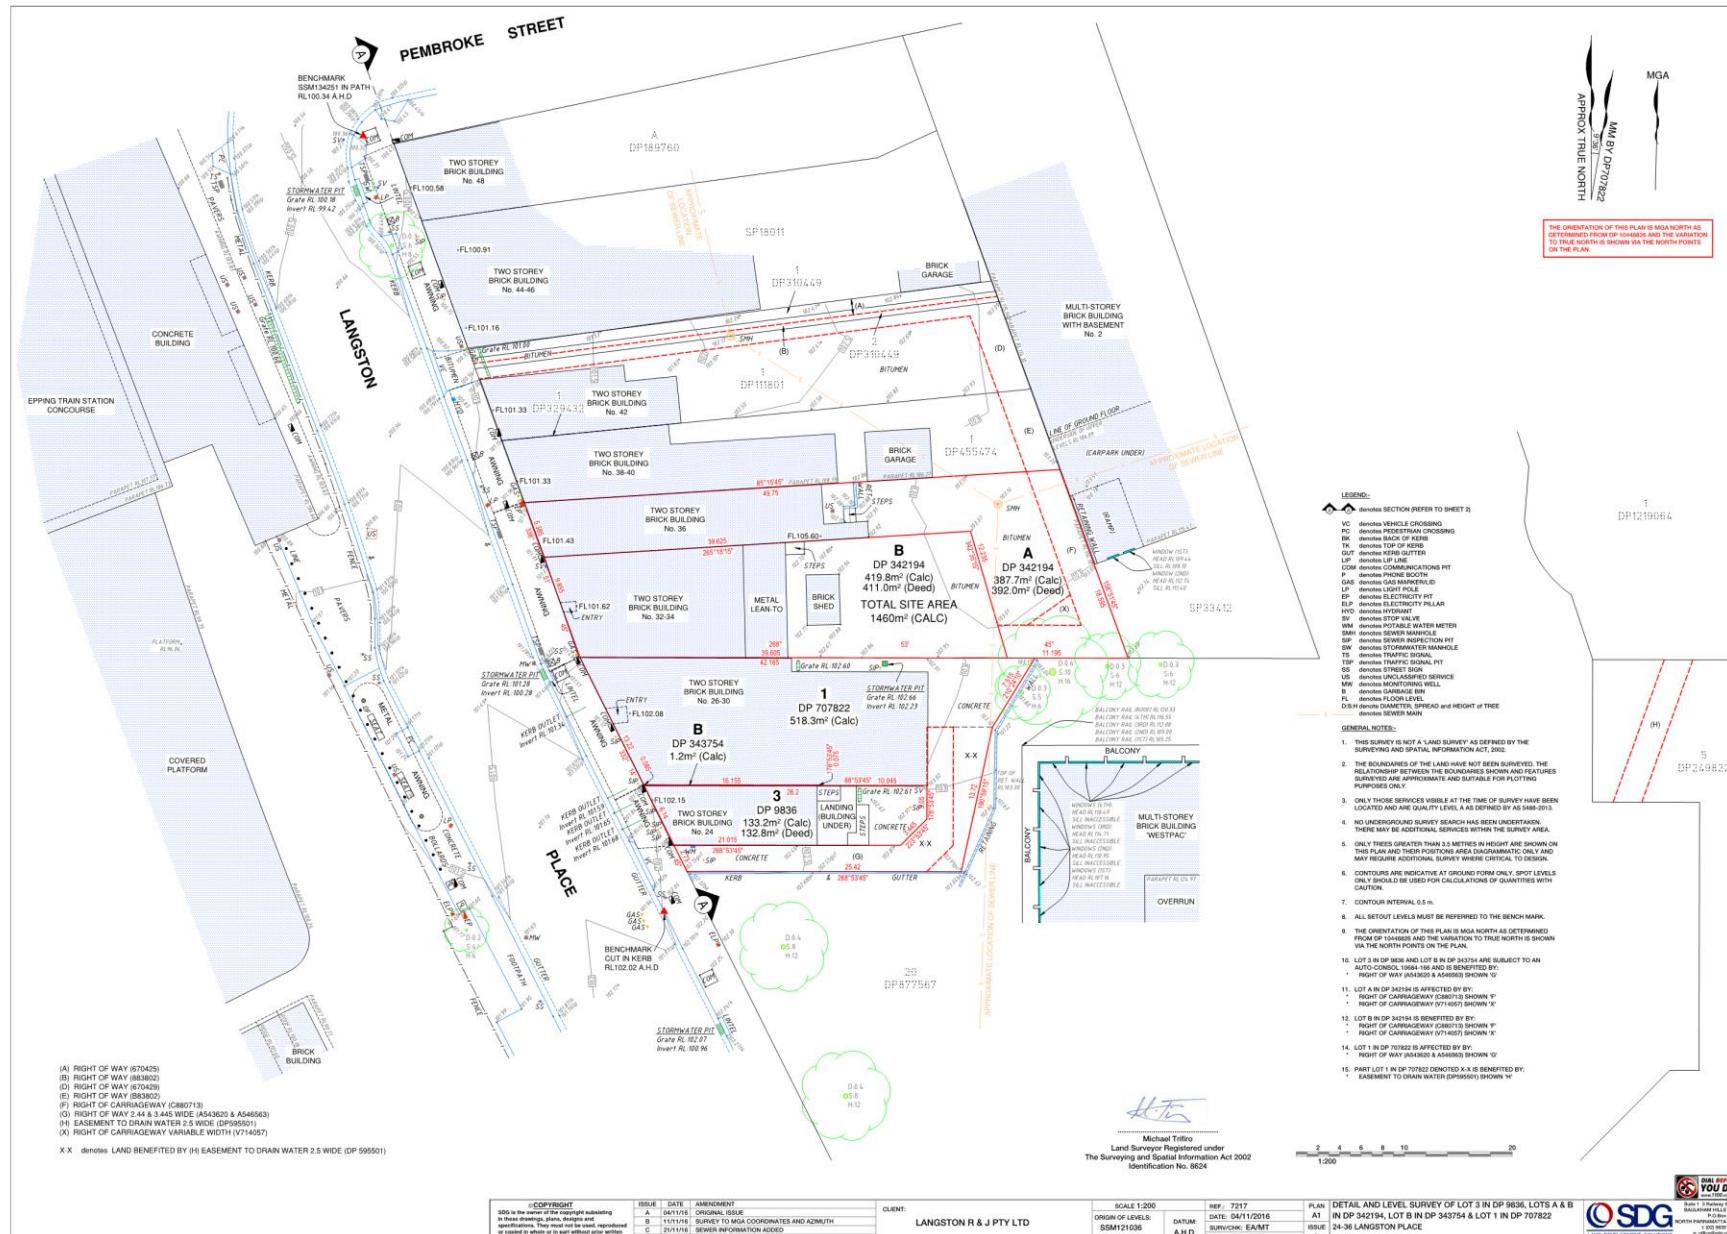
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West Context Elevation

drawing no.  
DA2007  
issue  
G

SLR

# APPENDIX B

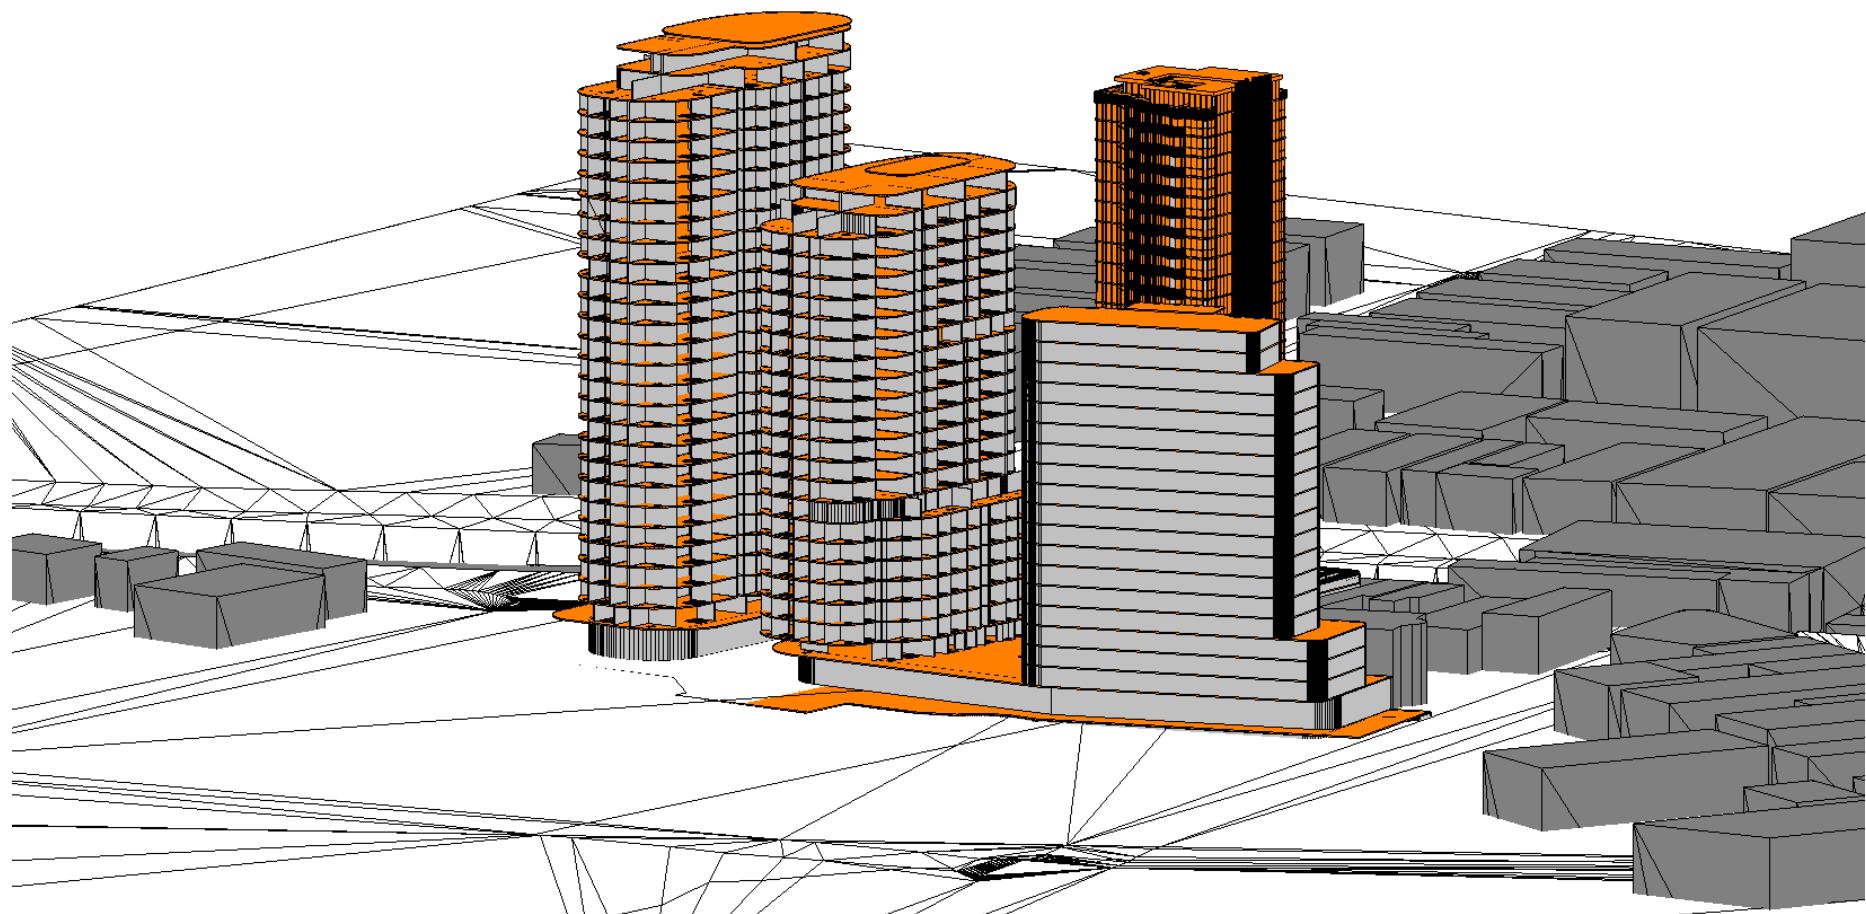
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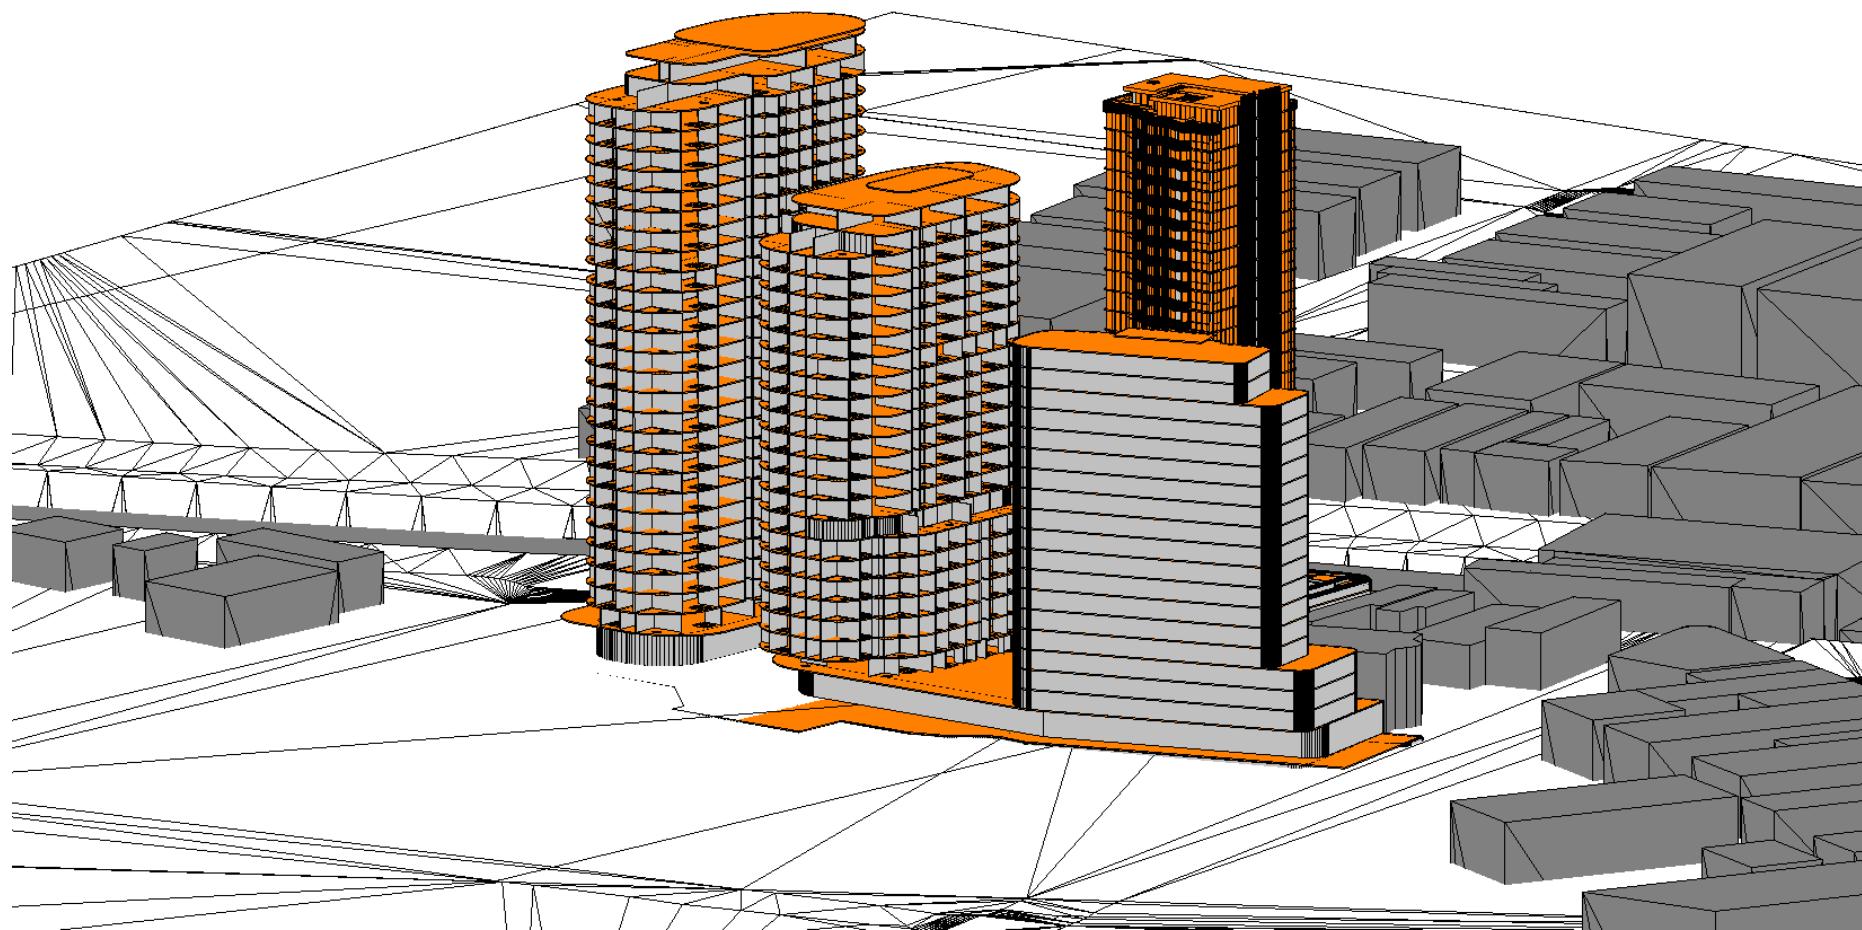
# APPENDIX C

Sun Eye Views DA Scheme

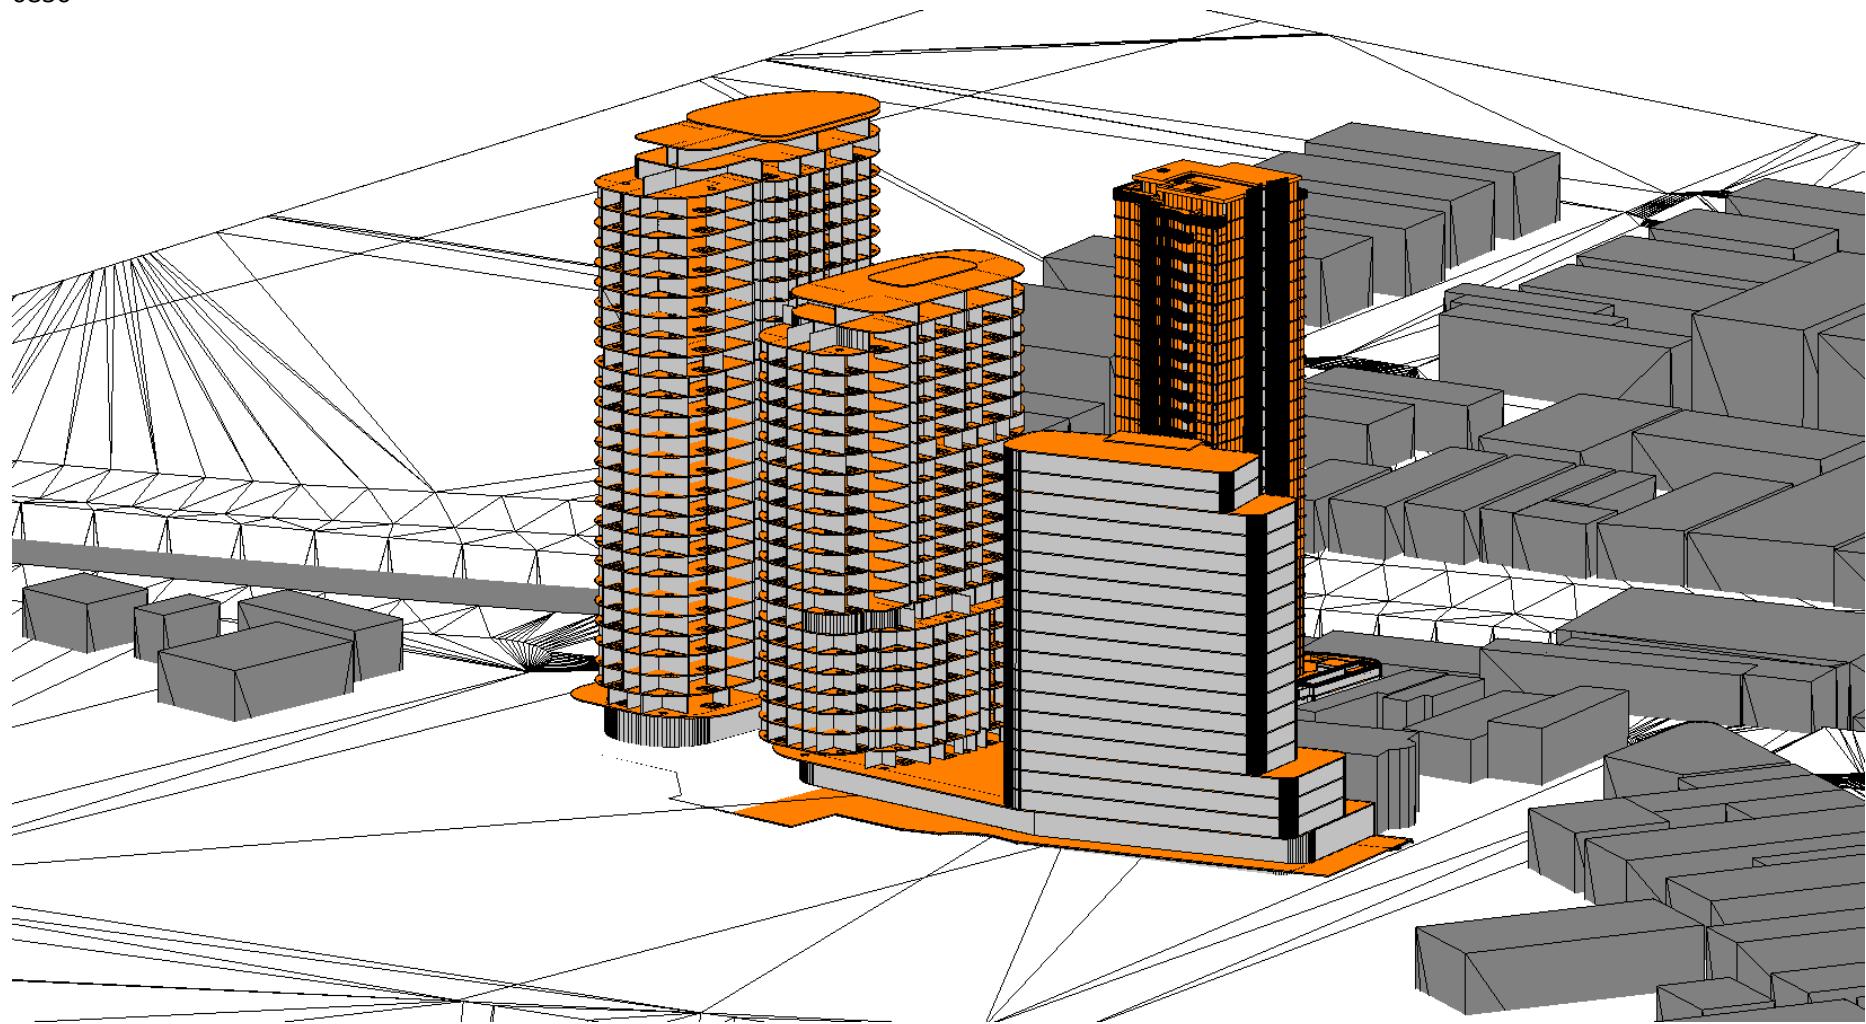
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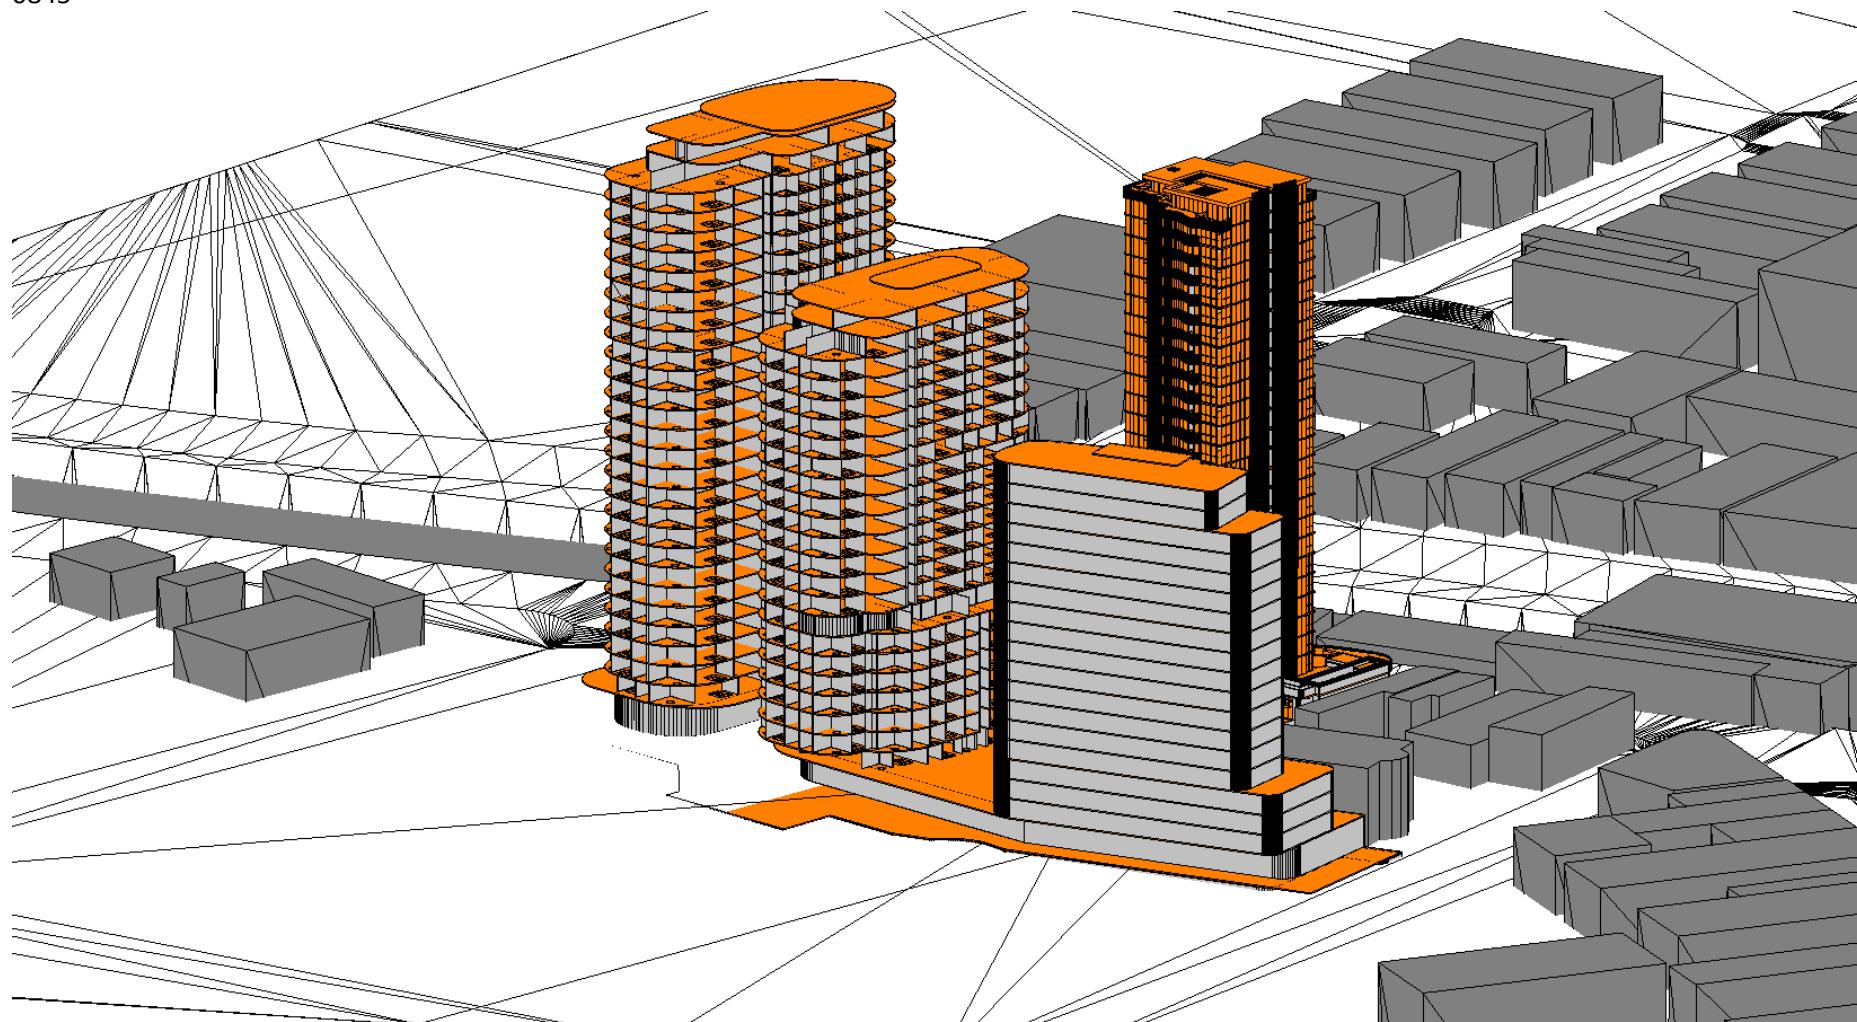
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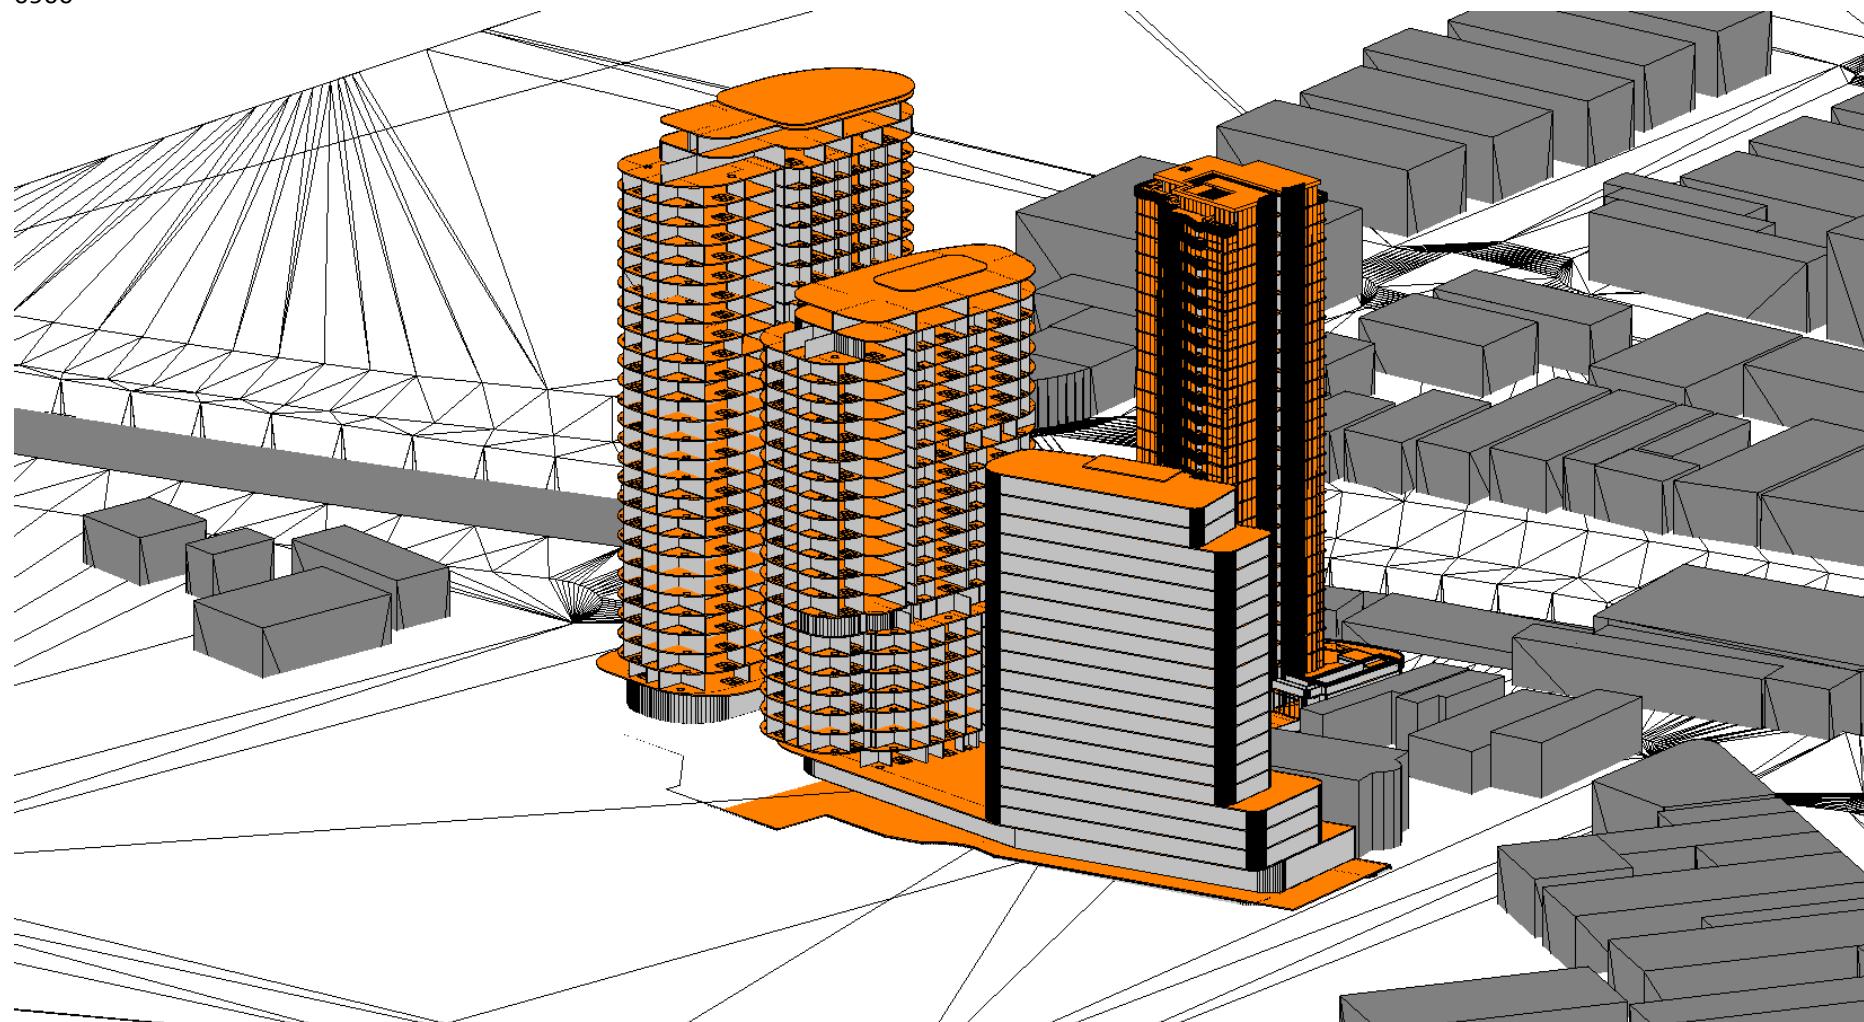
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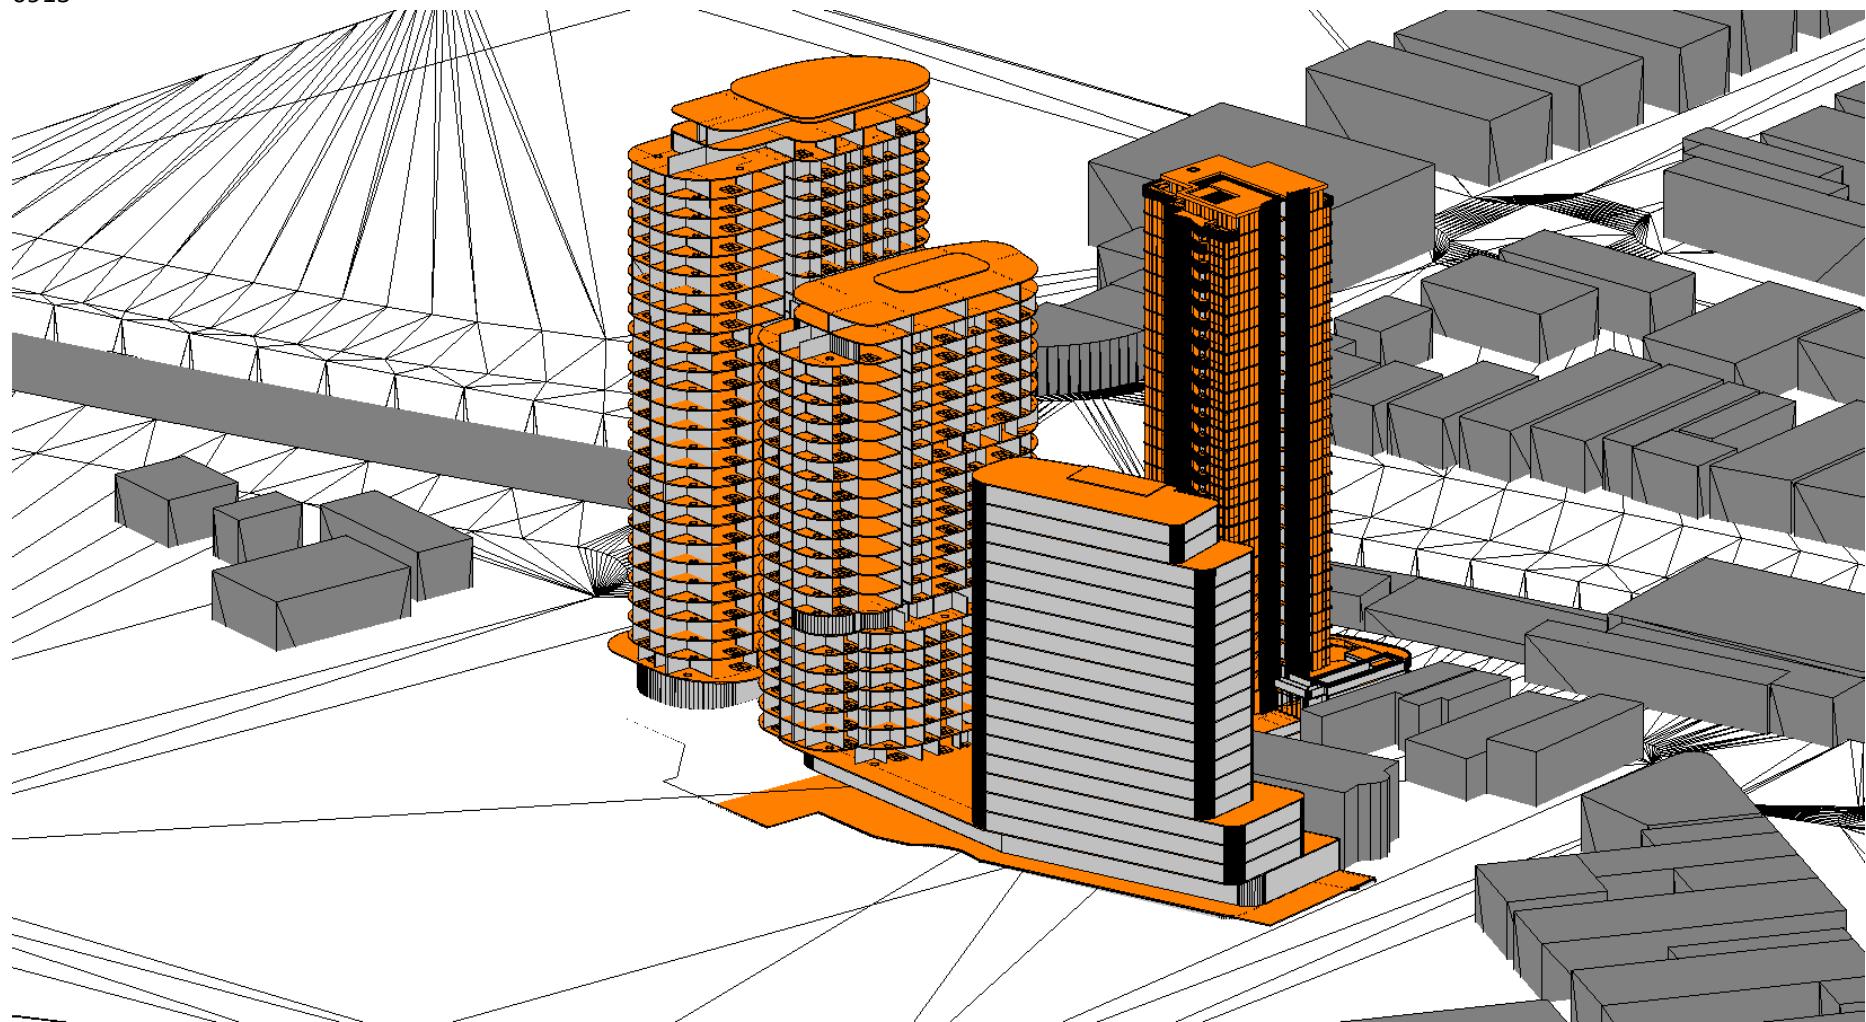
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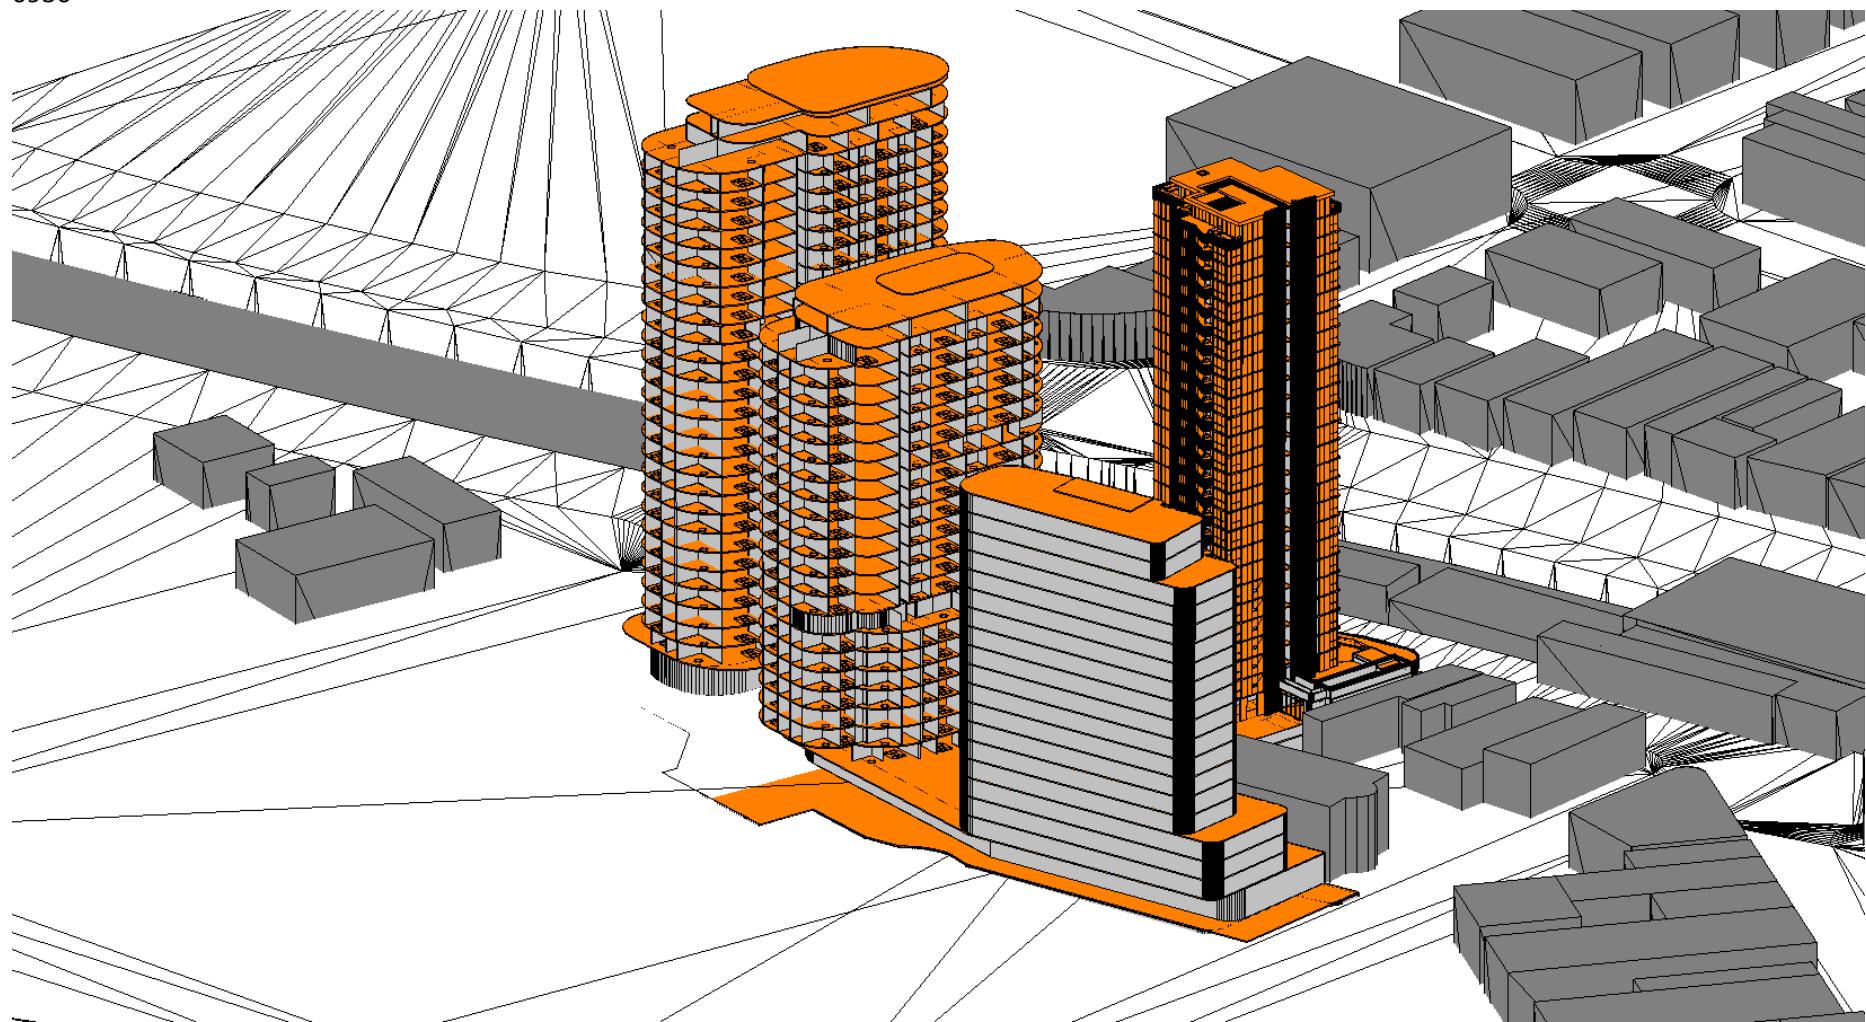
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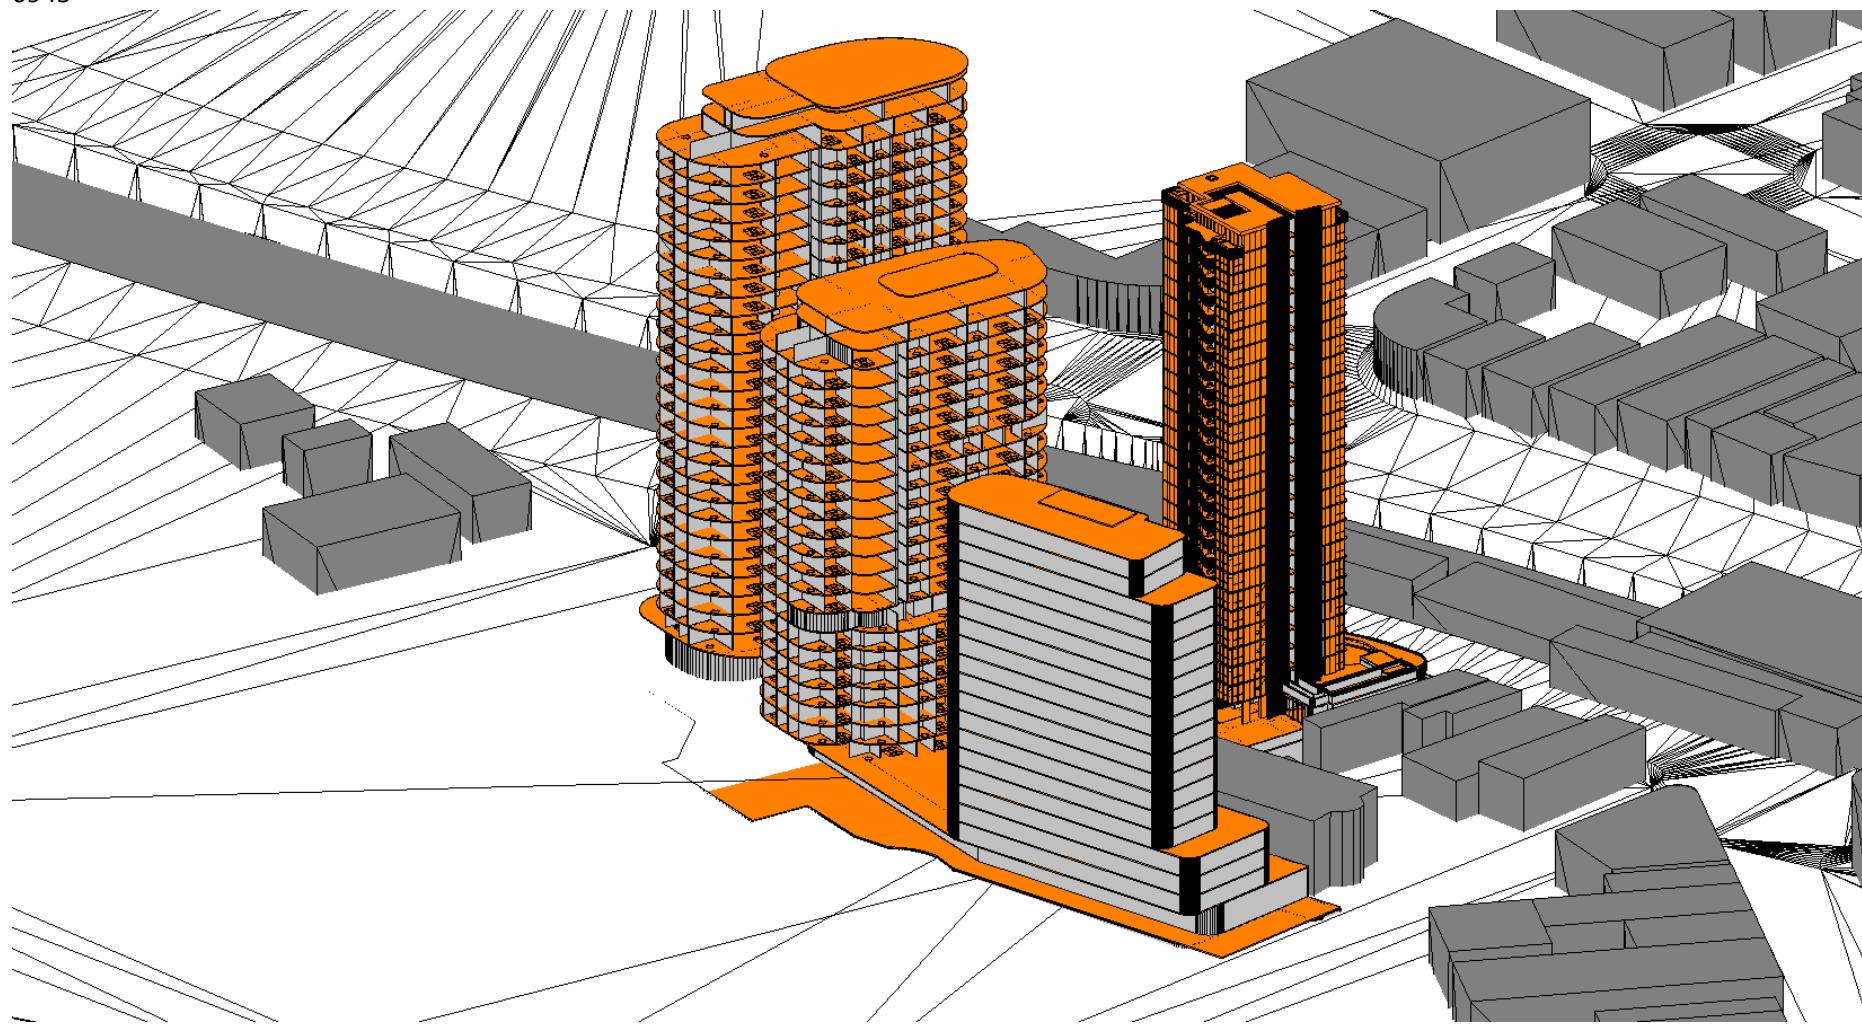
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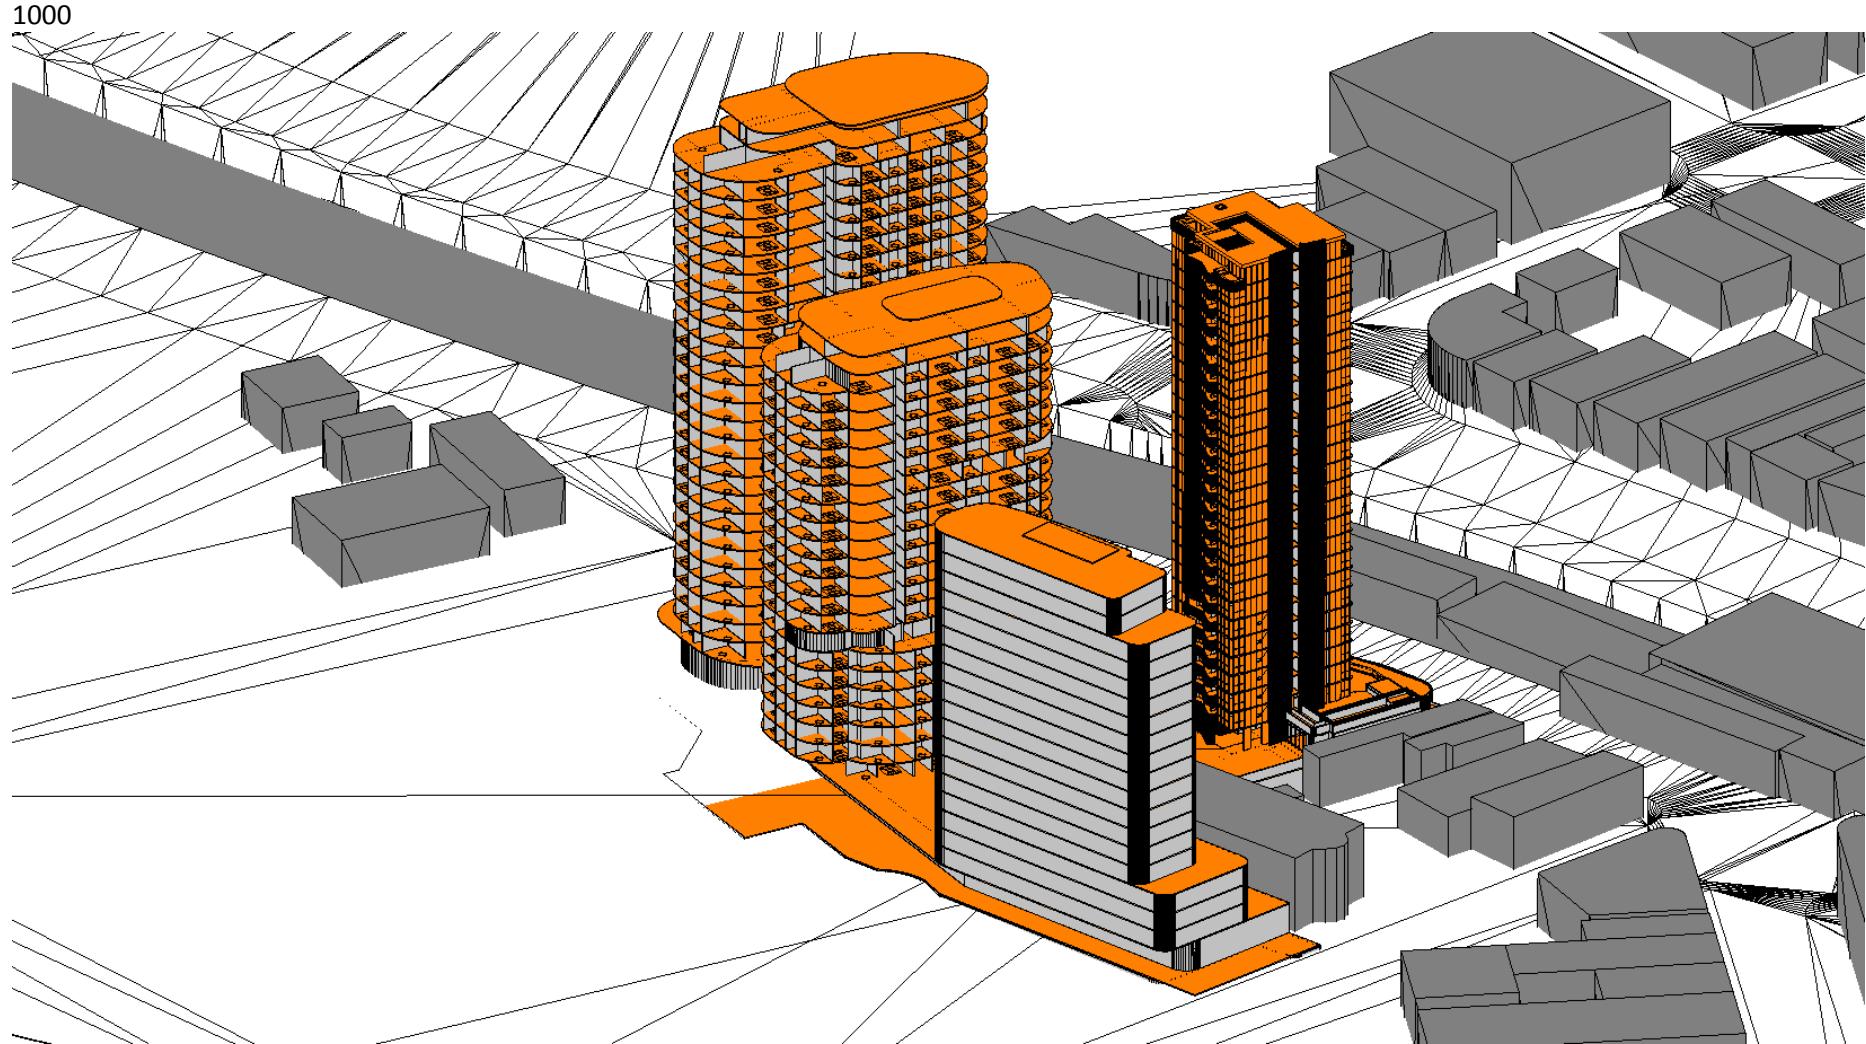


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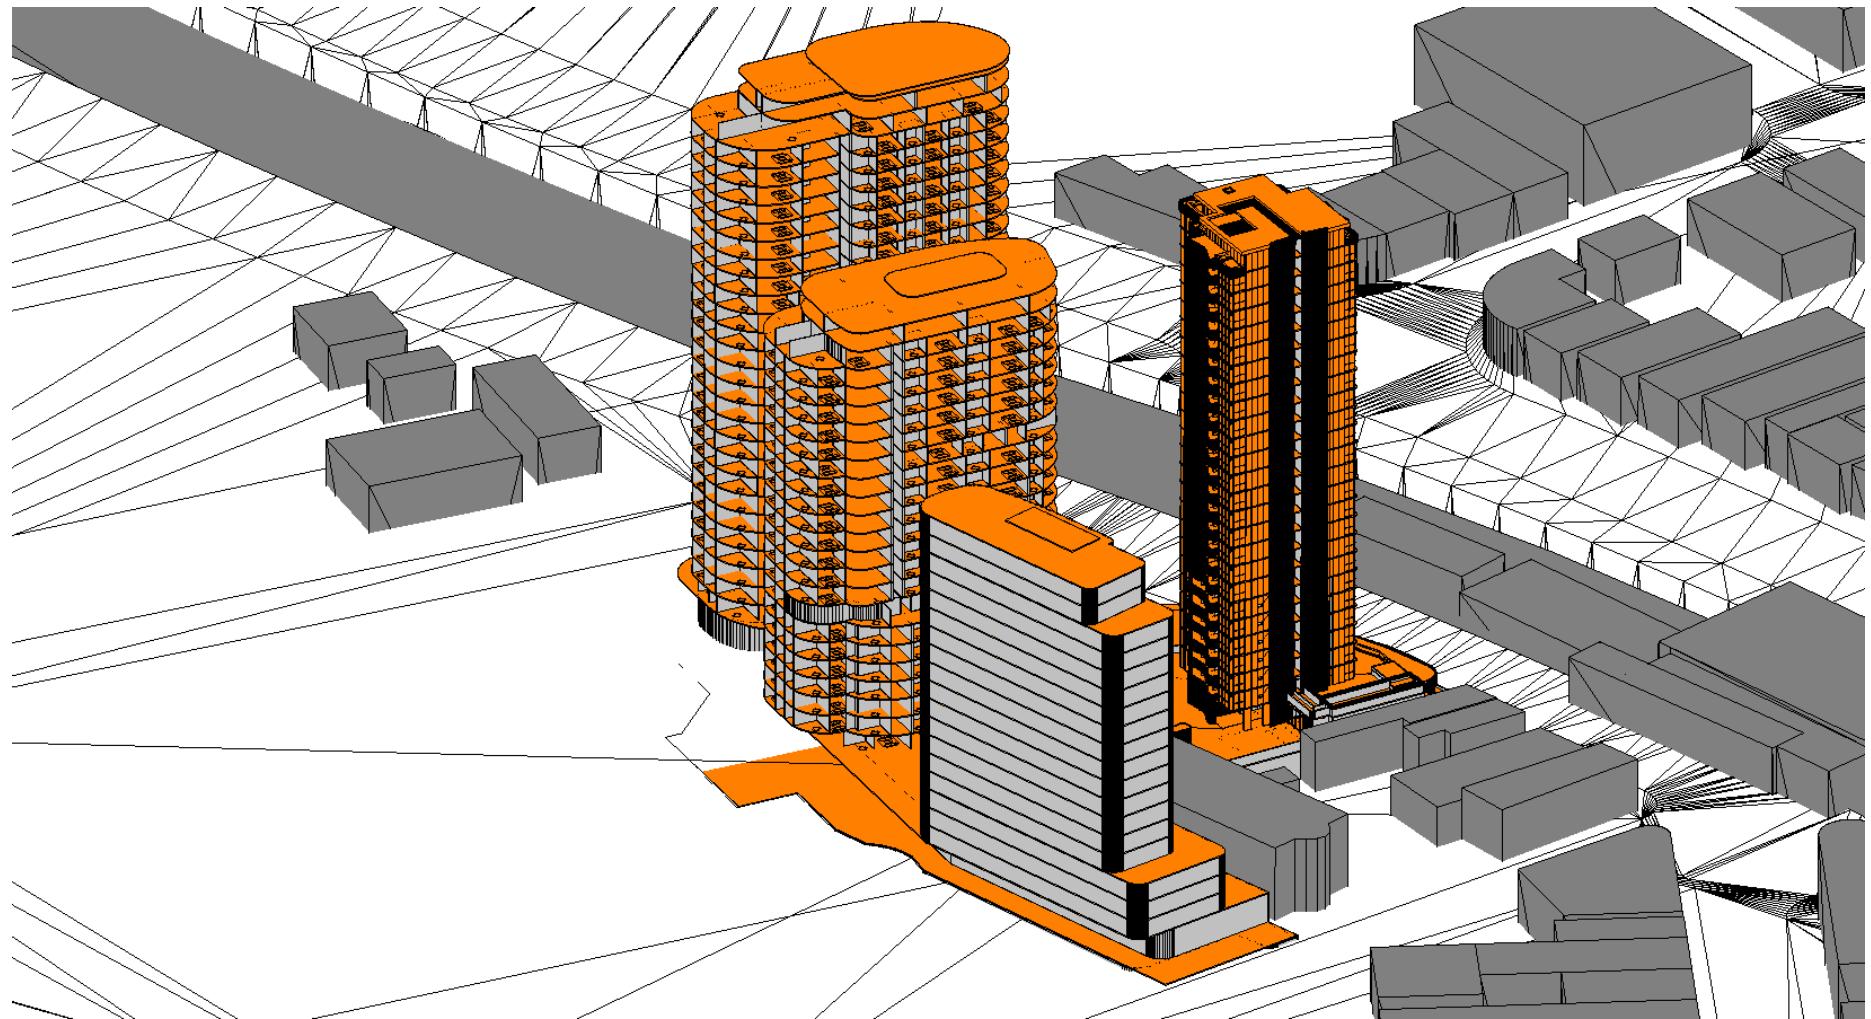


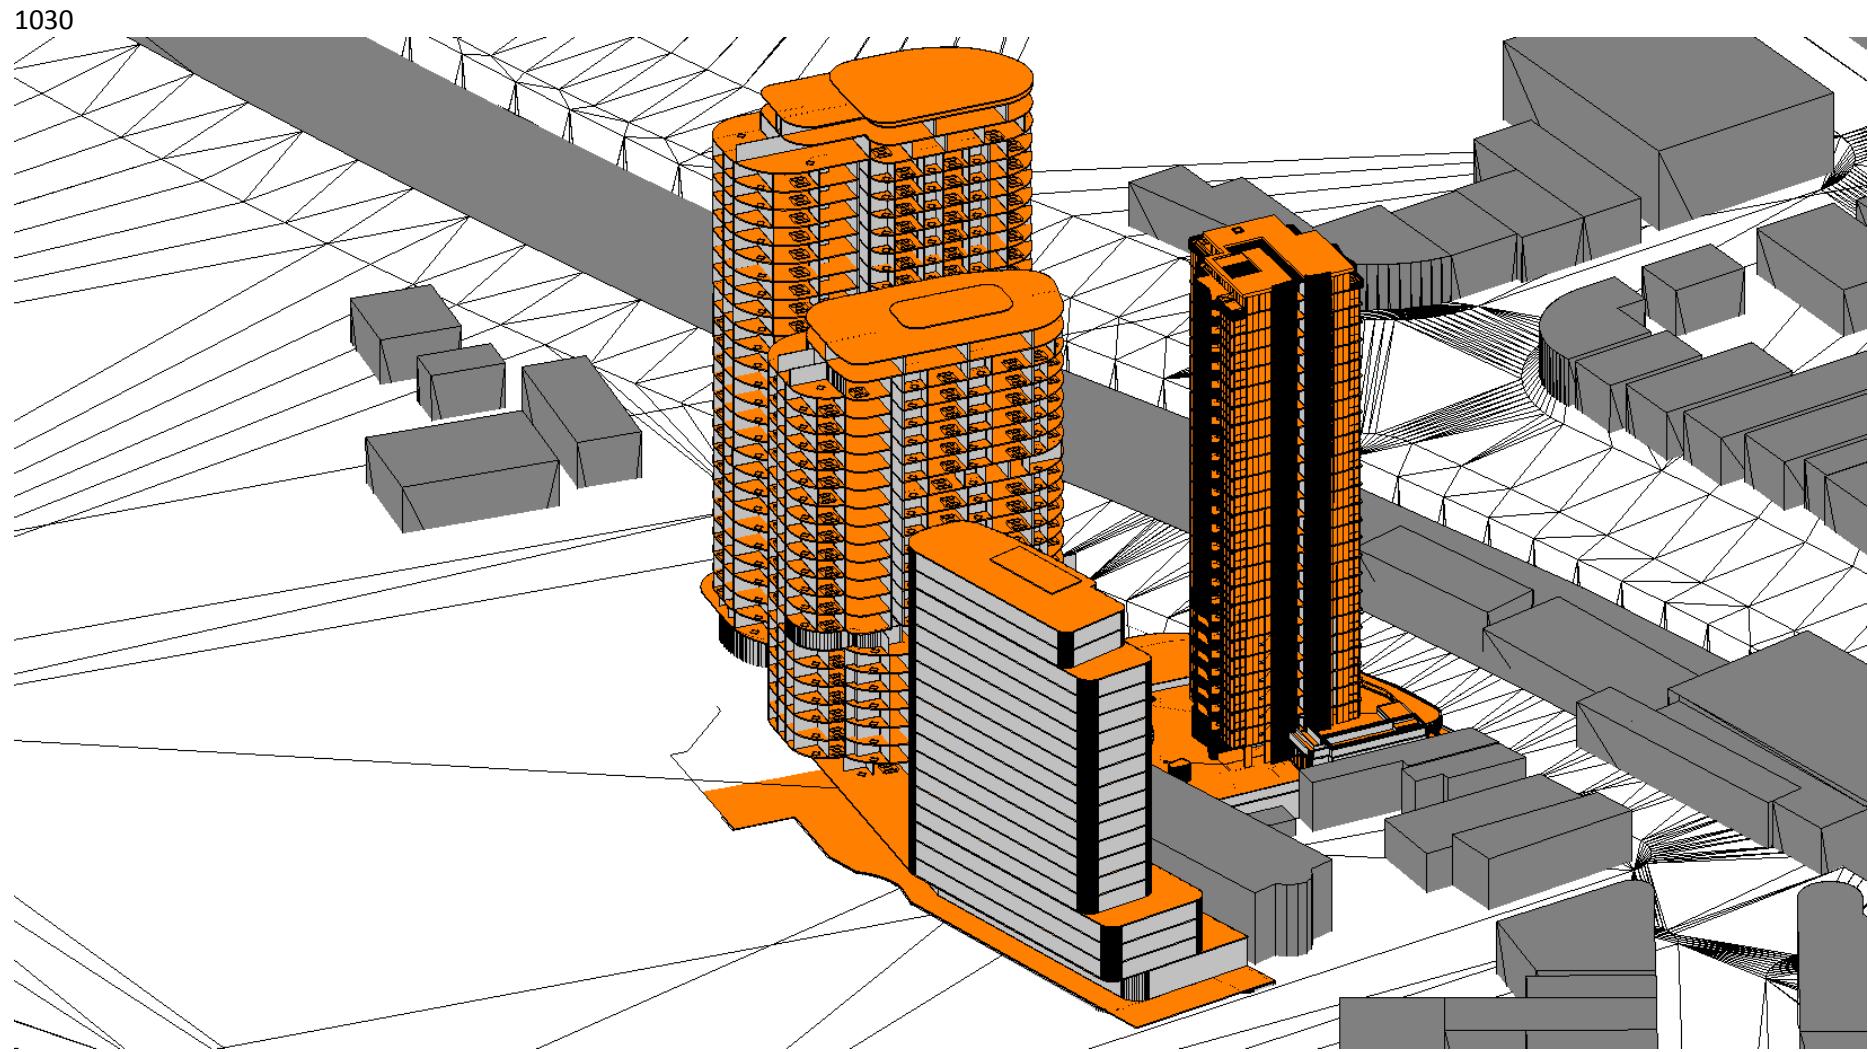
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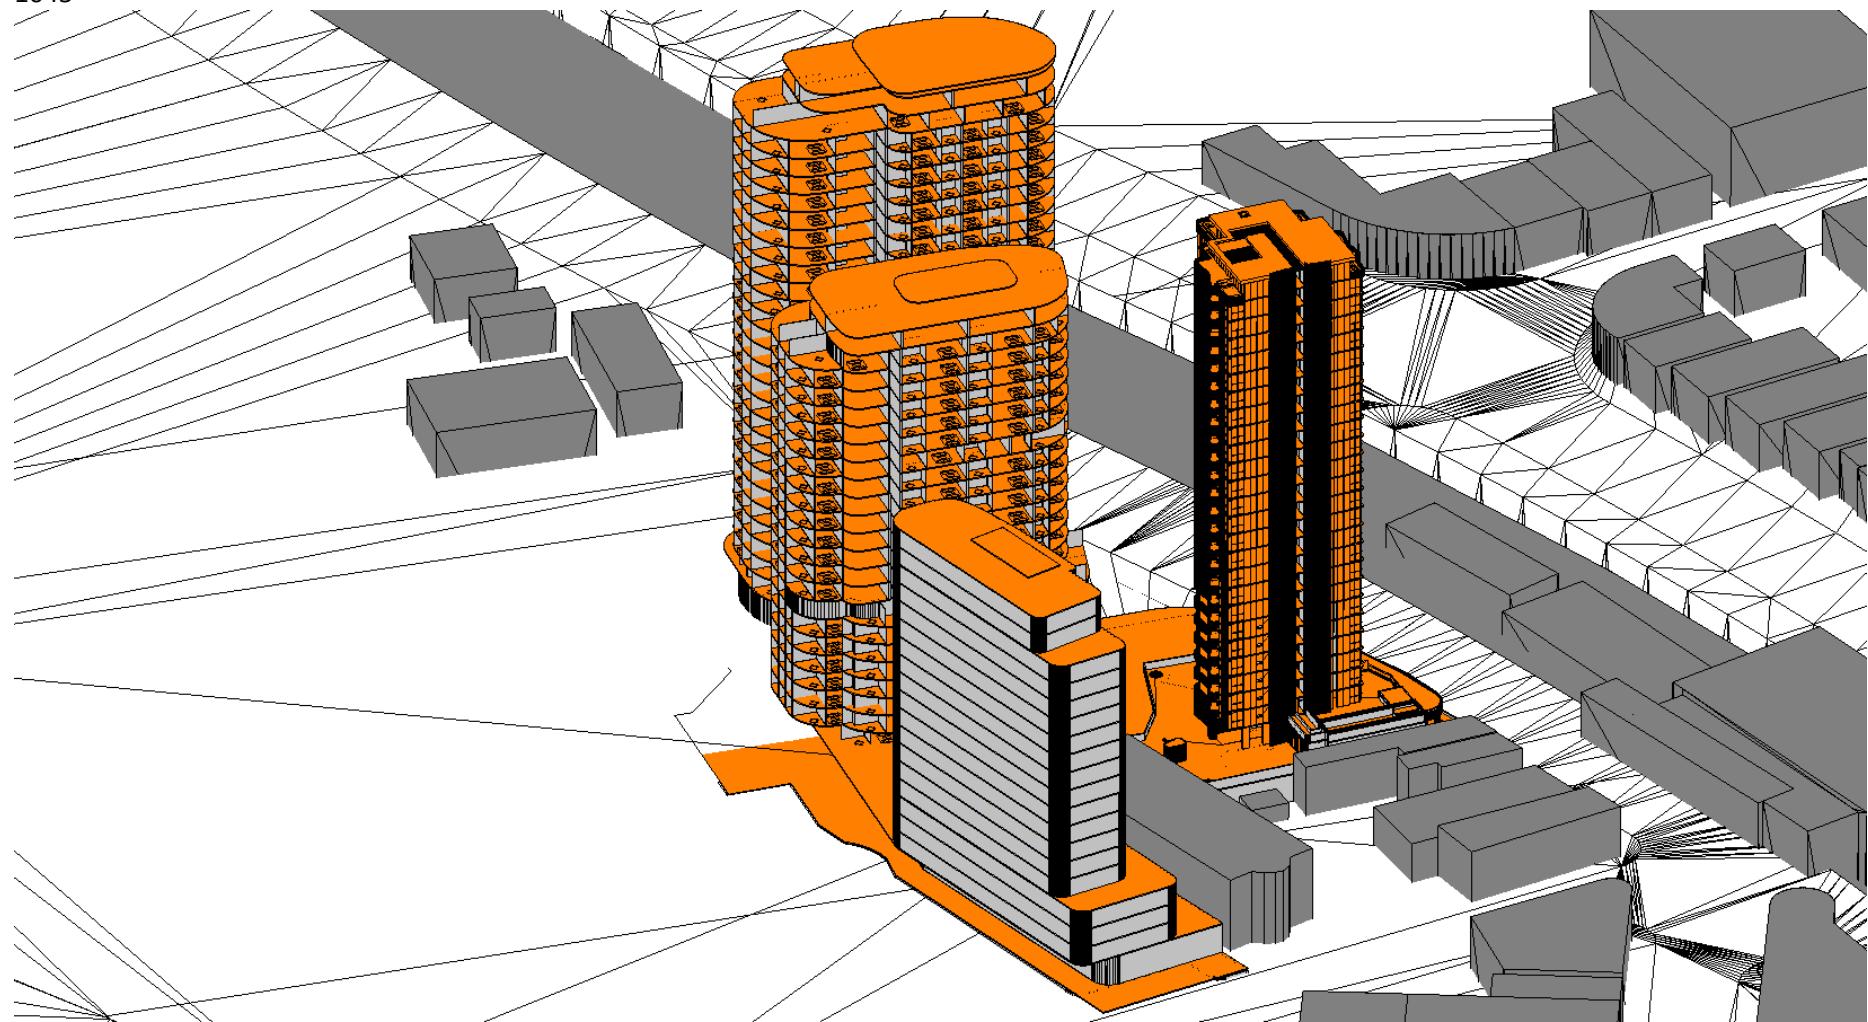


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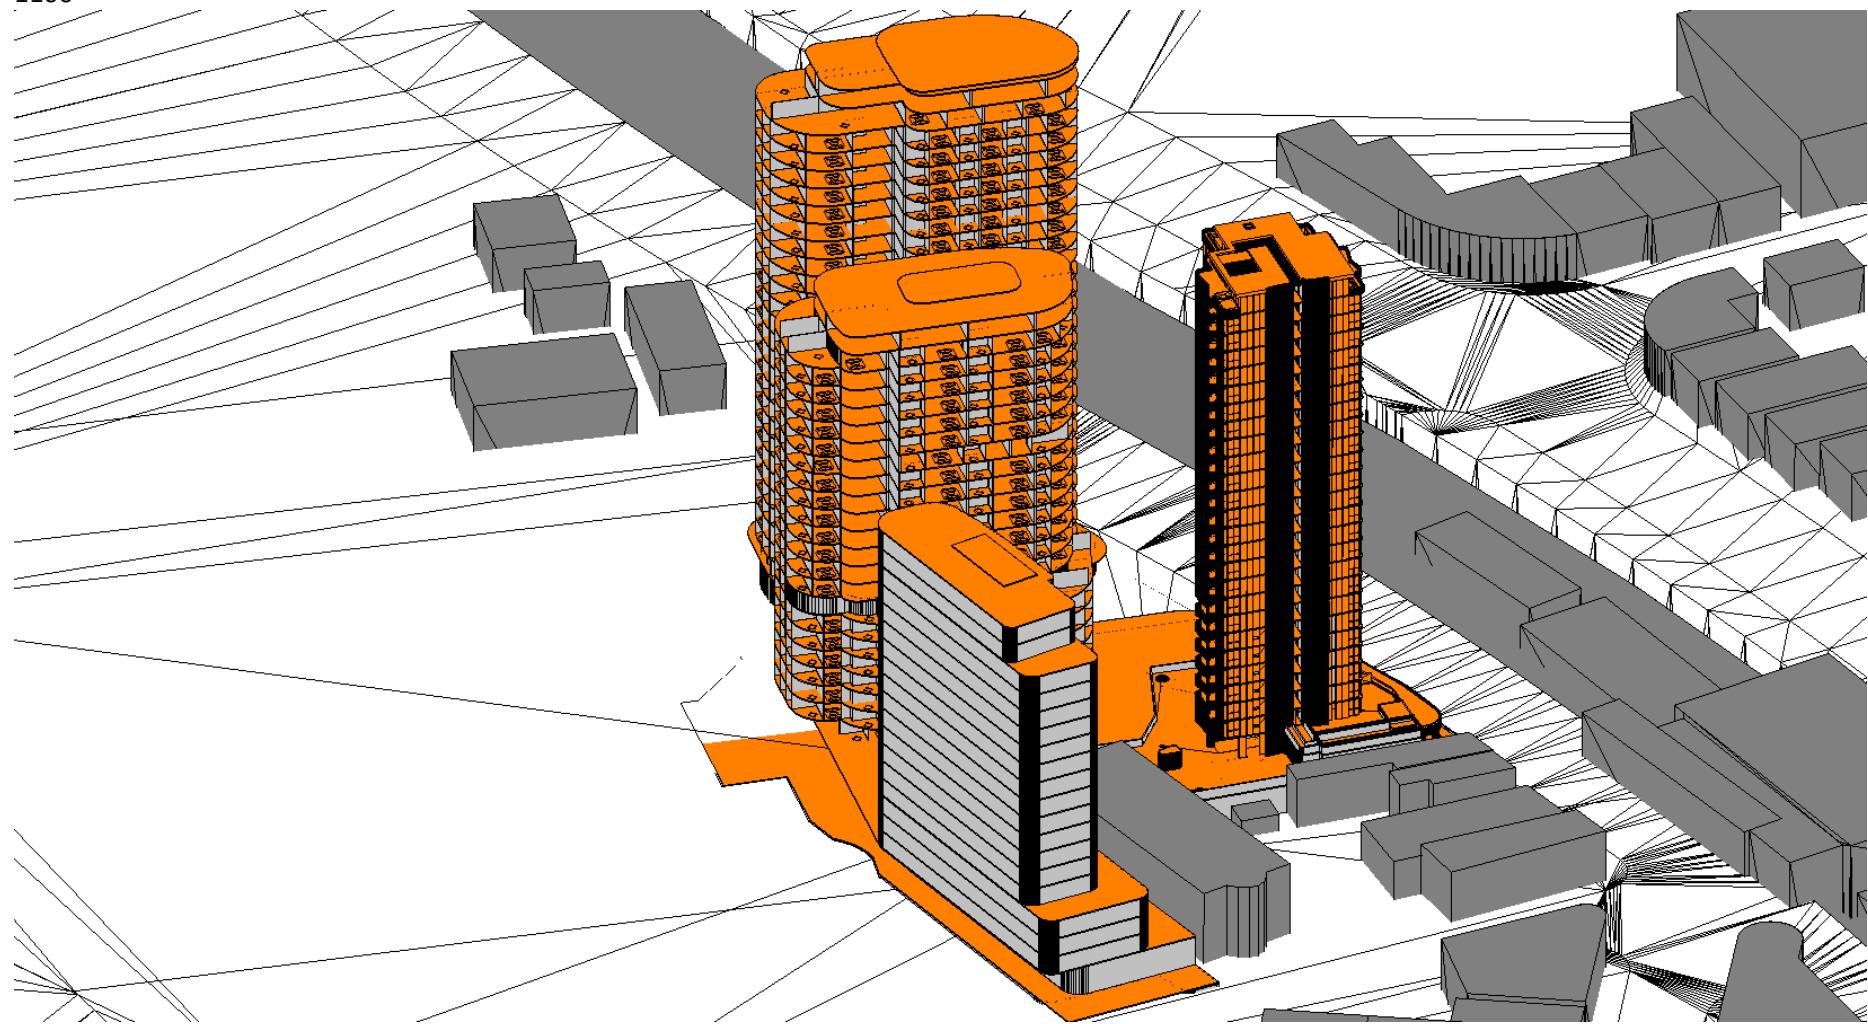




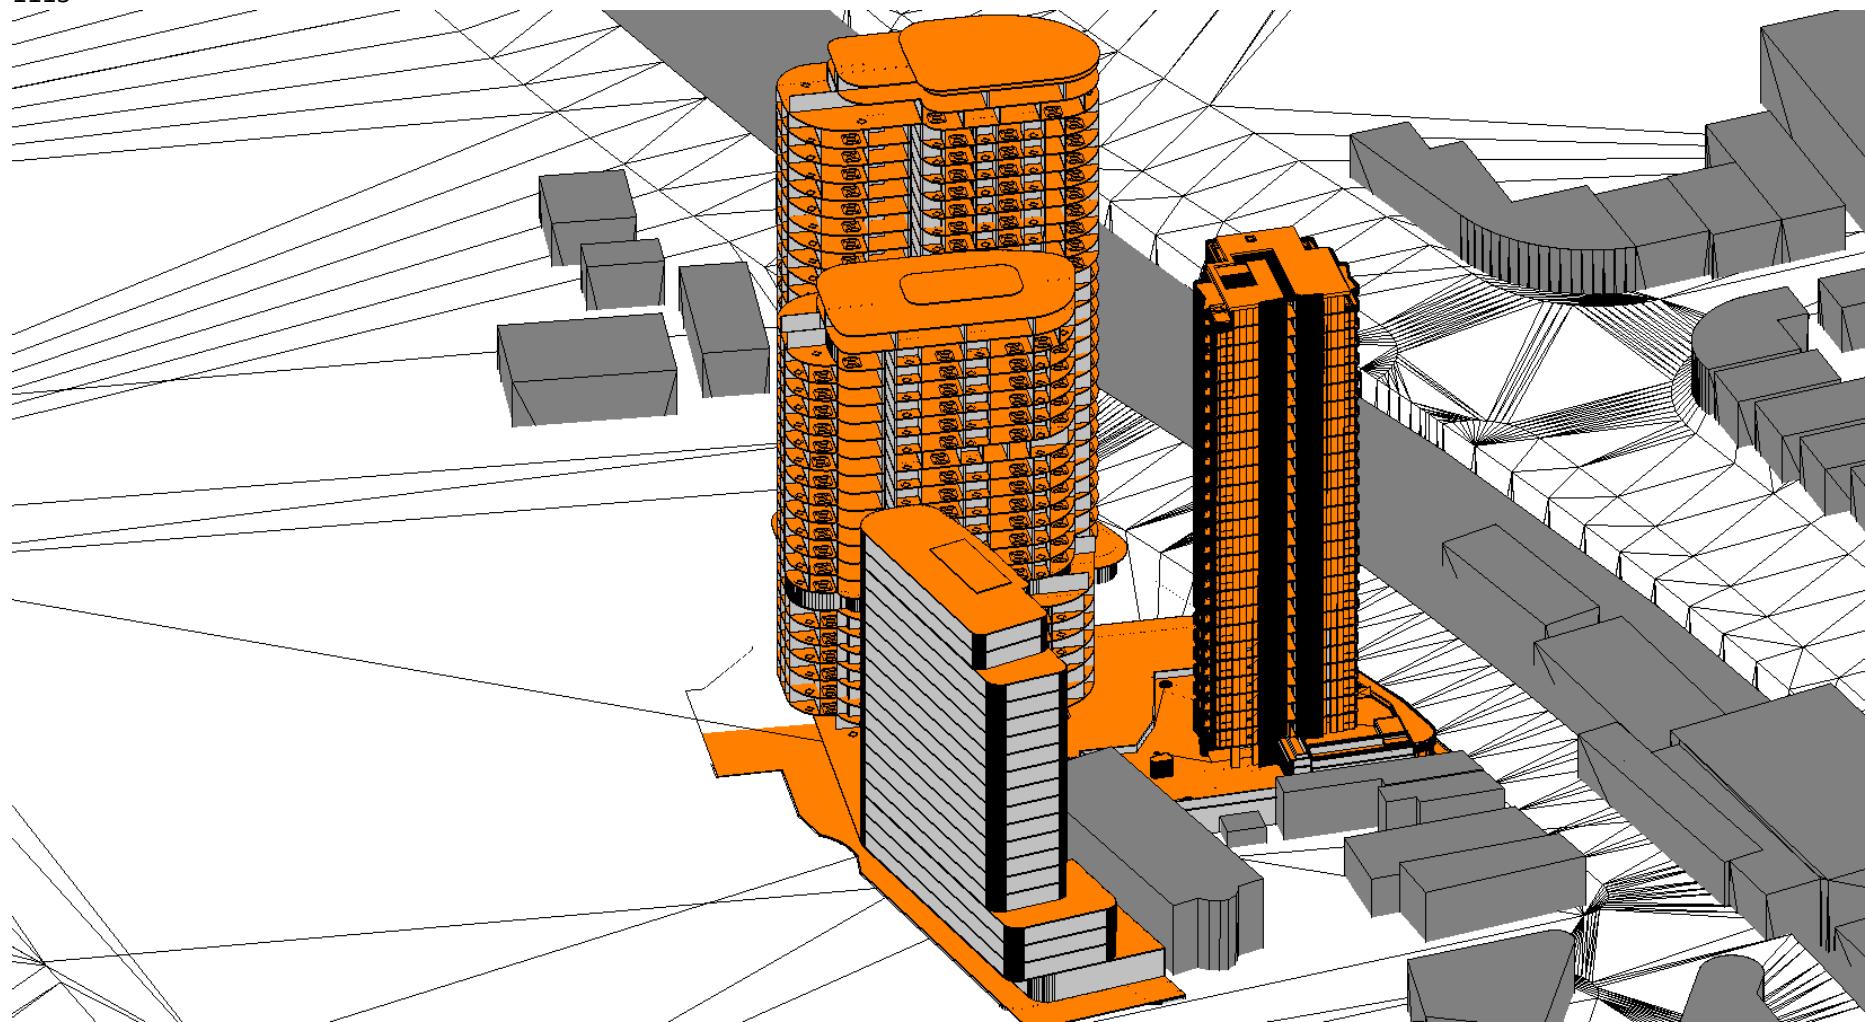
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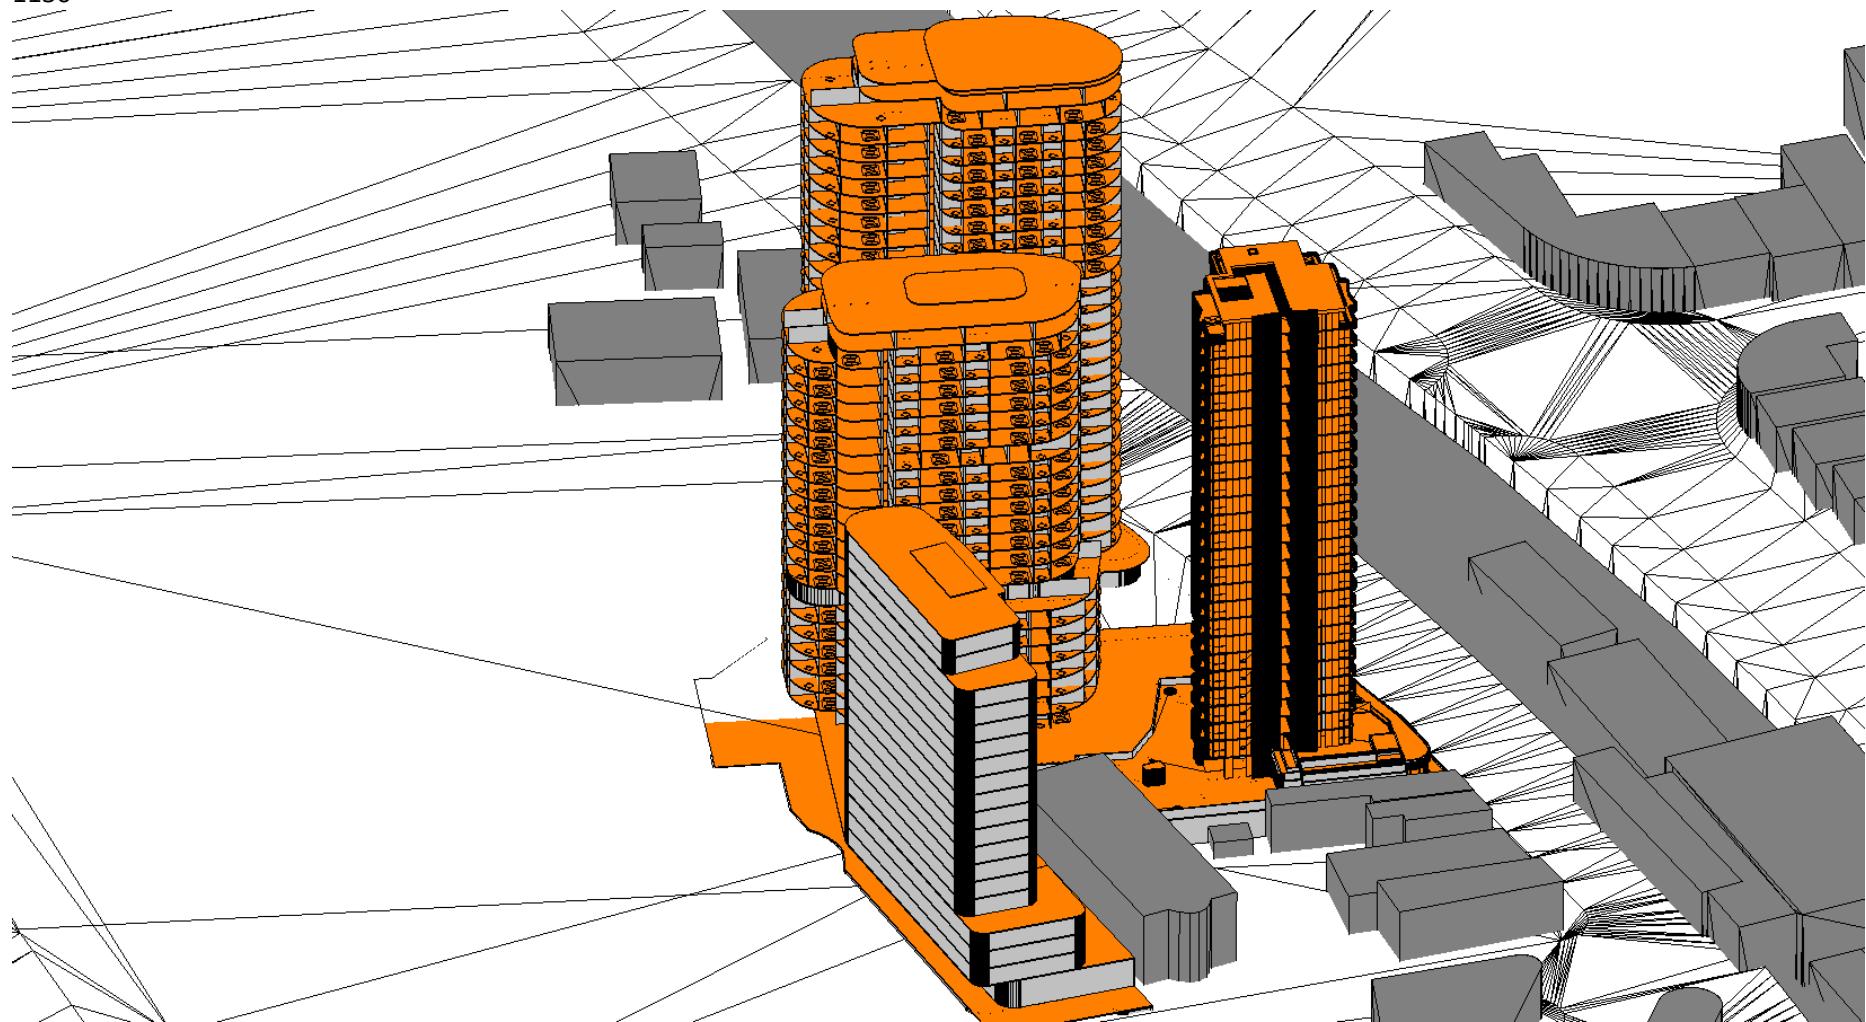
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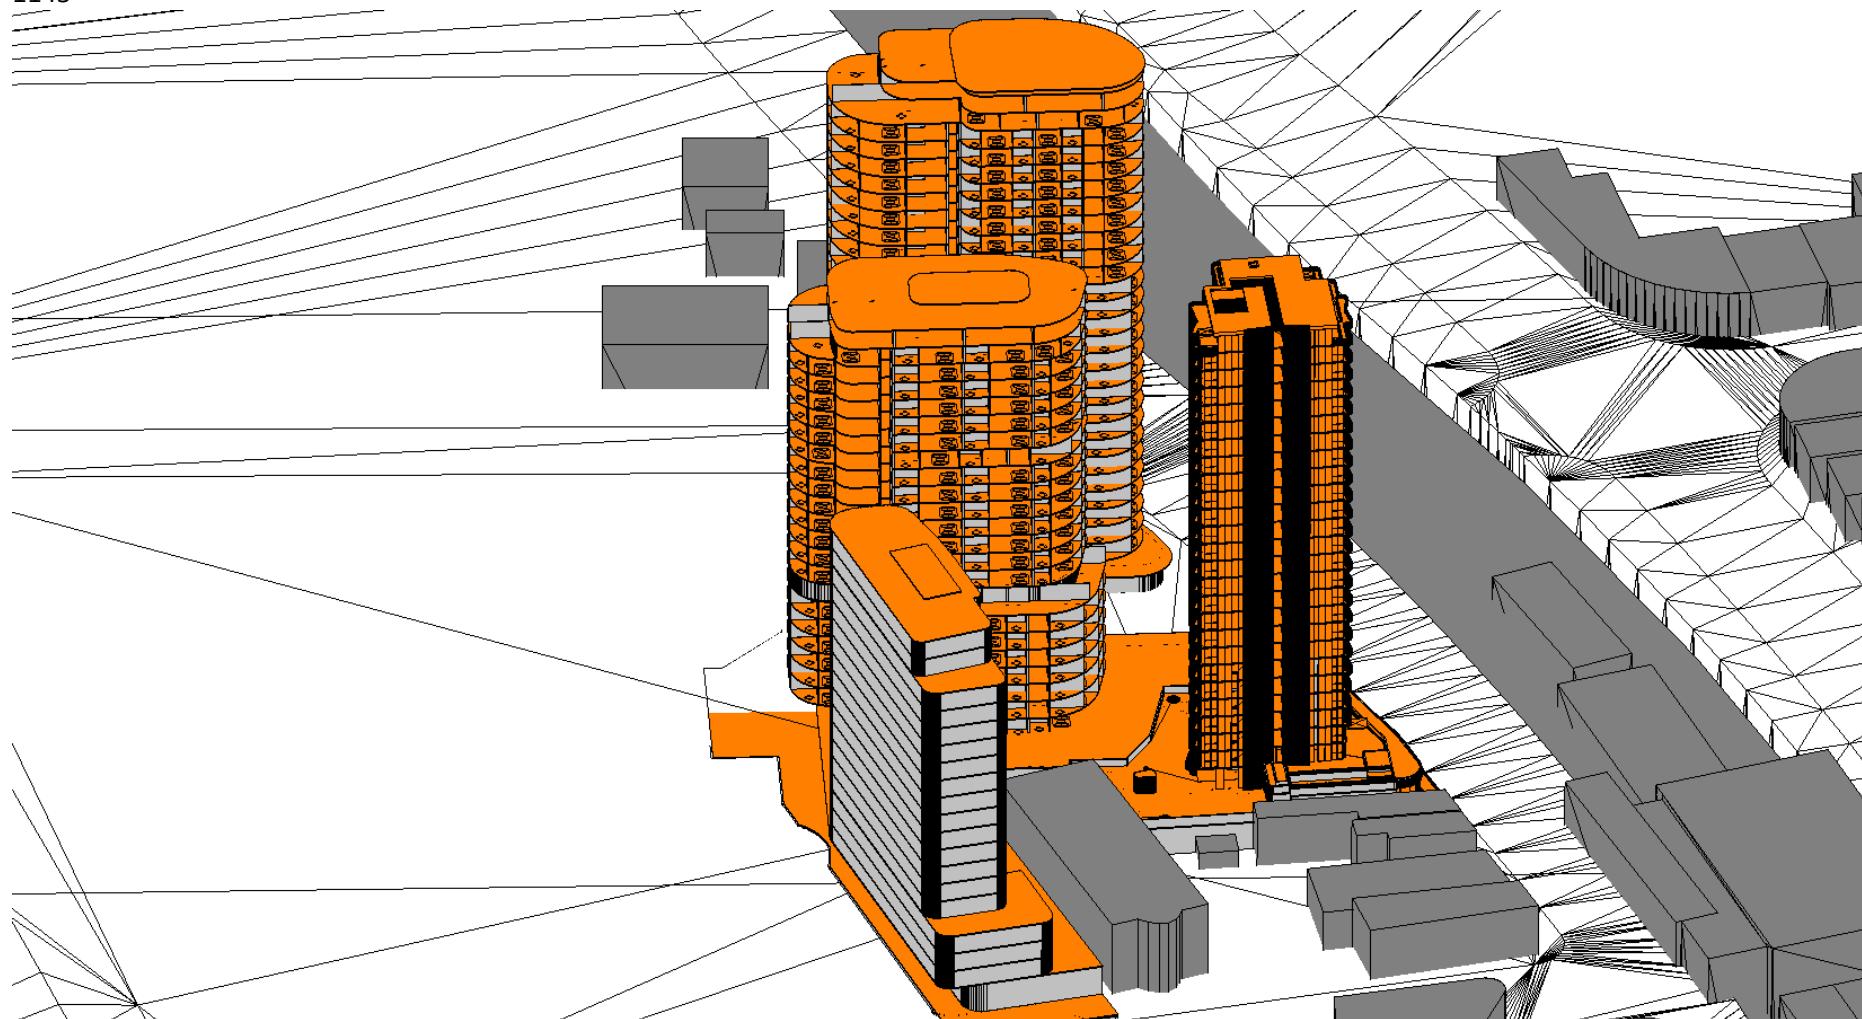
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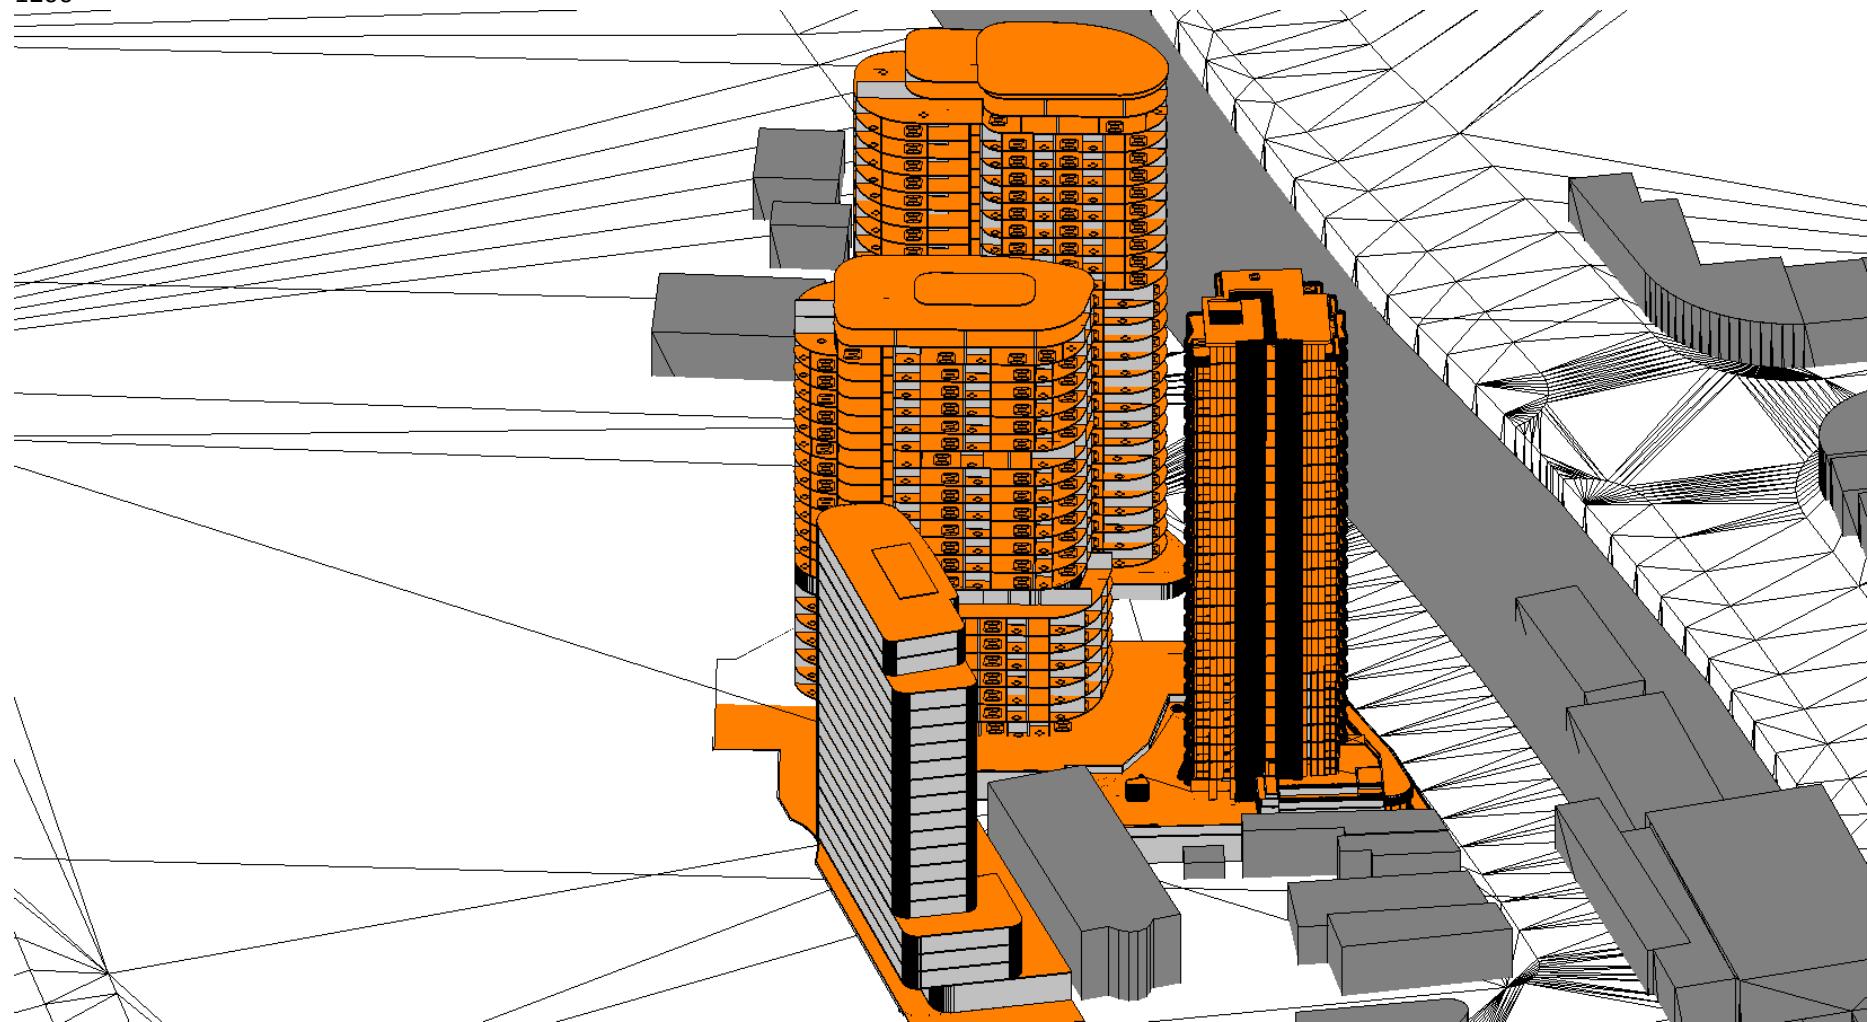
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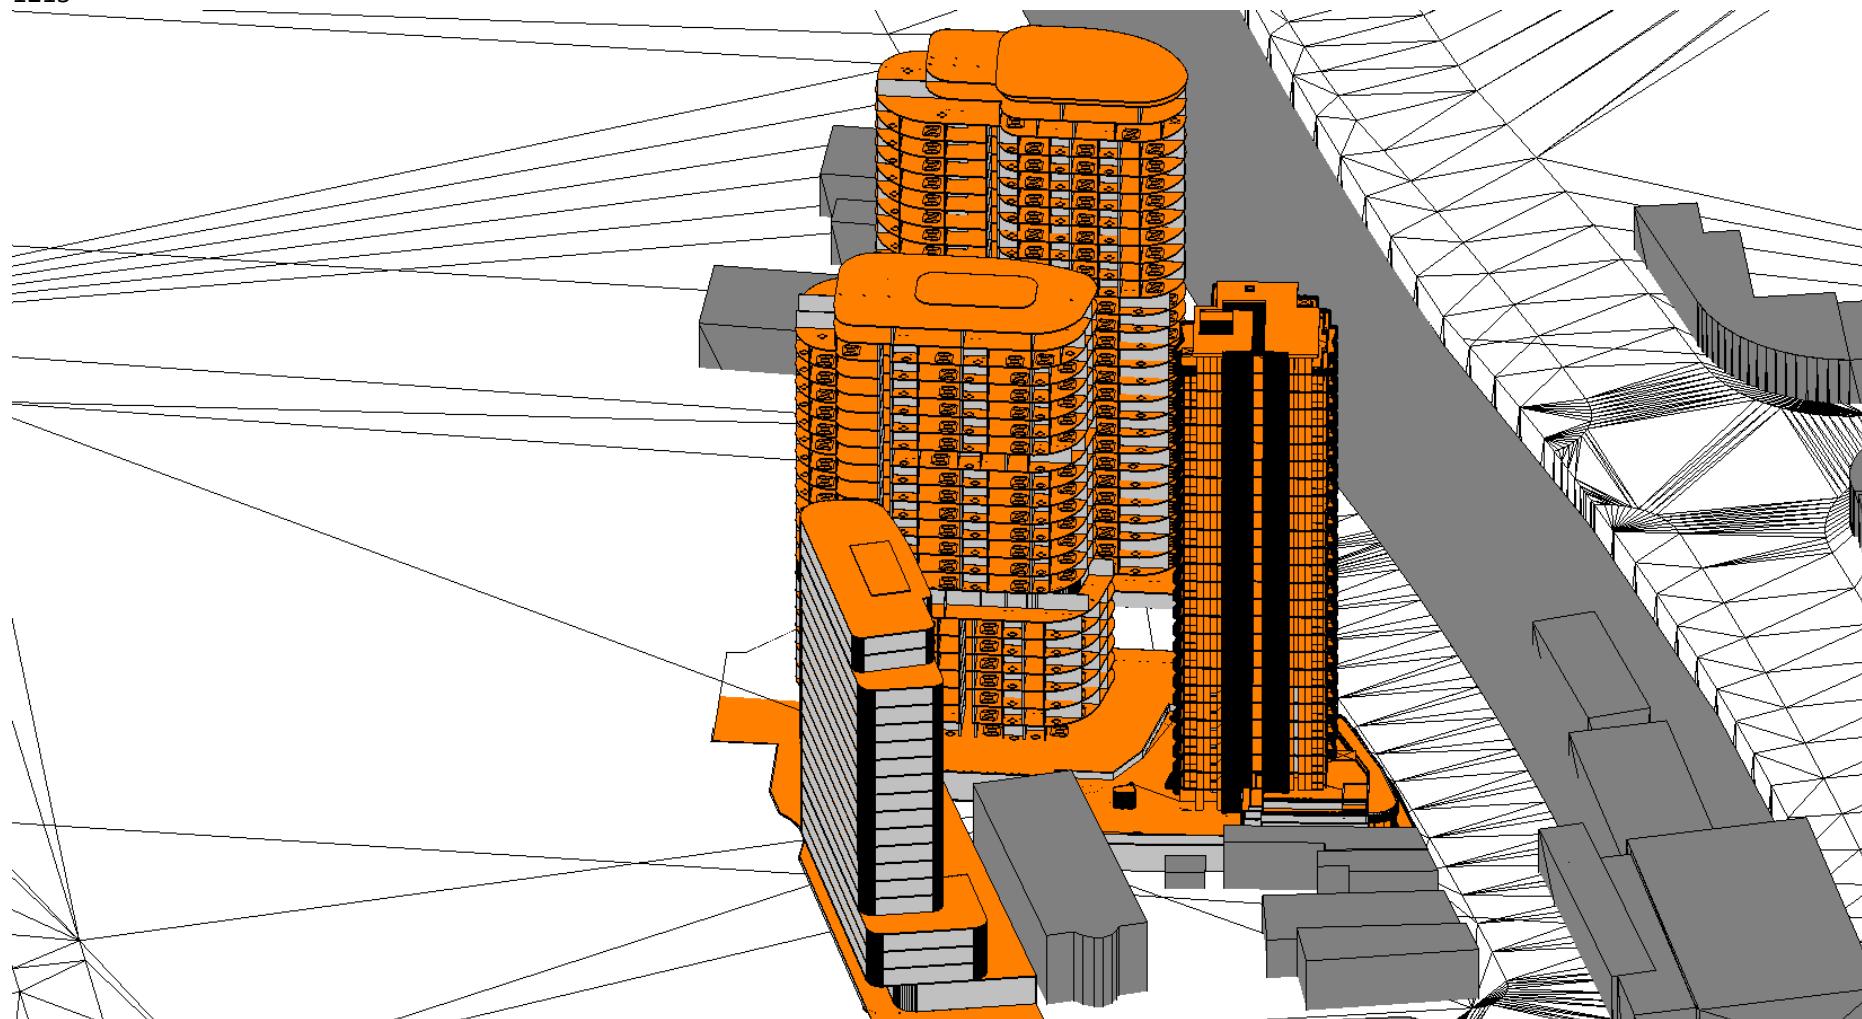
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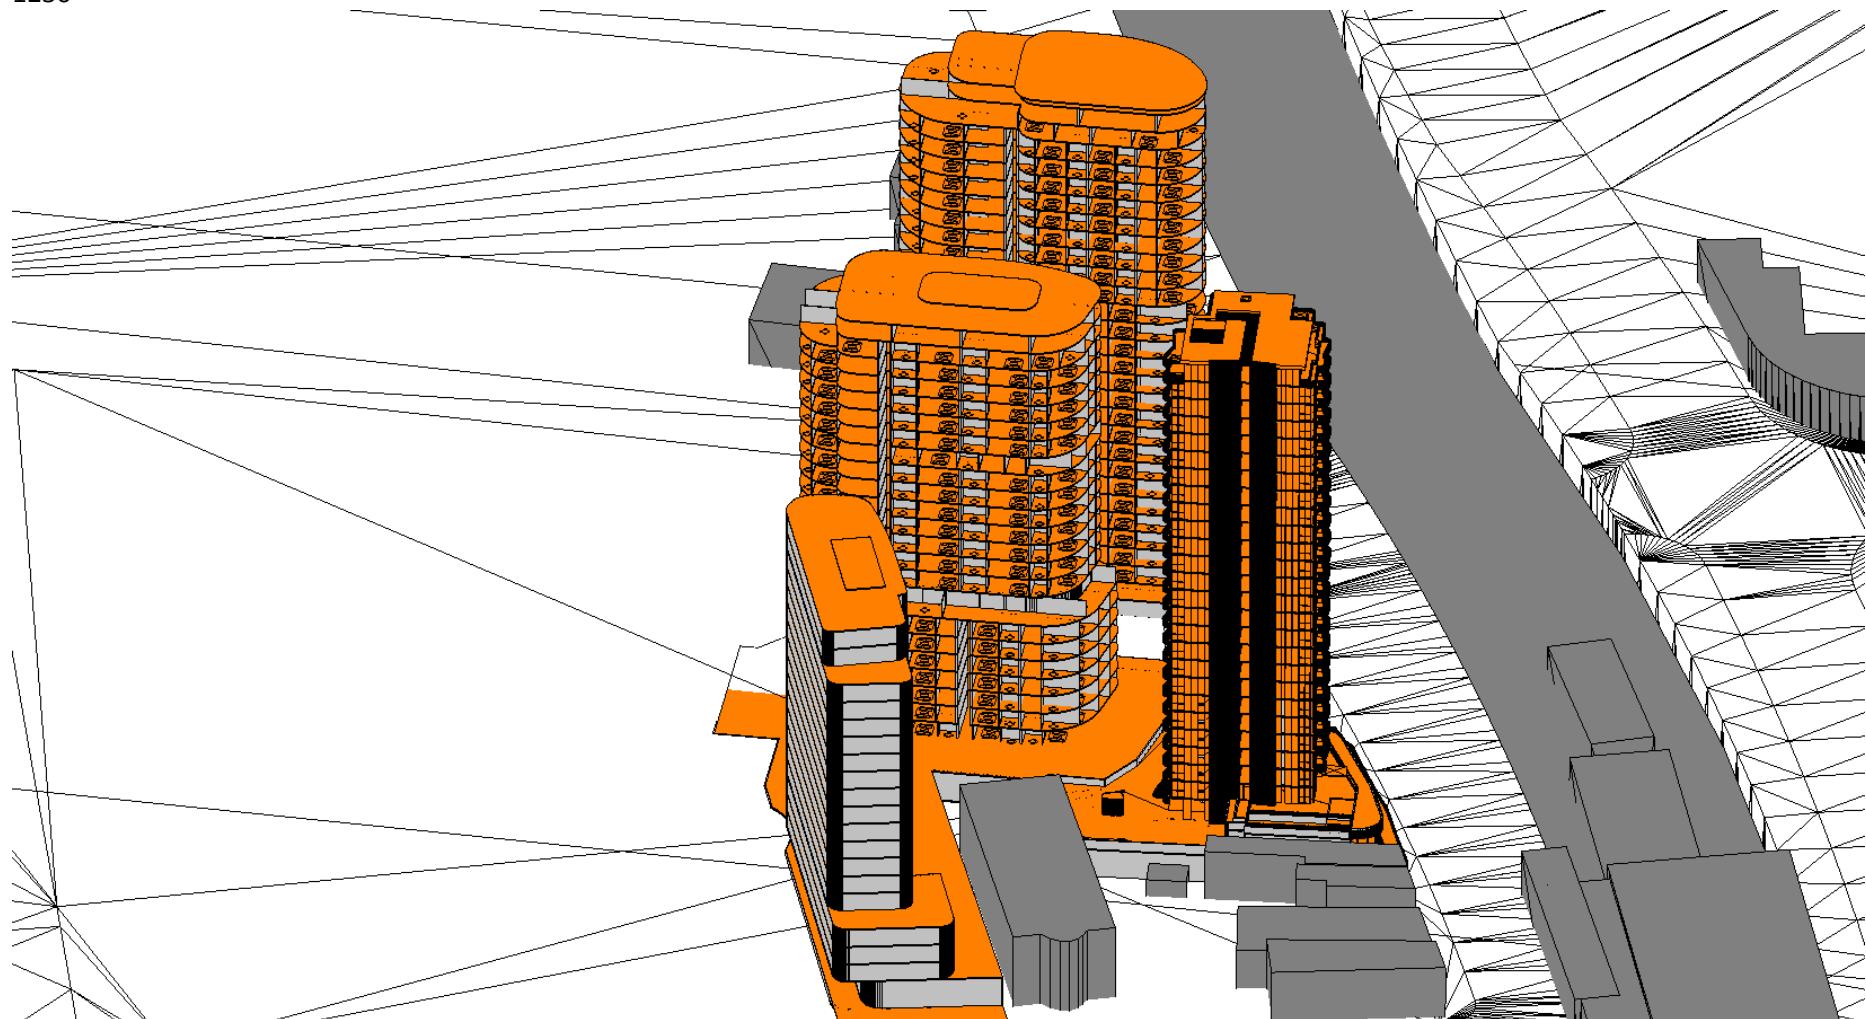
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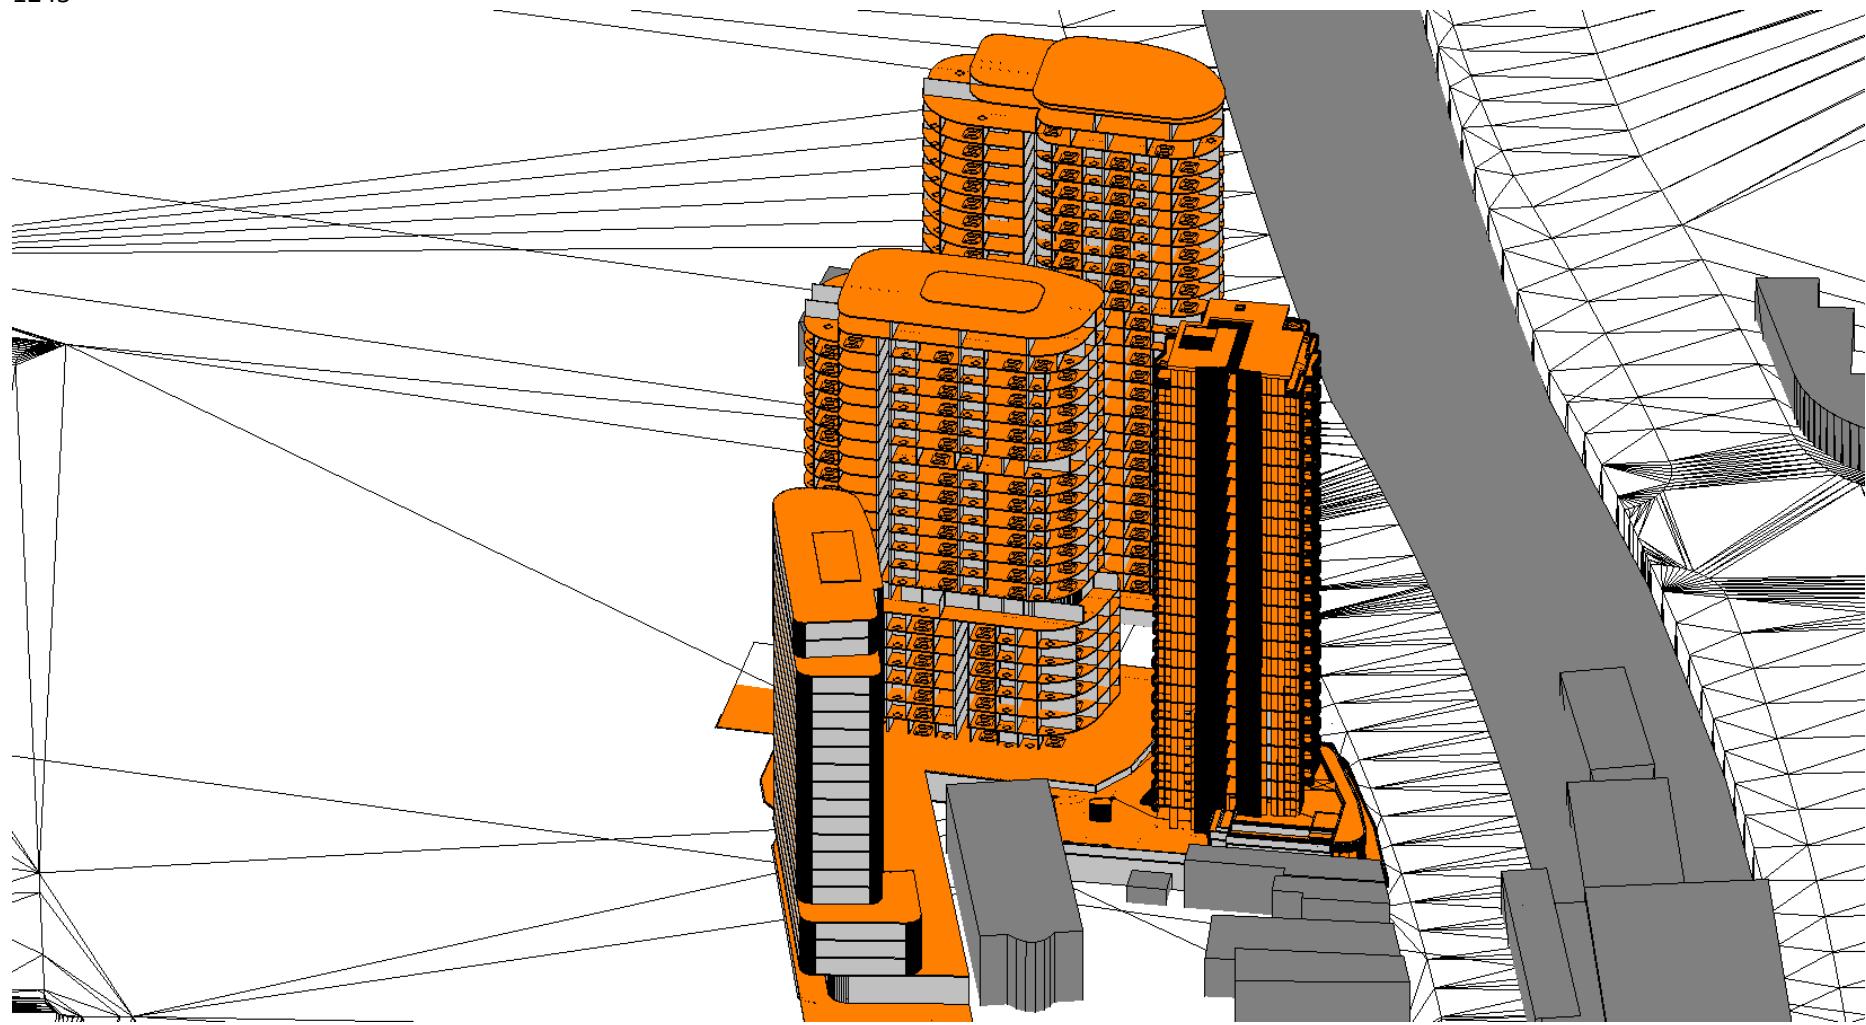
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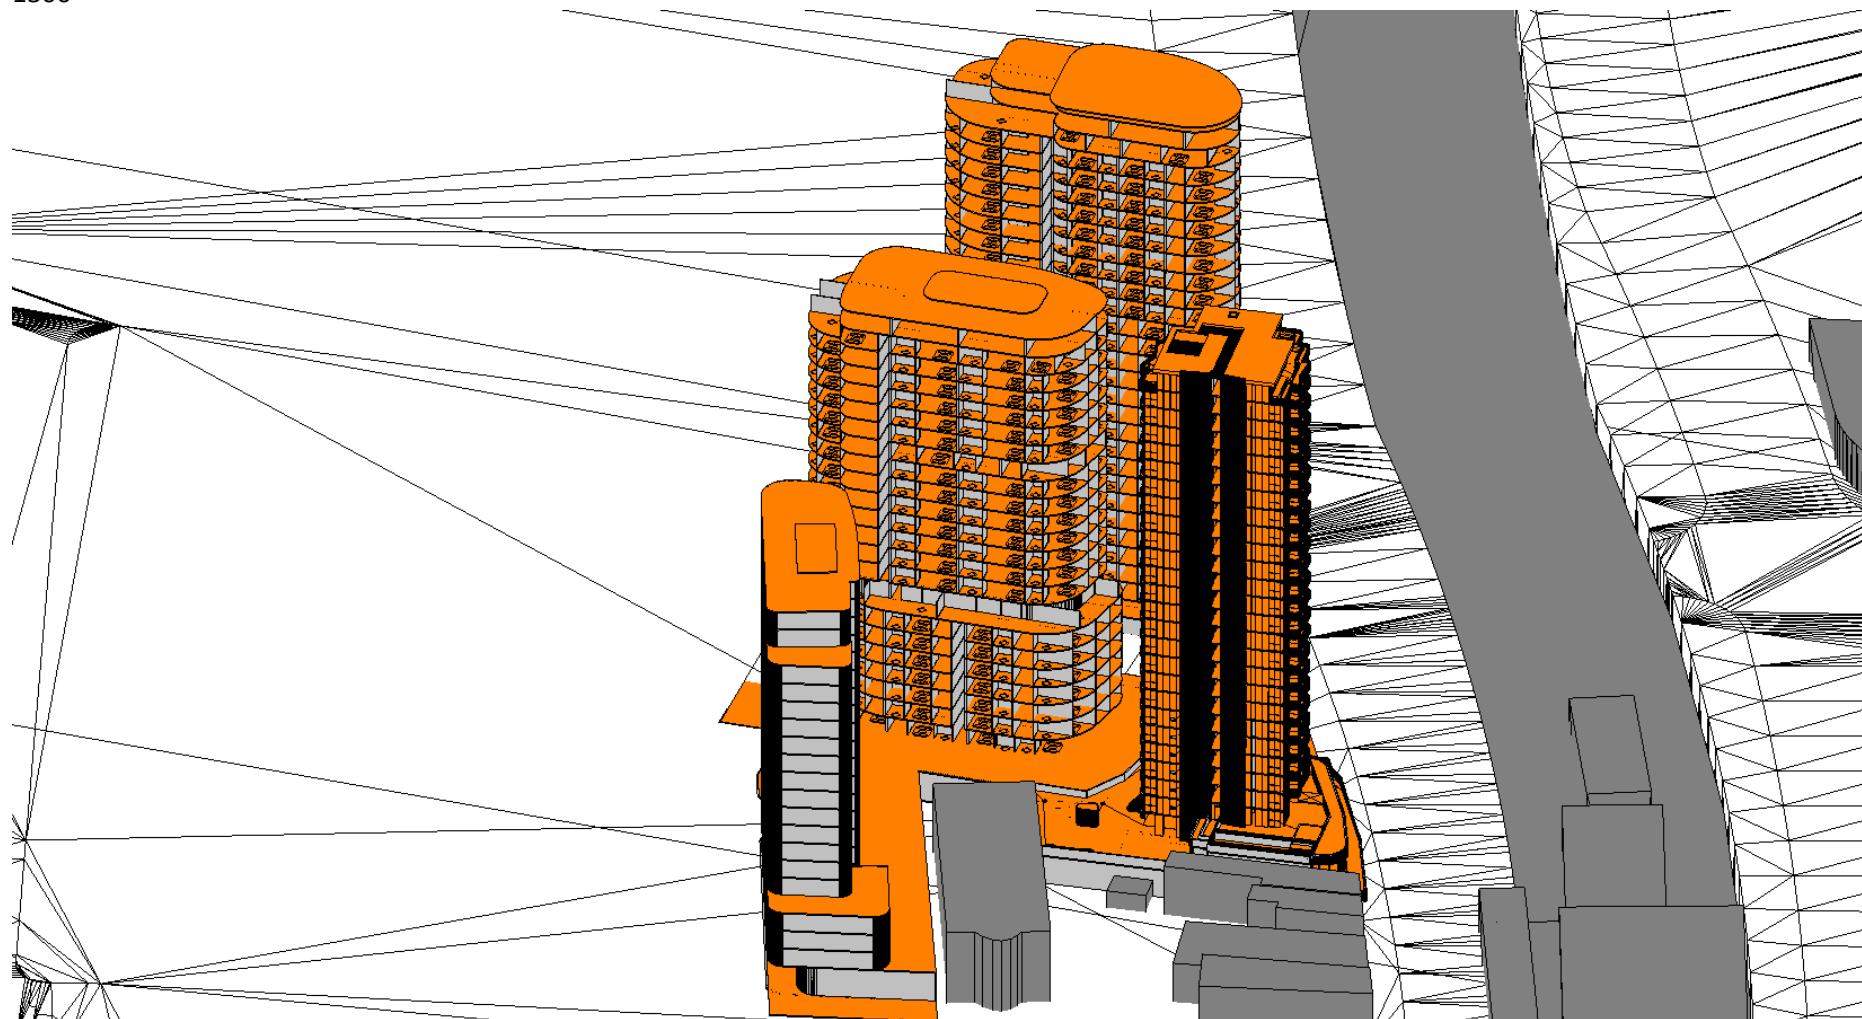
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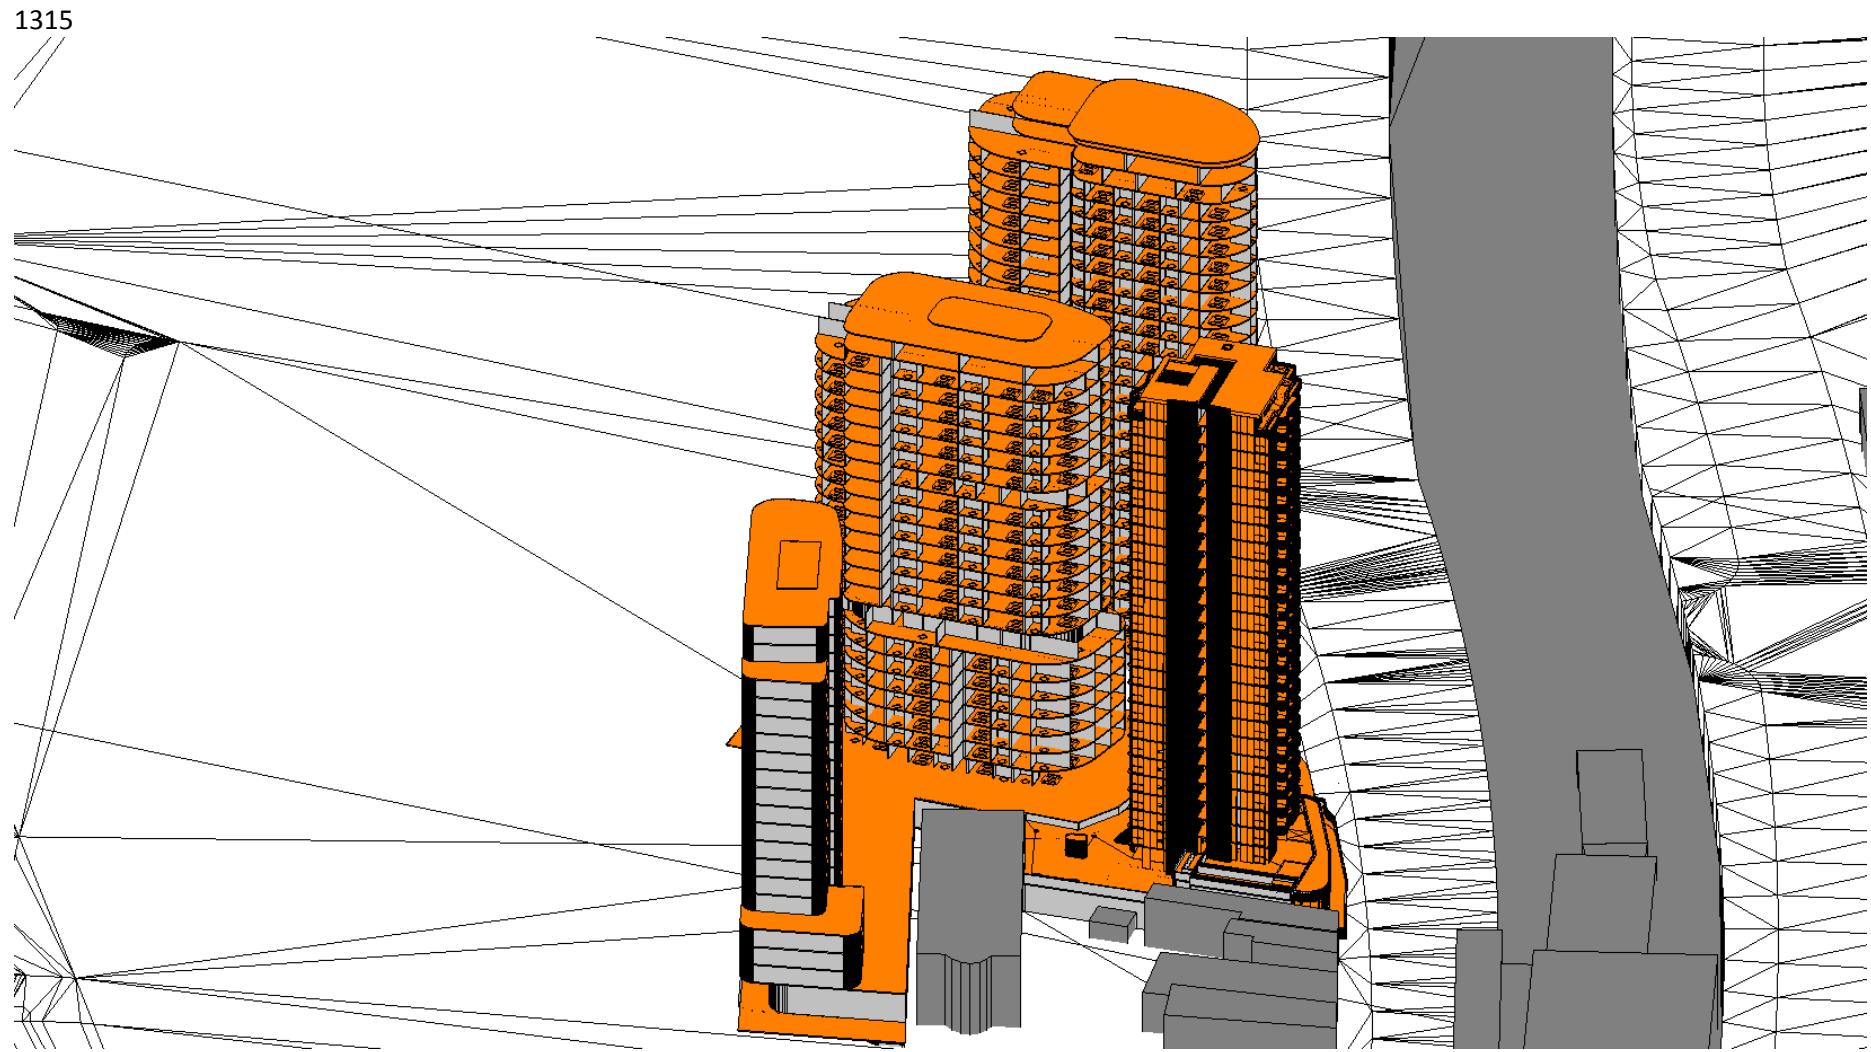


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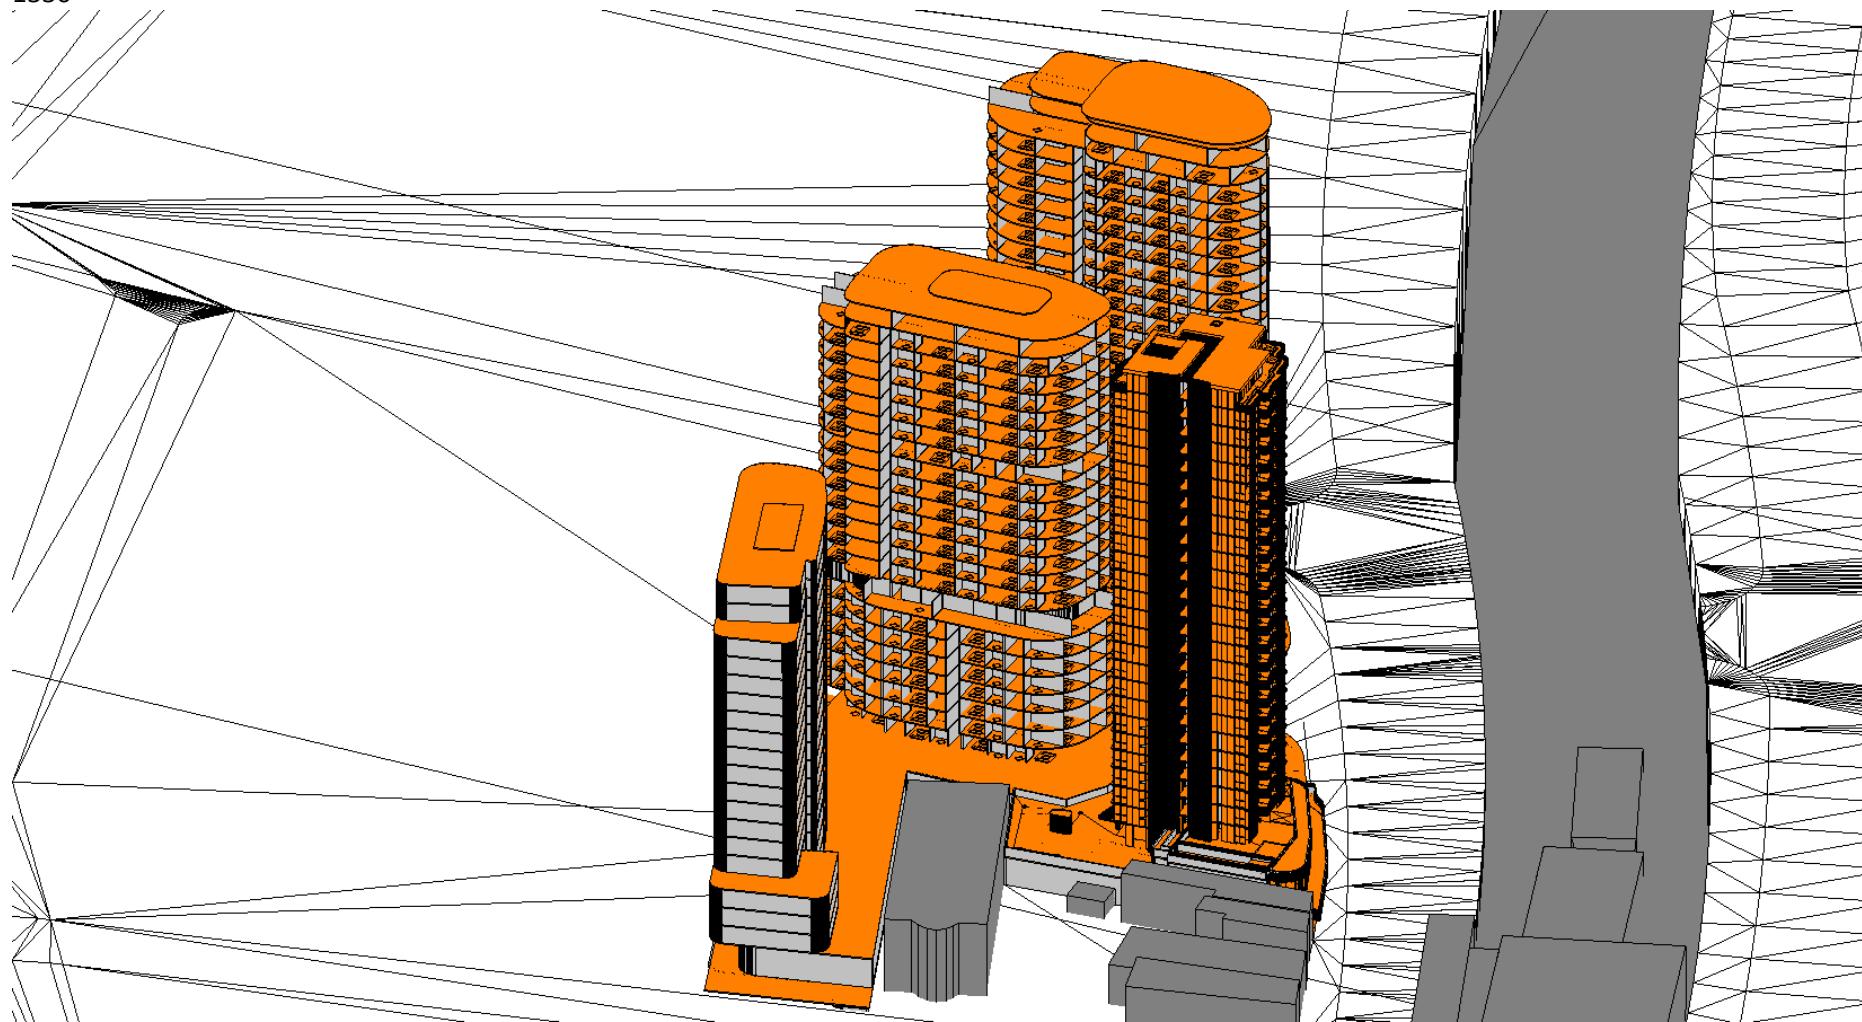


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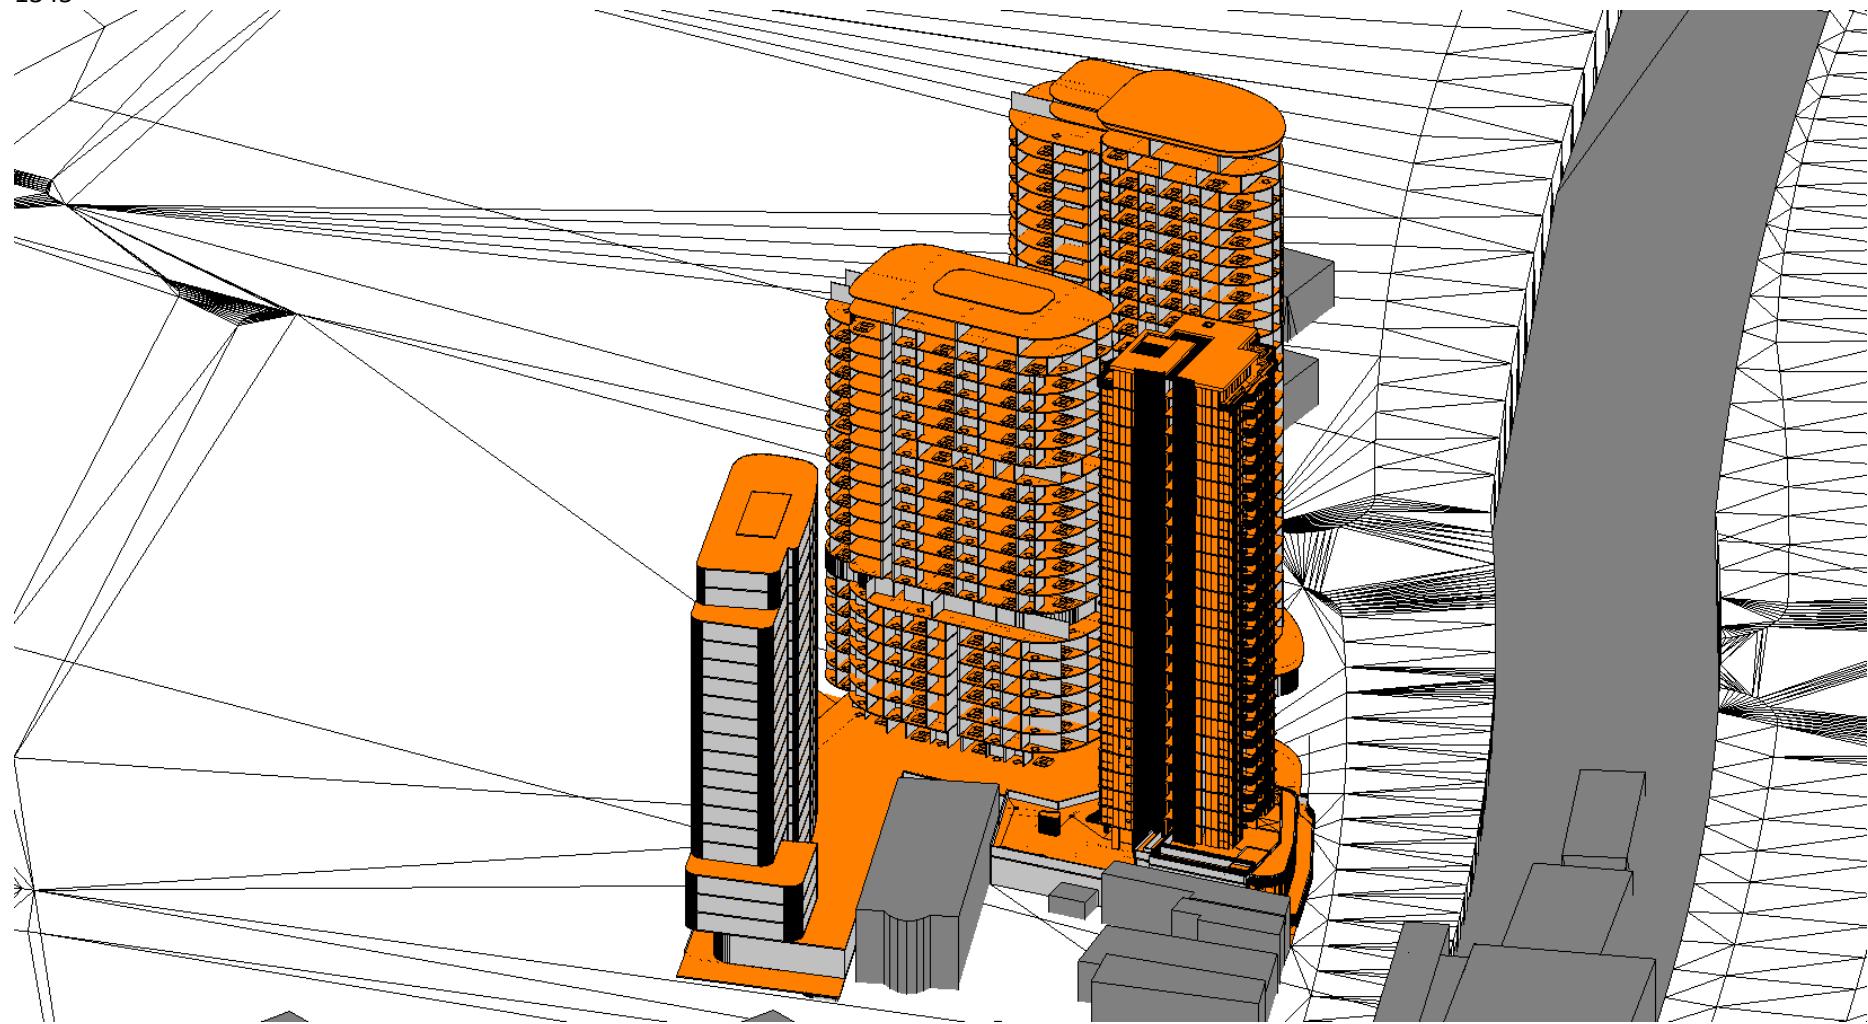




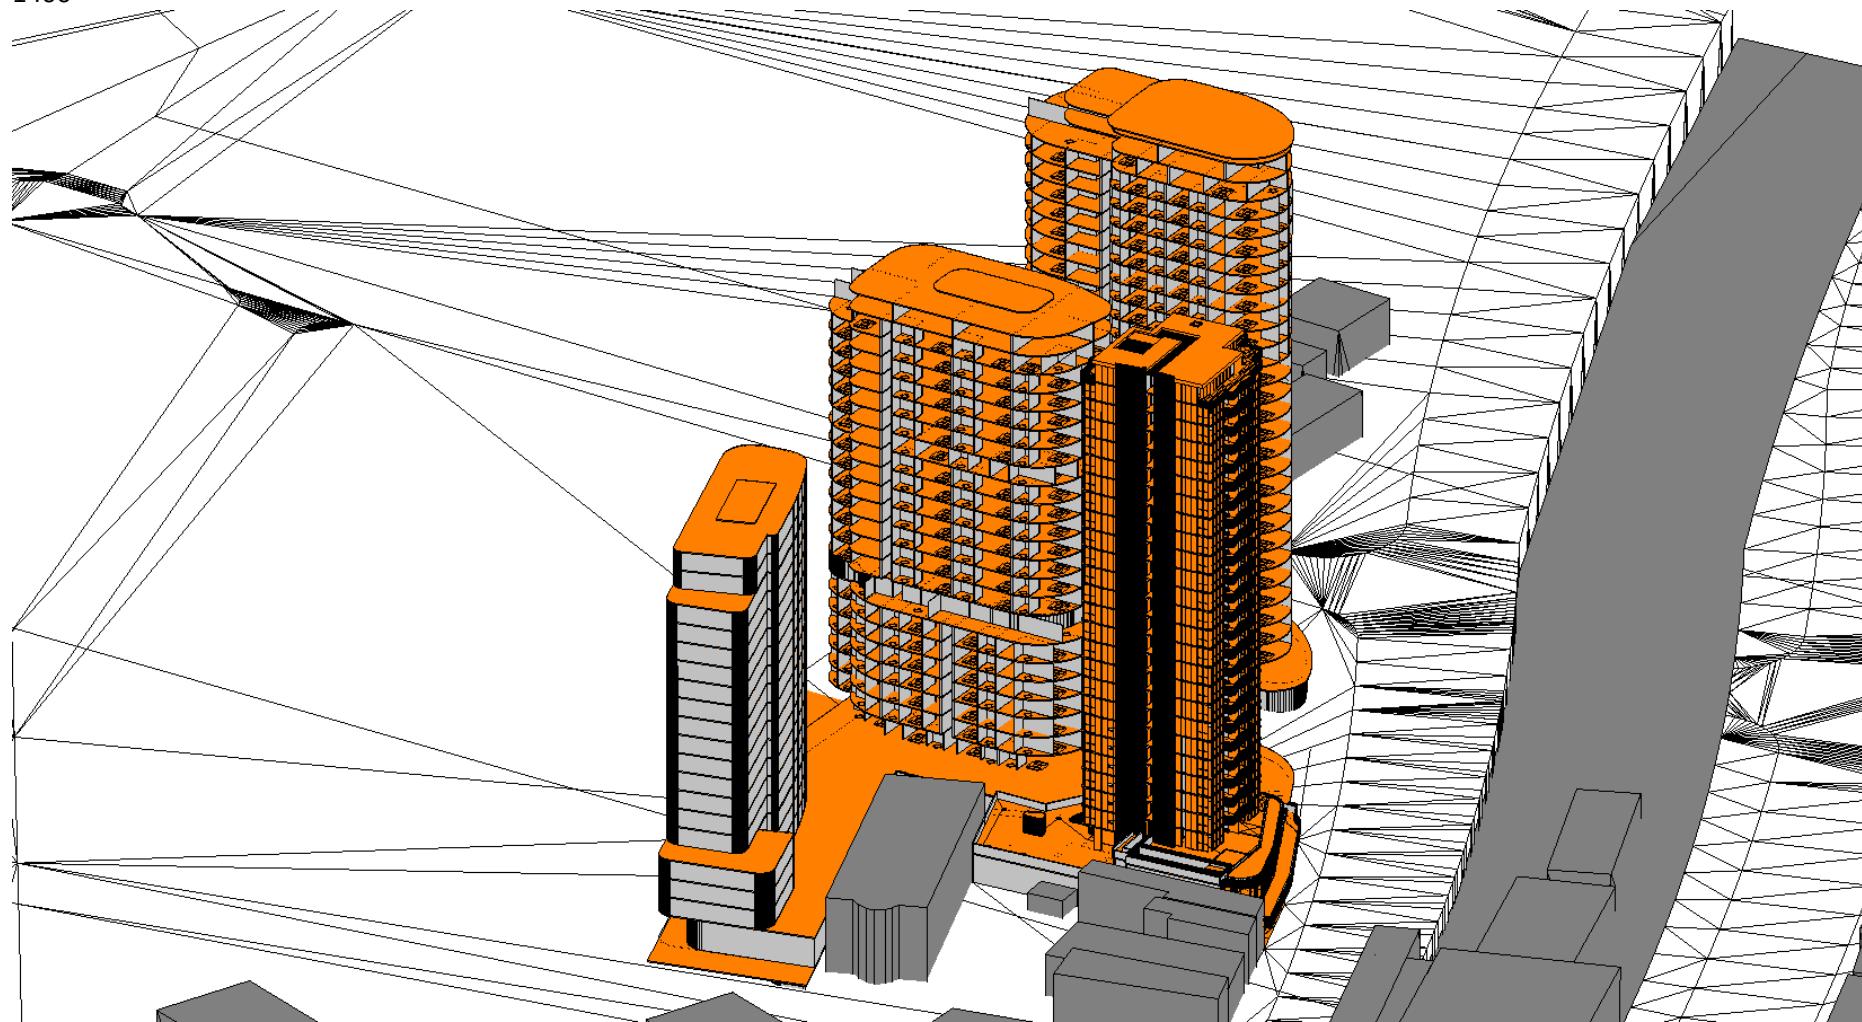
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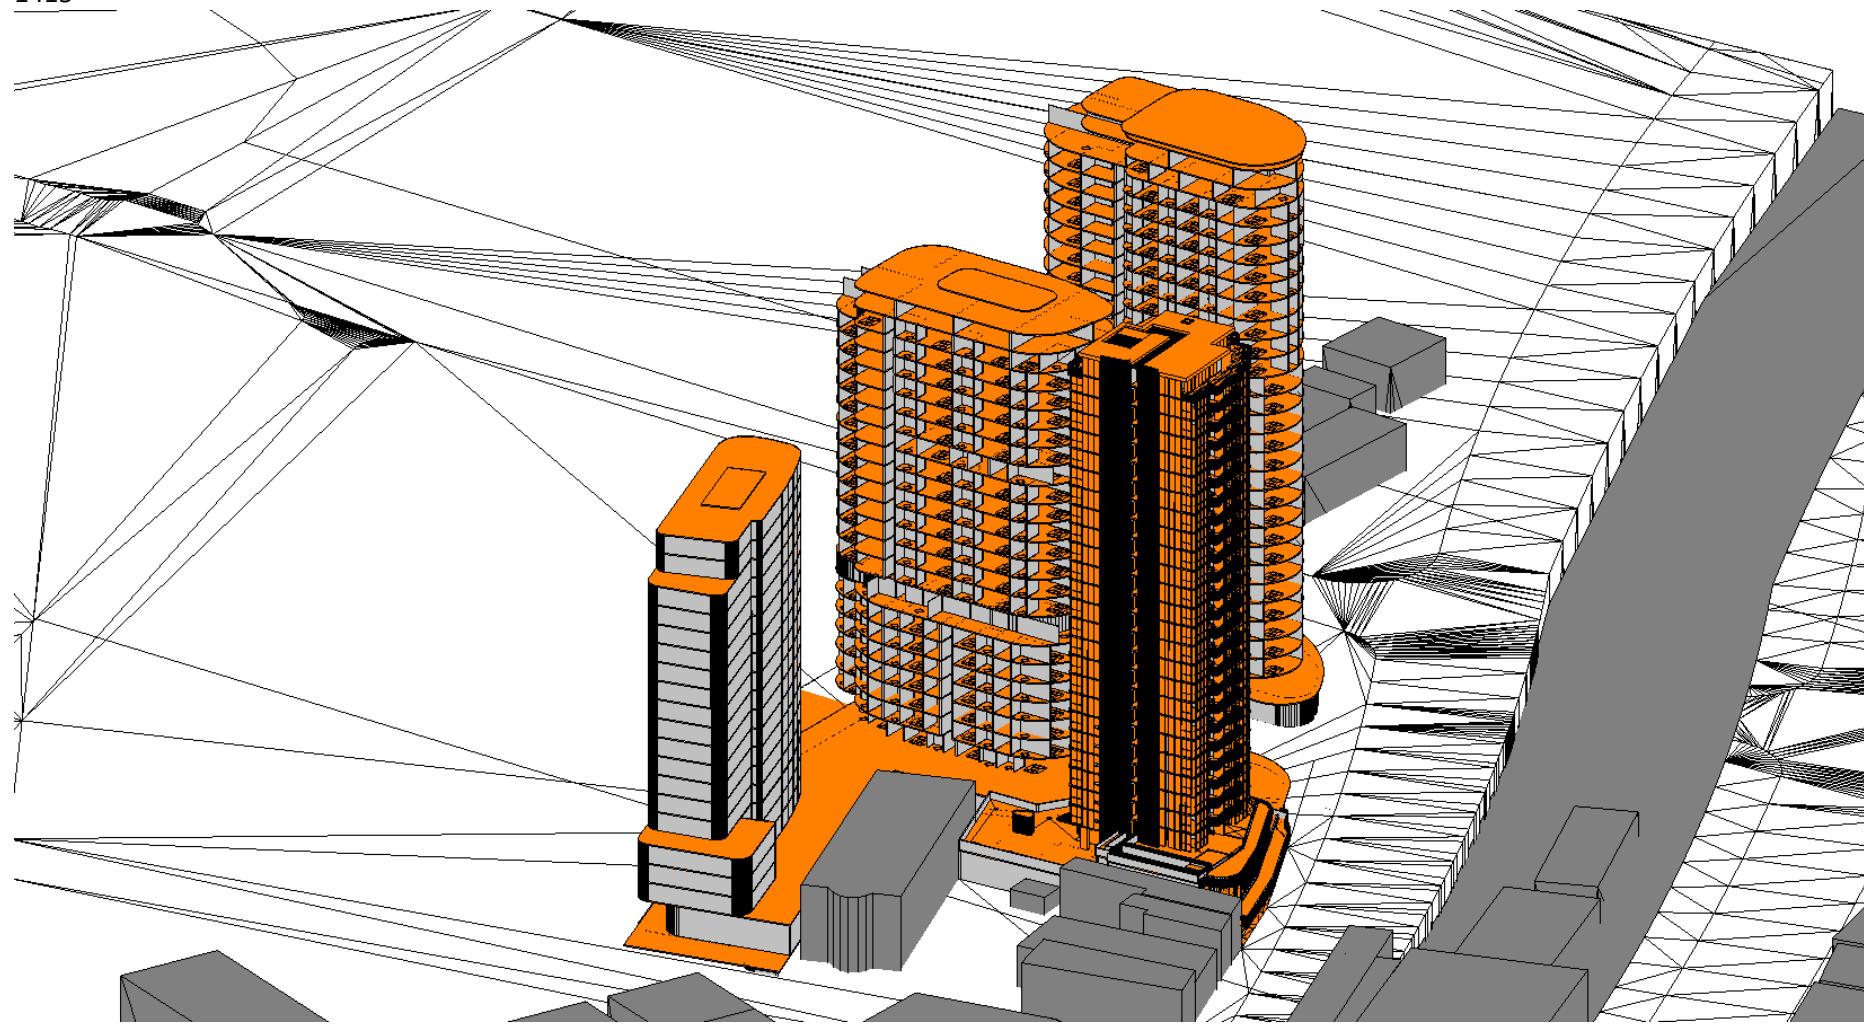
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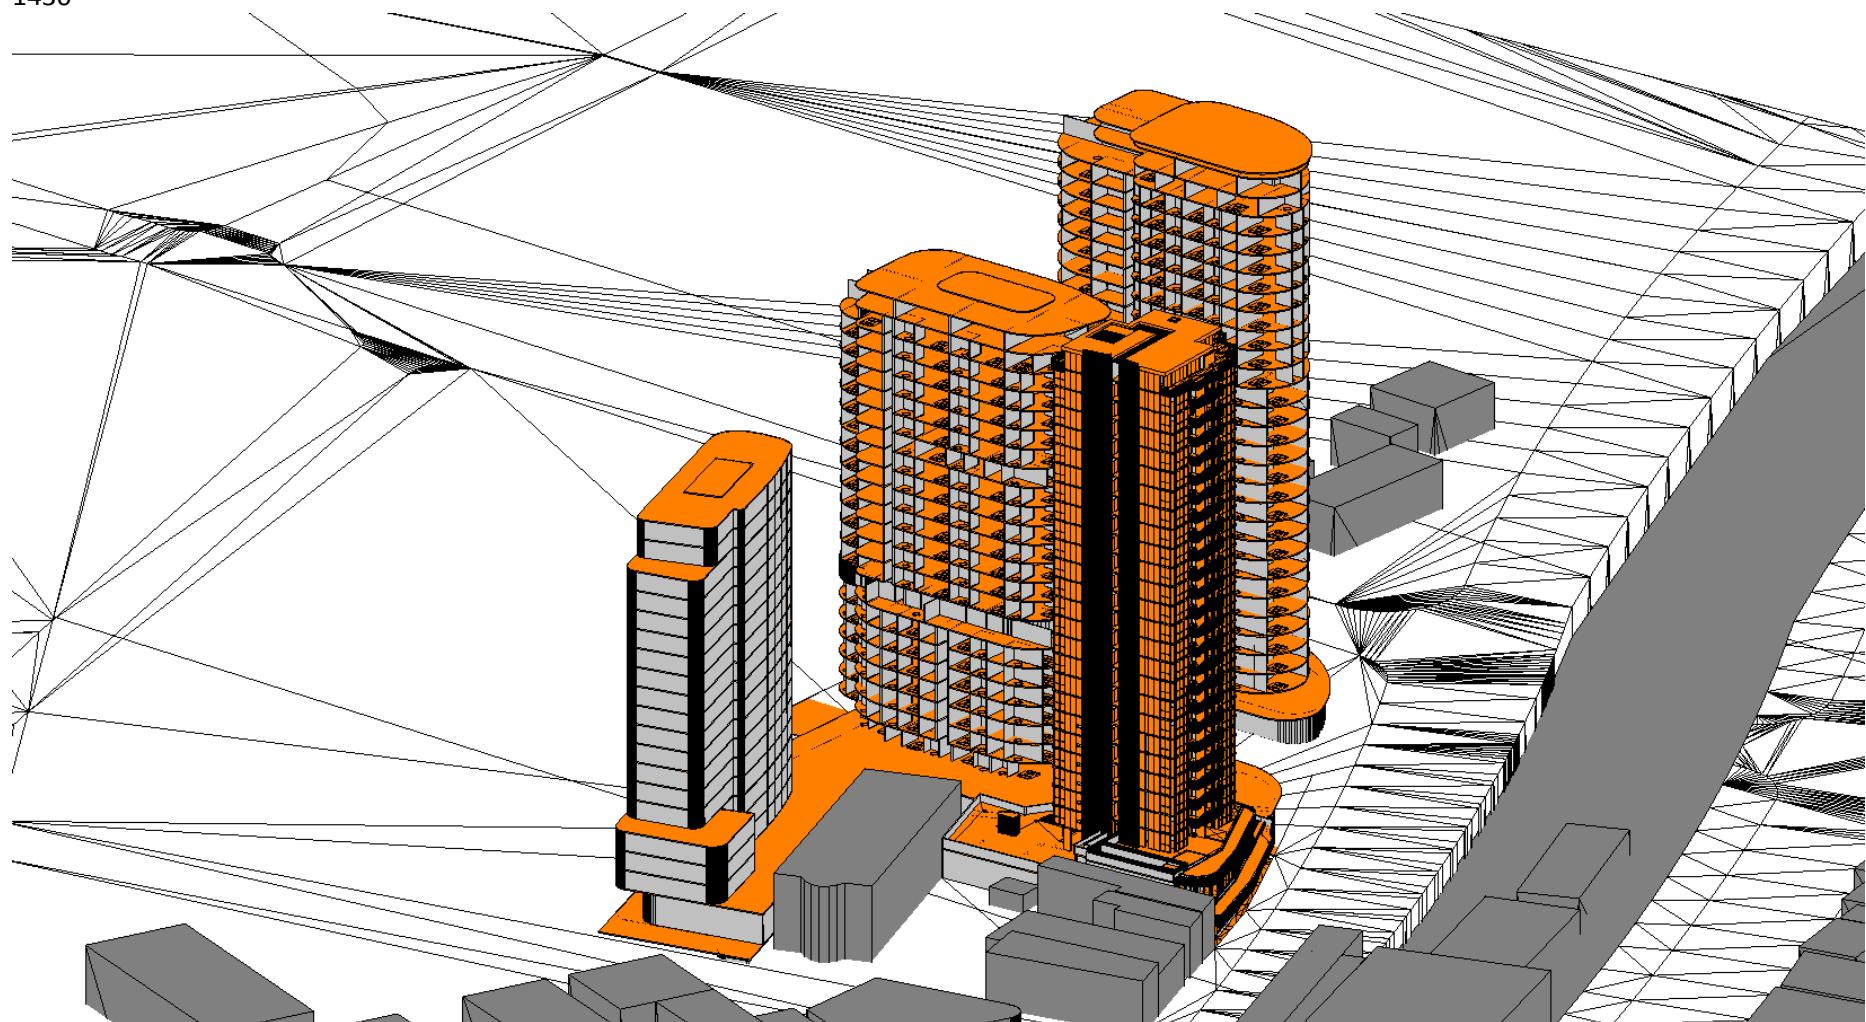
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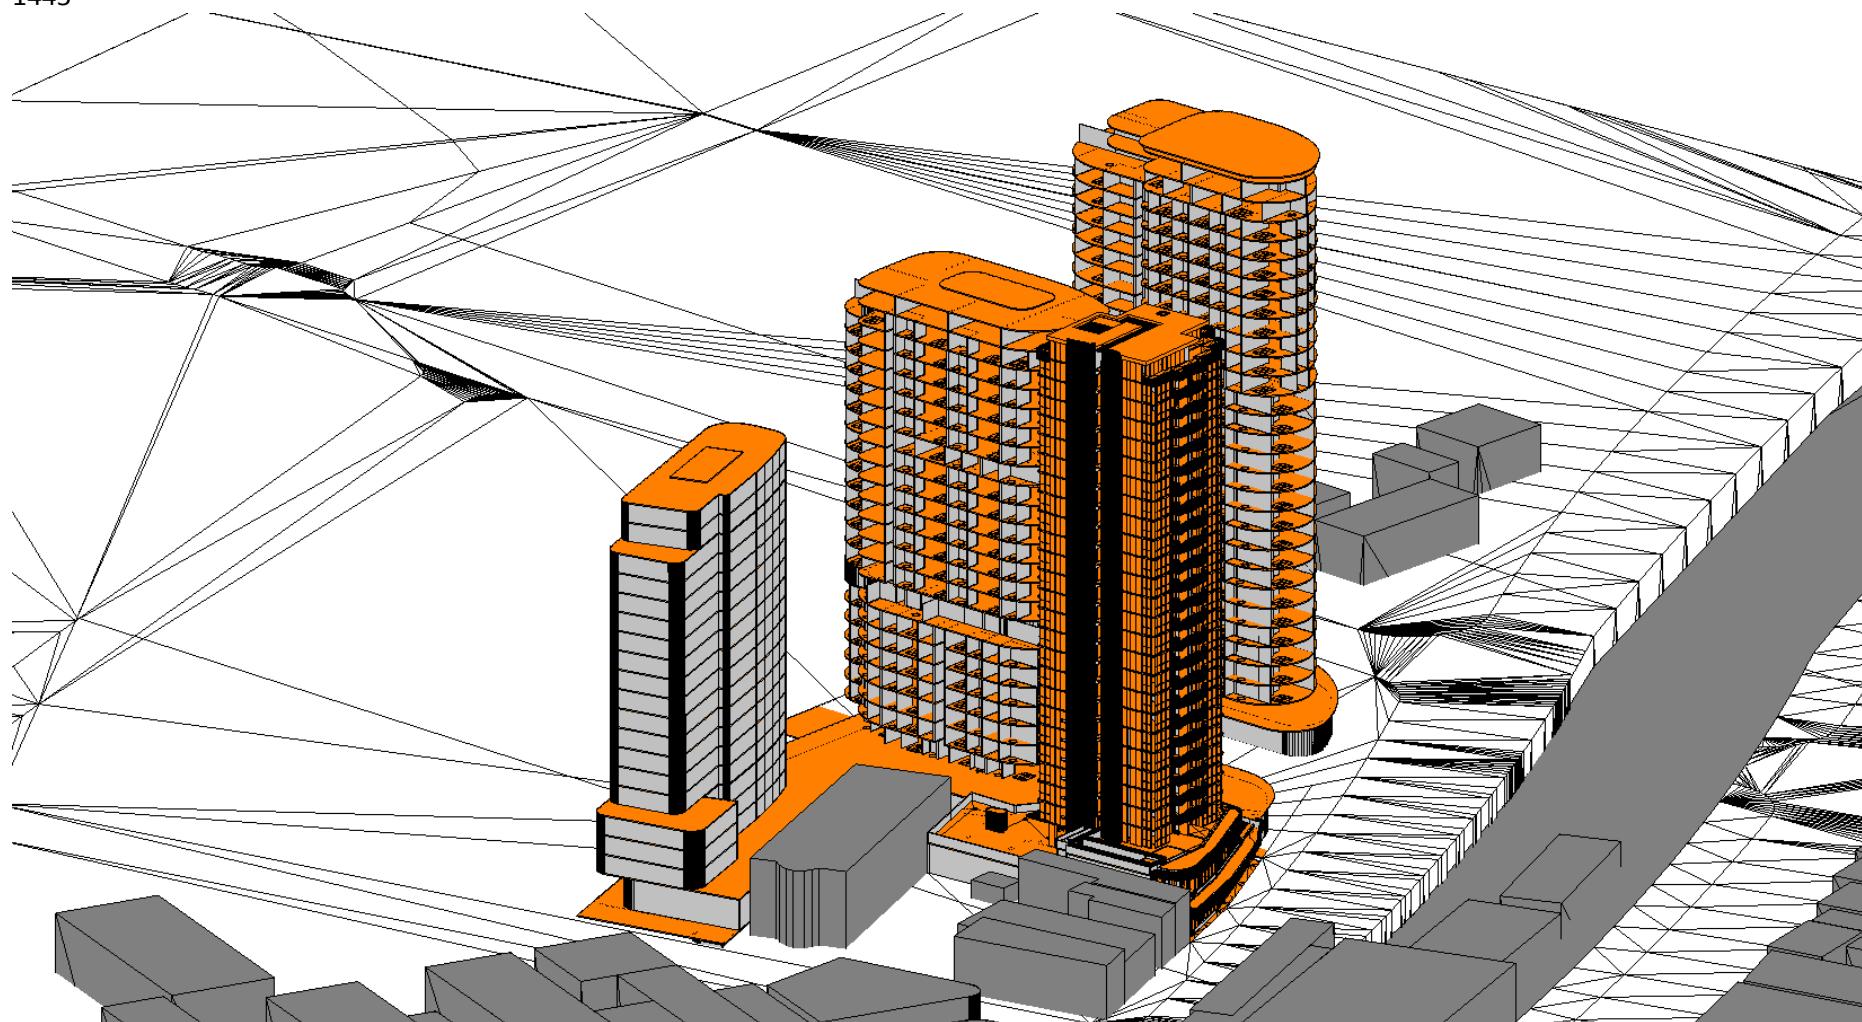
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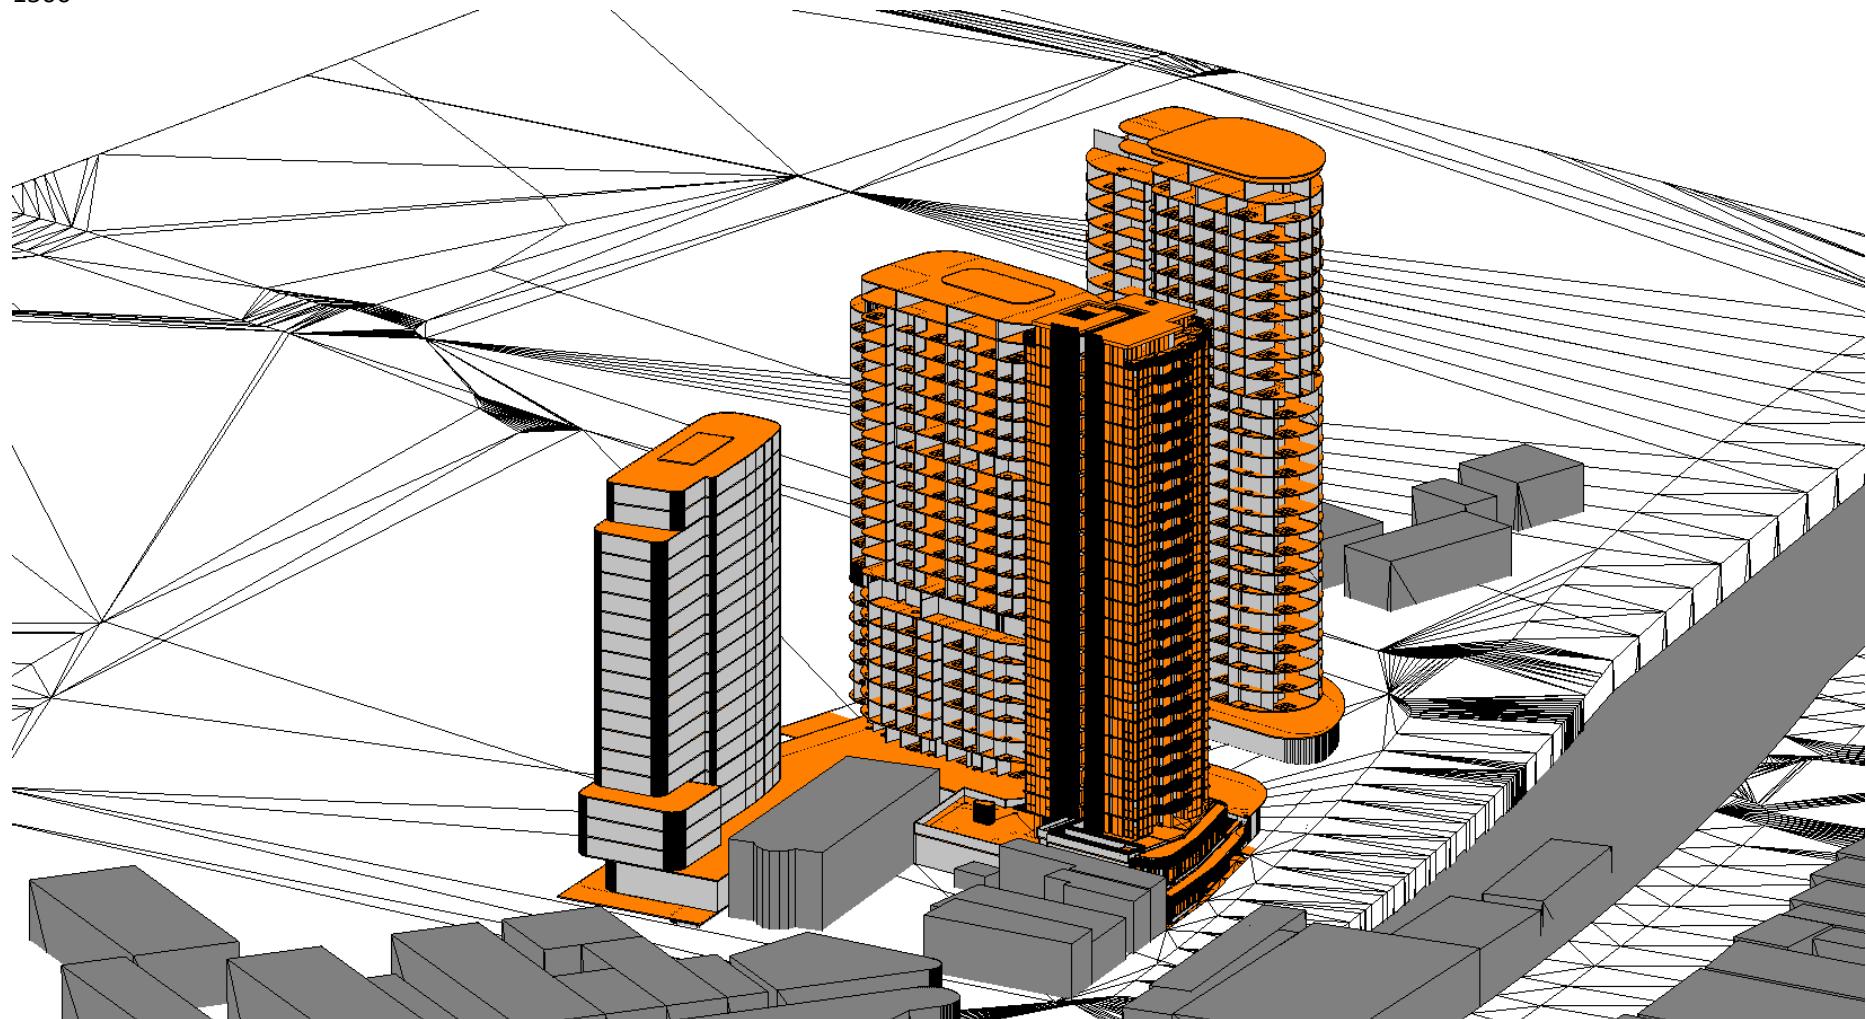
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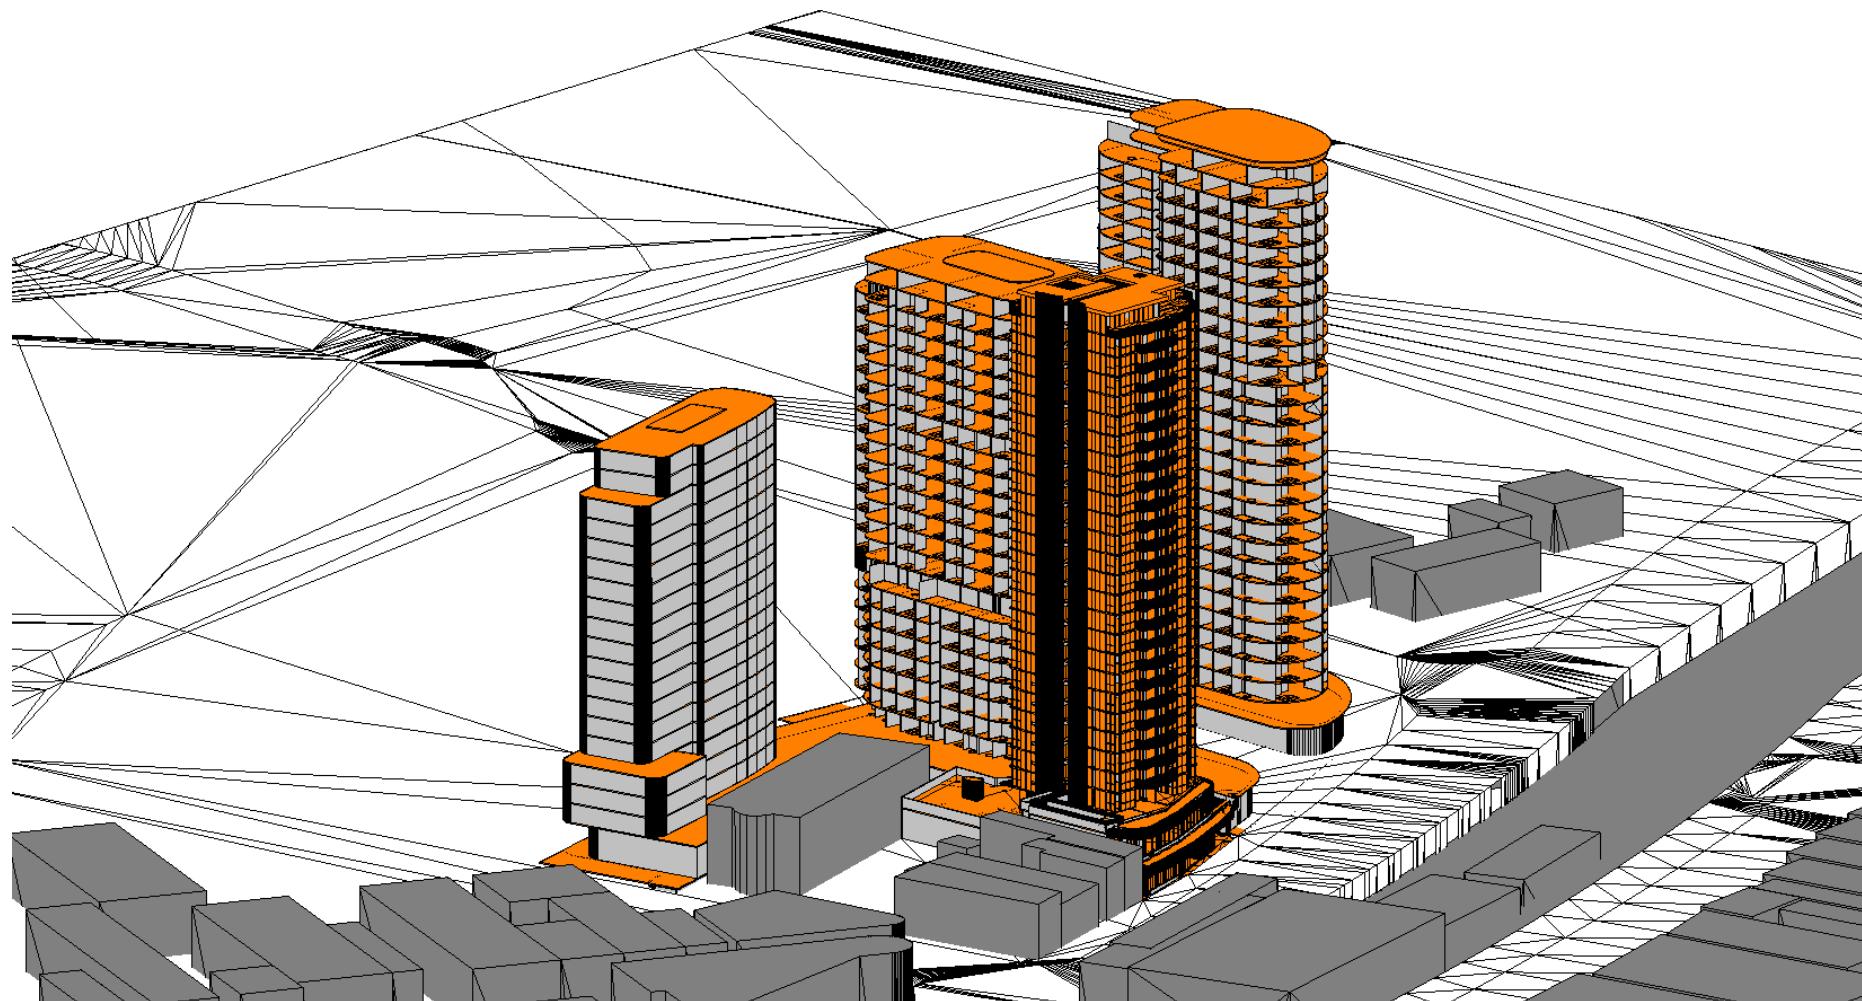


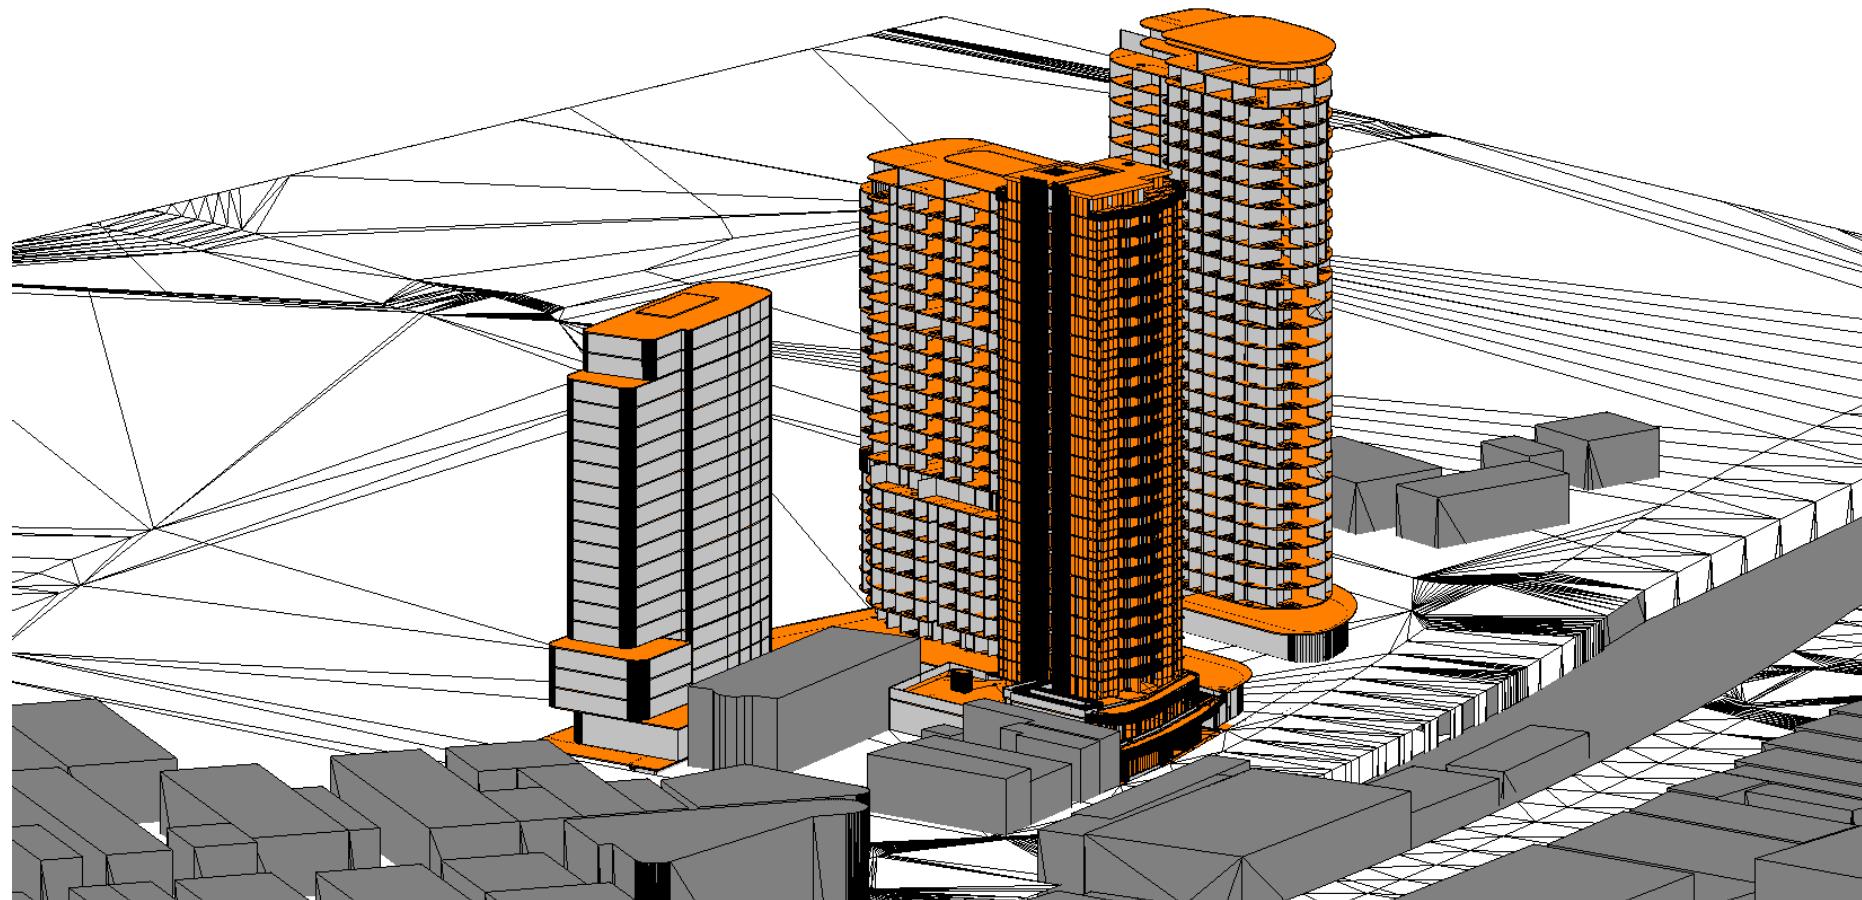
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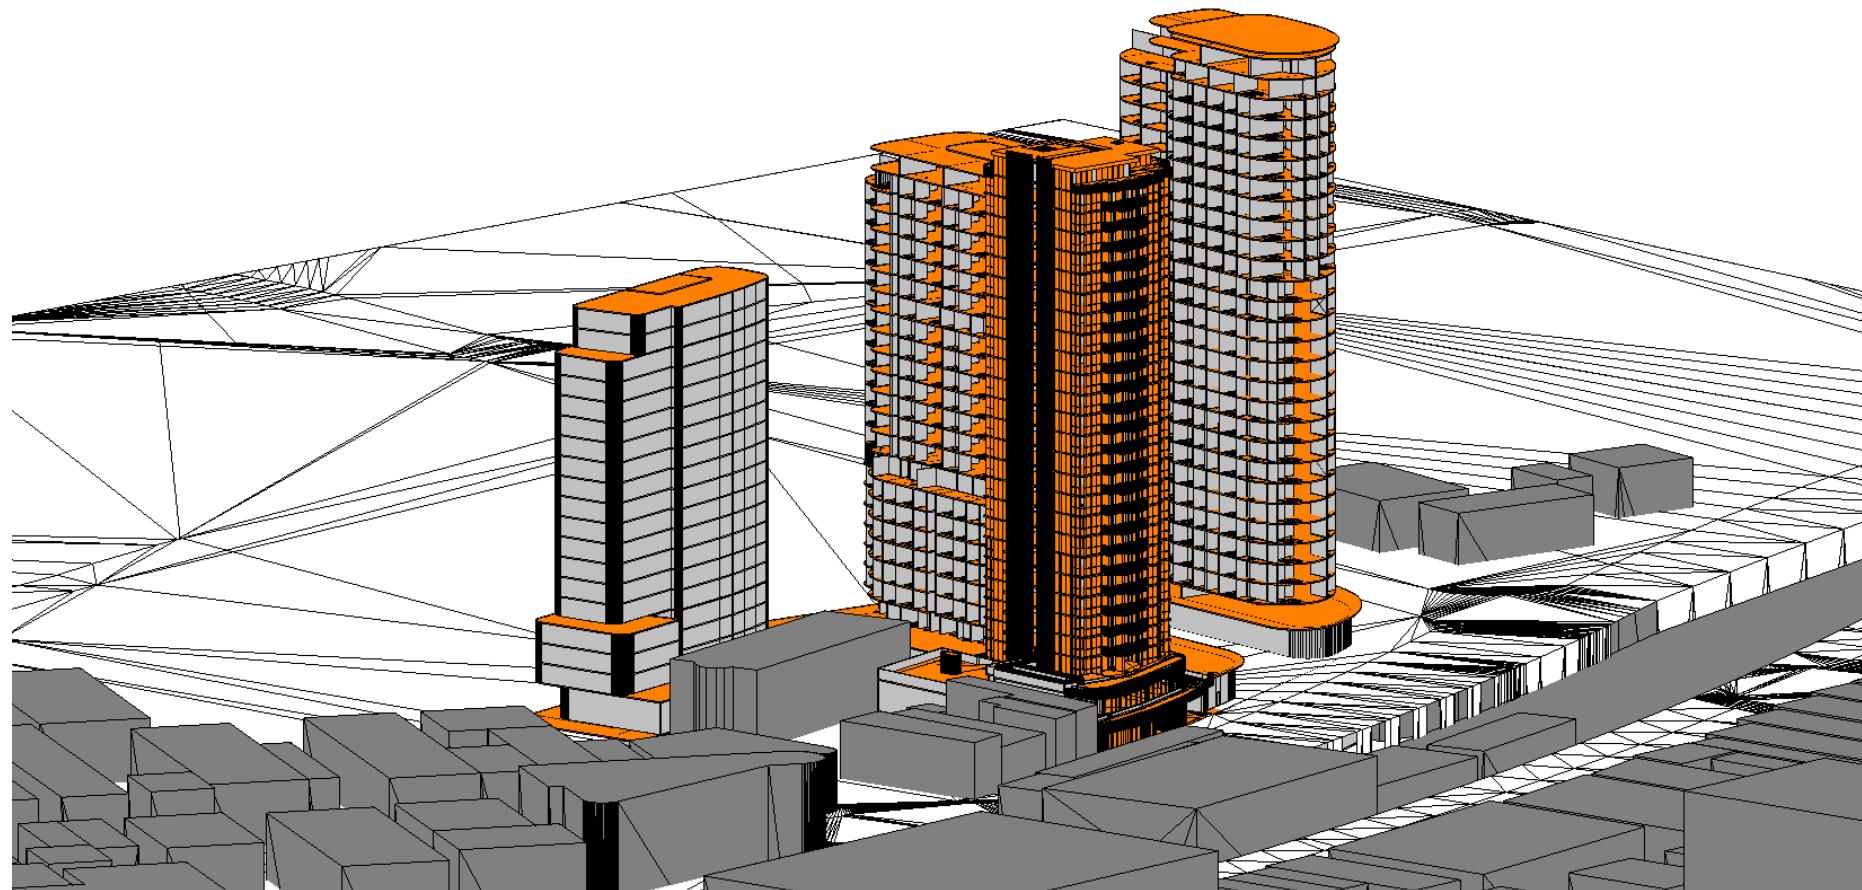


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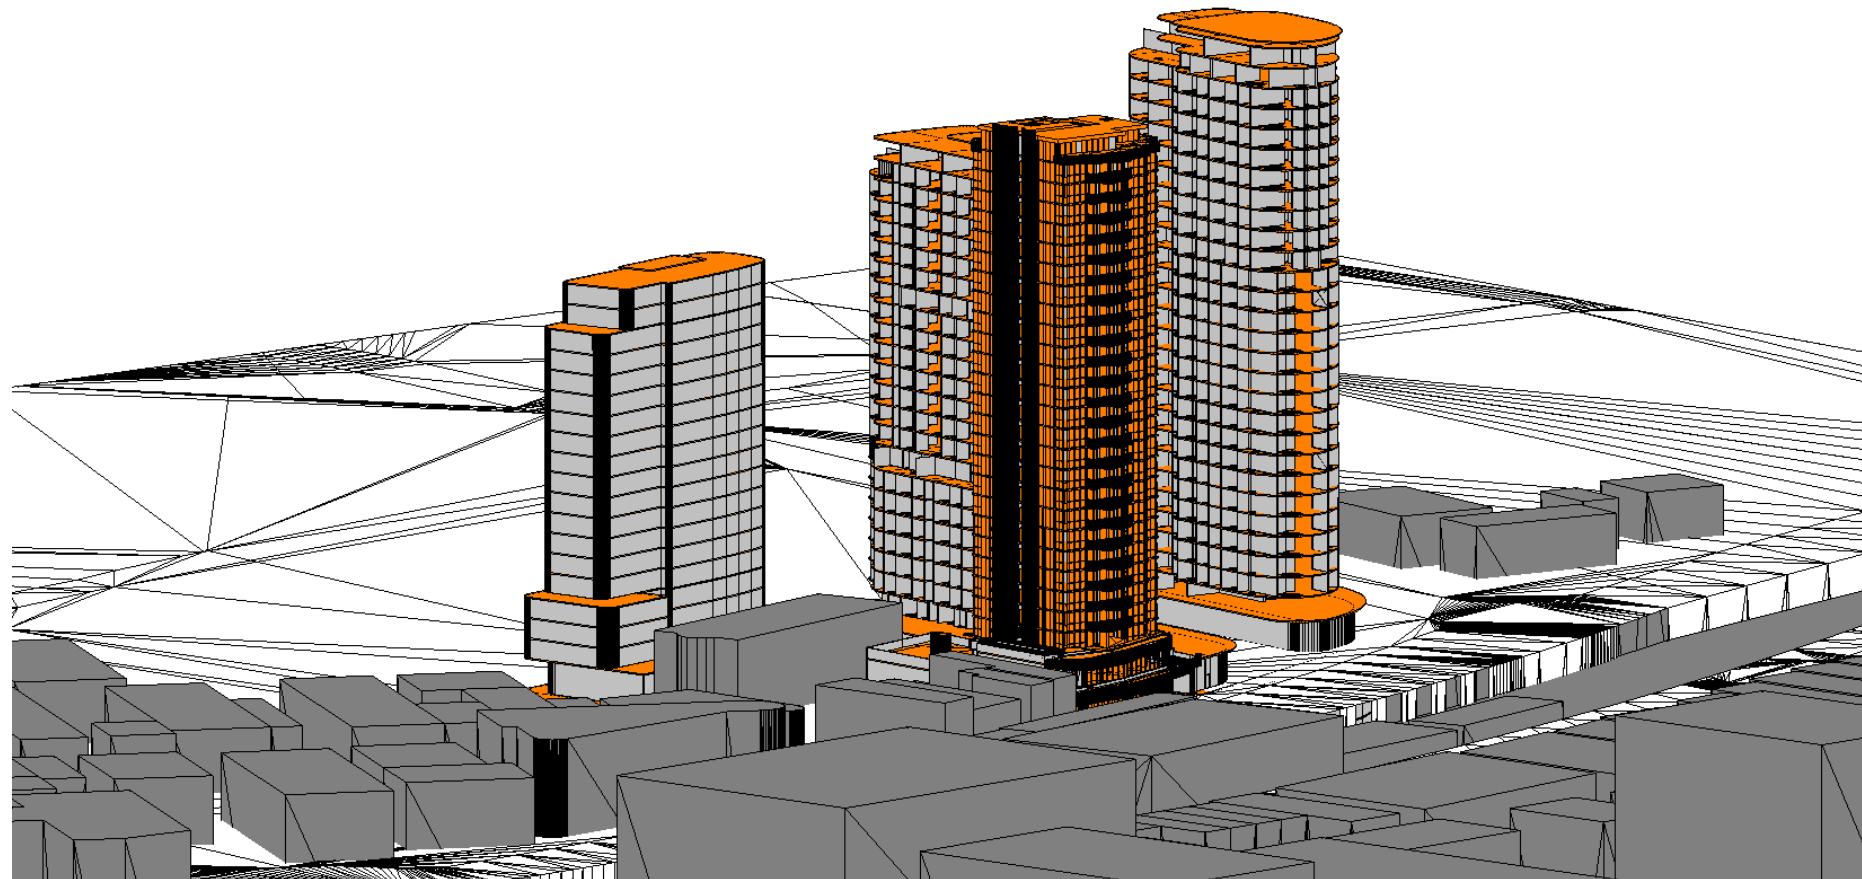








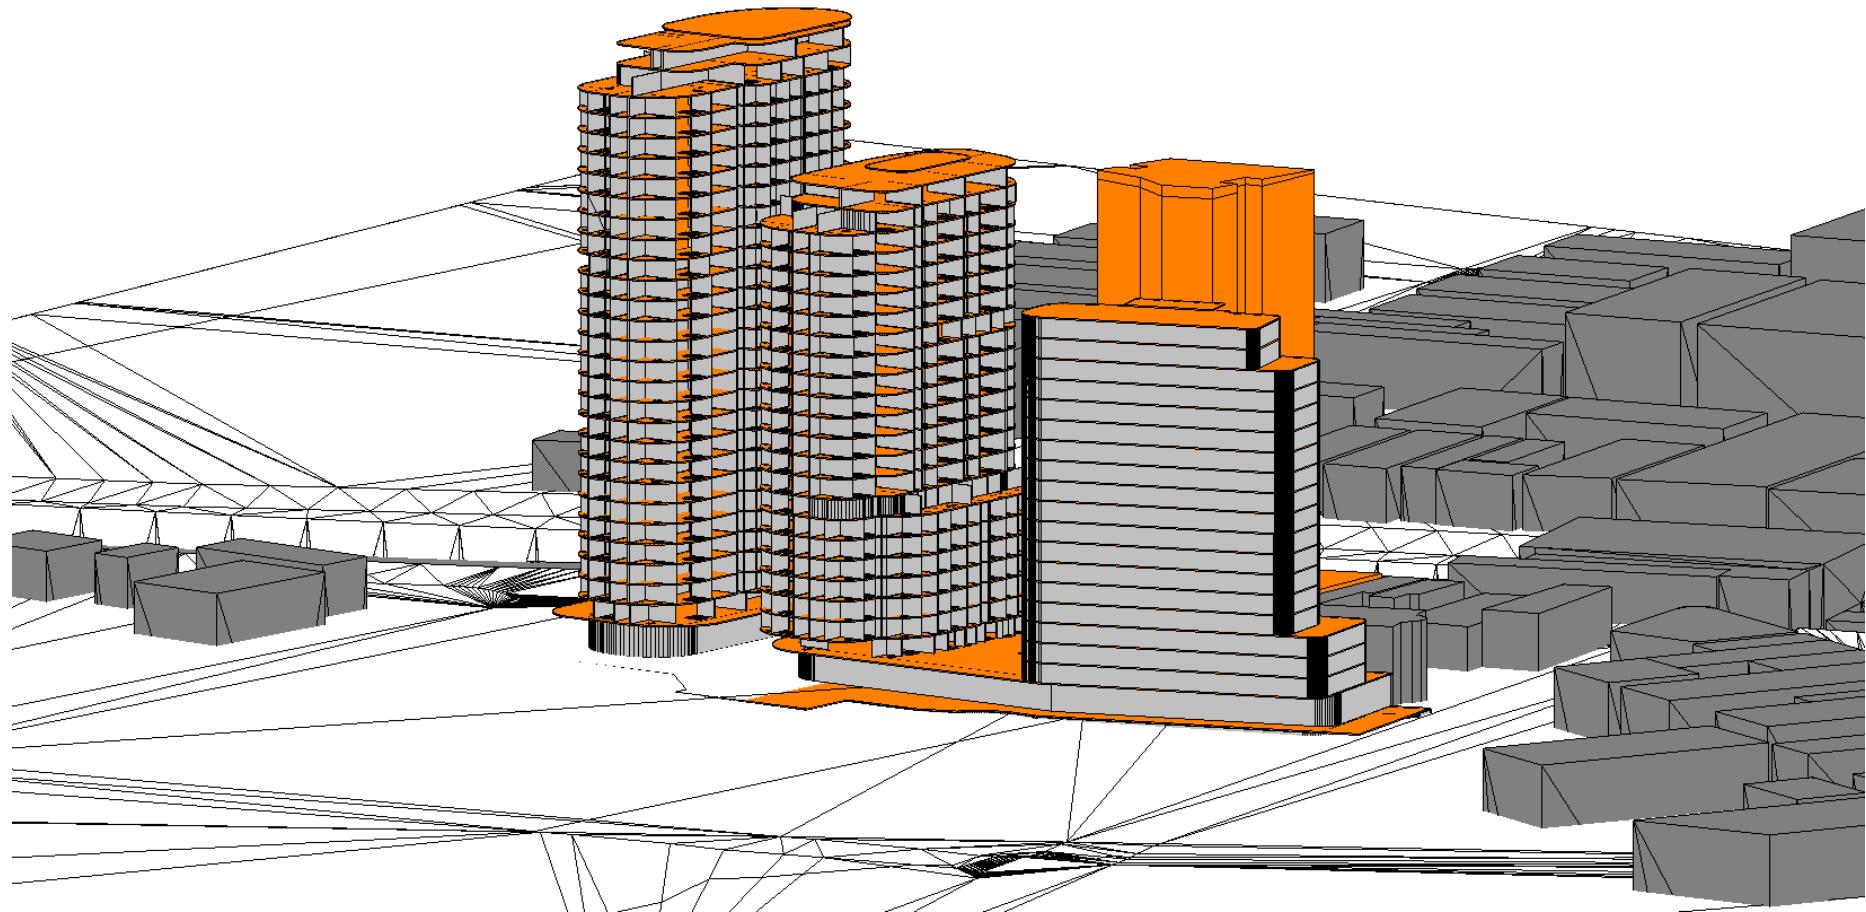
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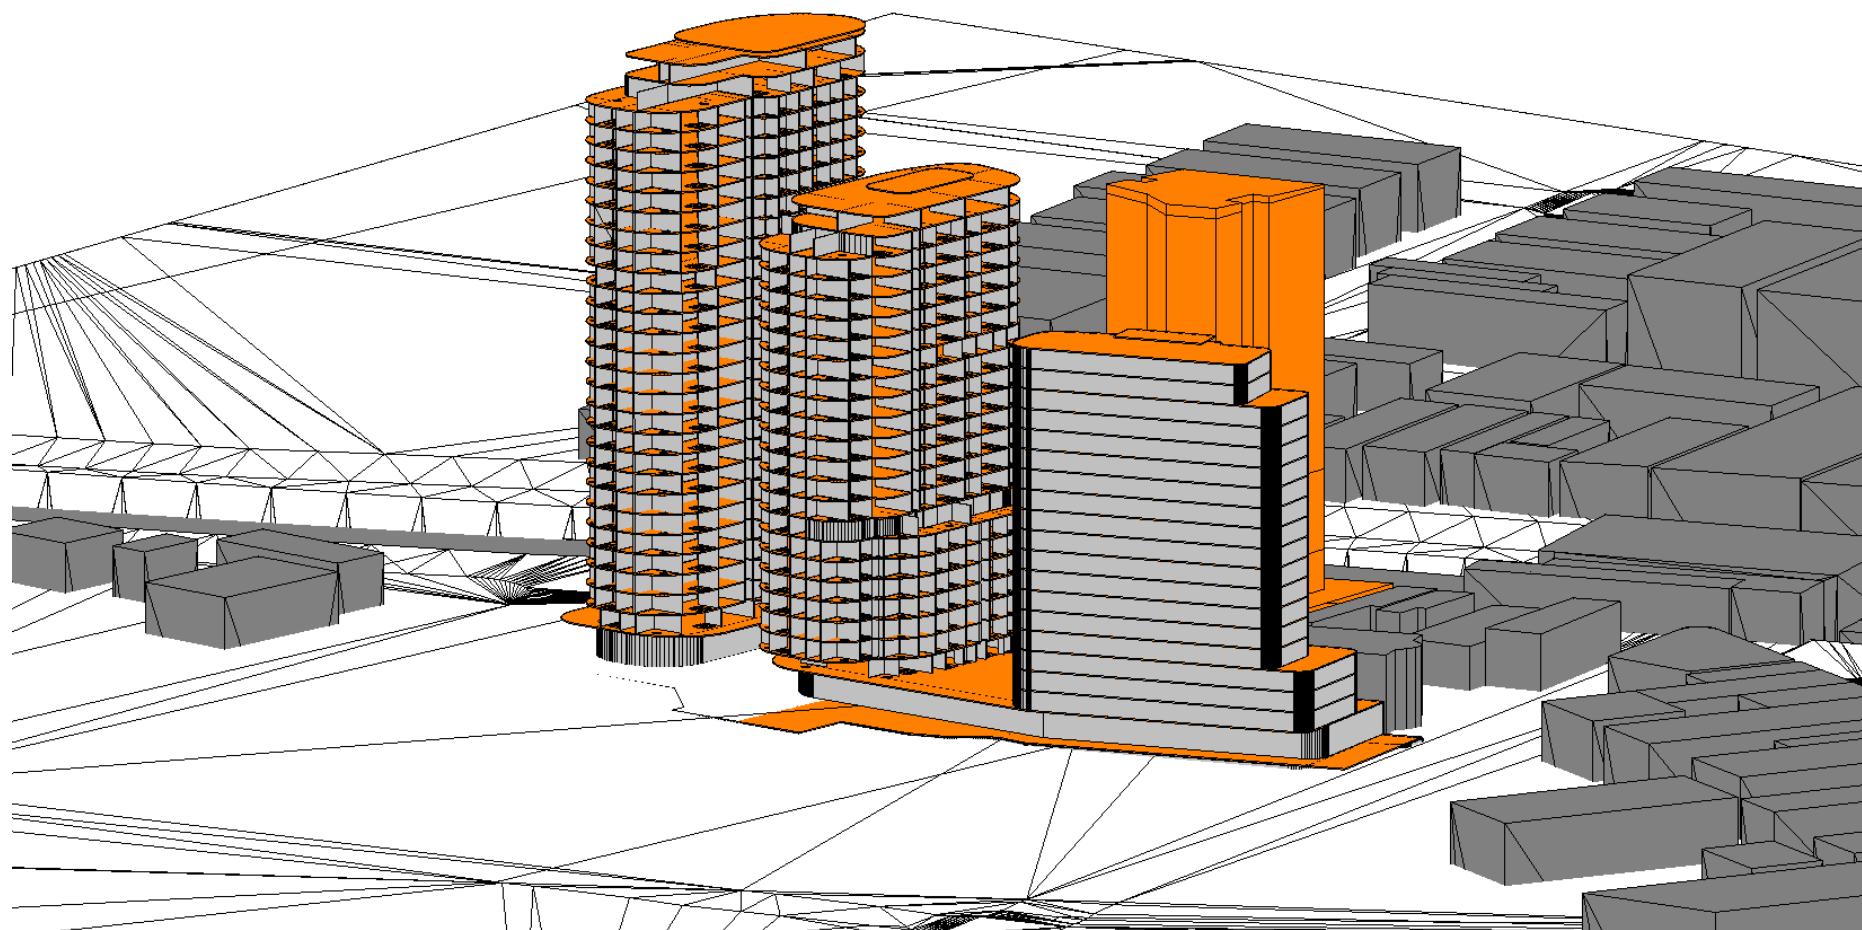
# **APPENDIX D**

Sun Eye Views ADG Massing

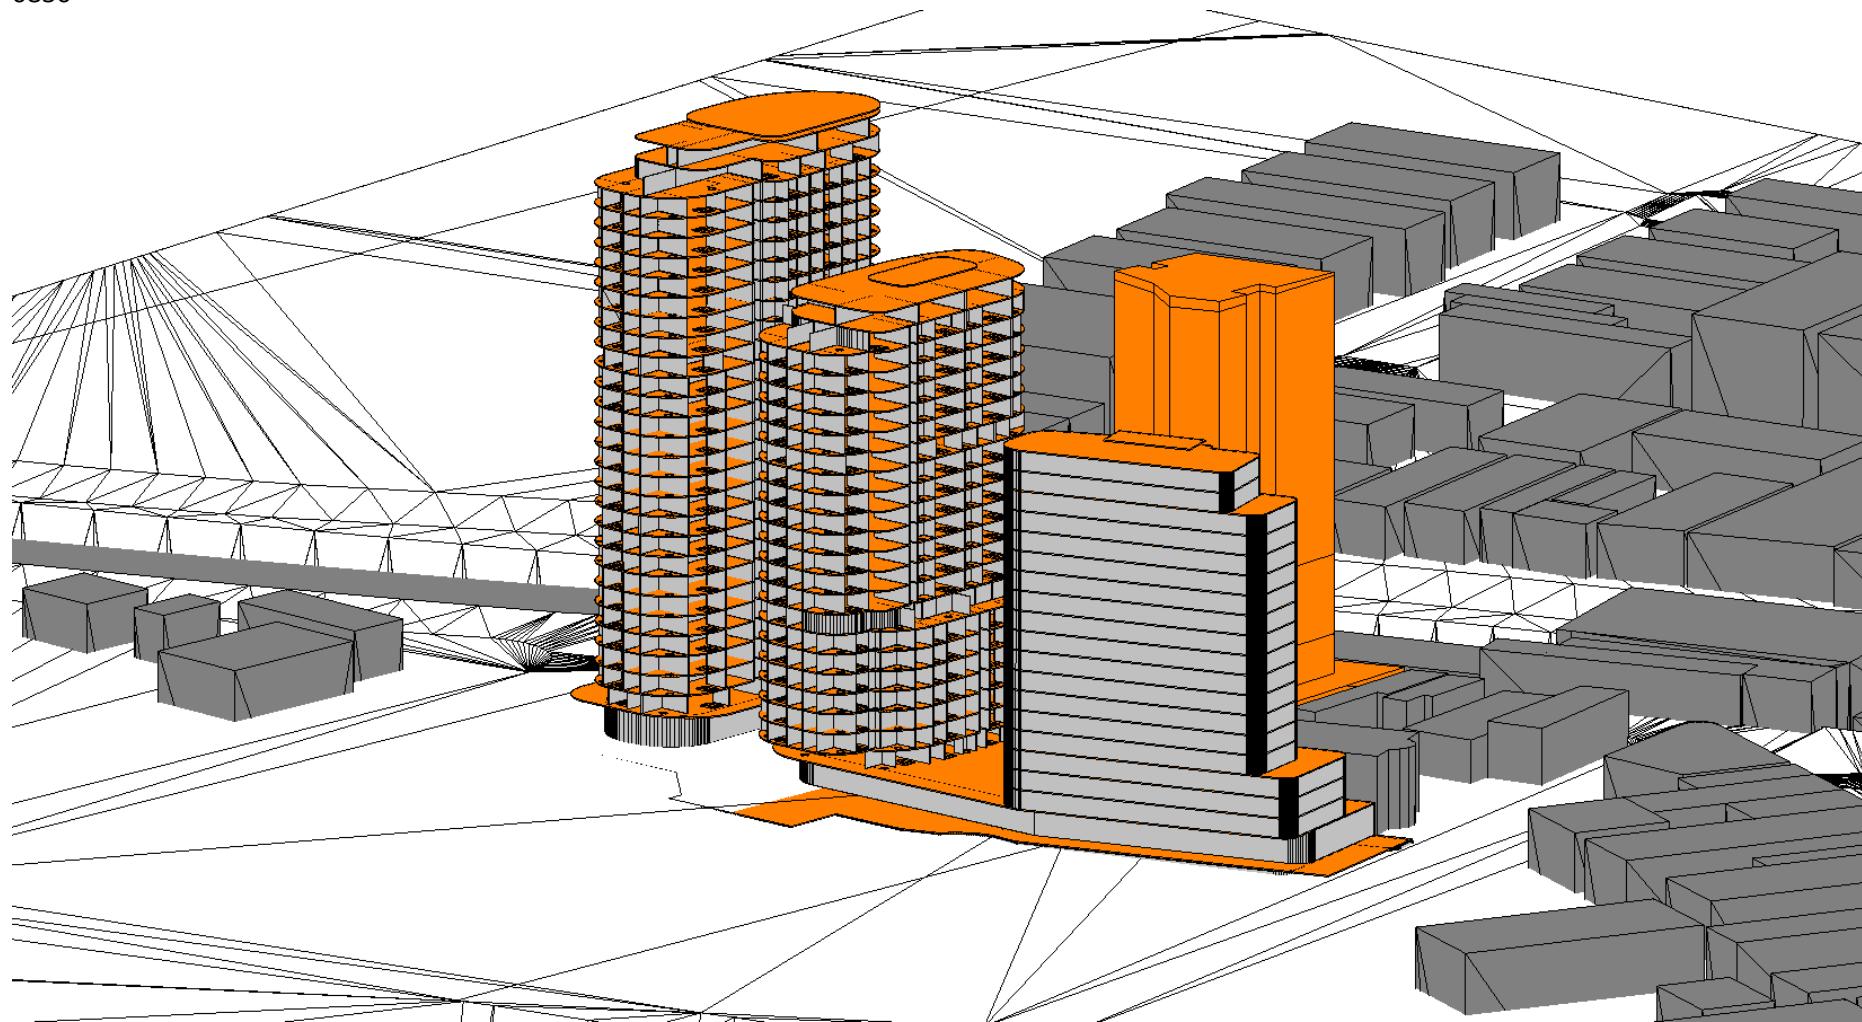
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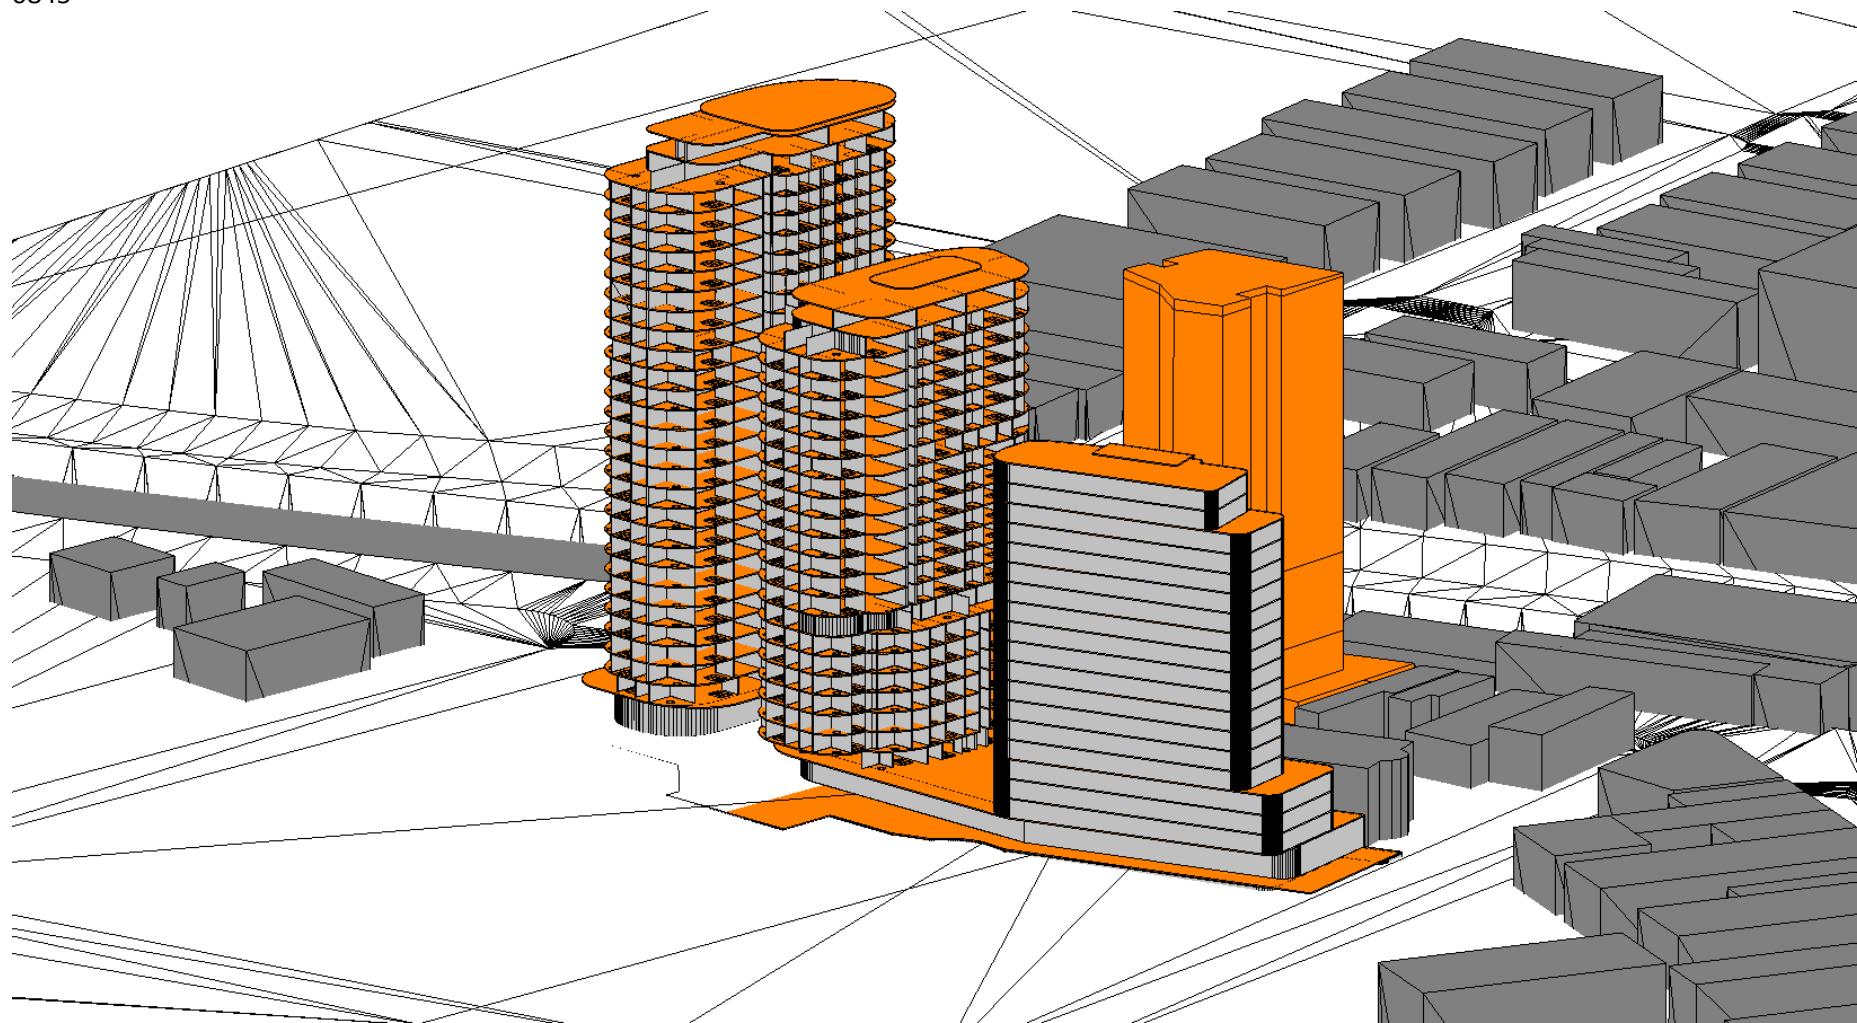
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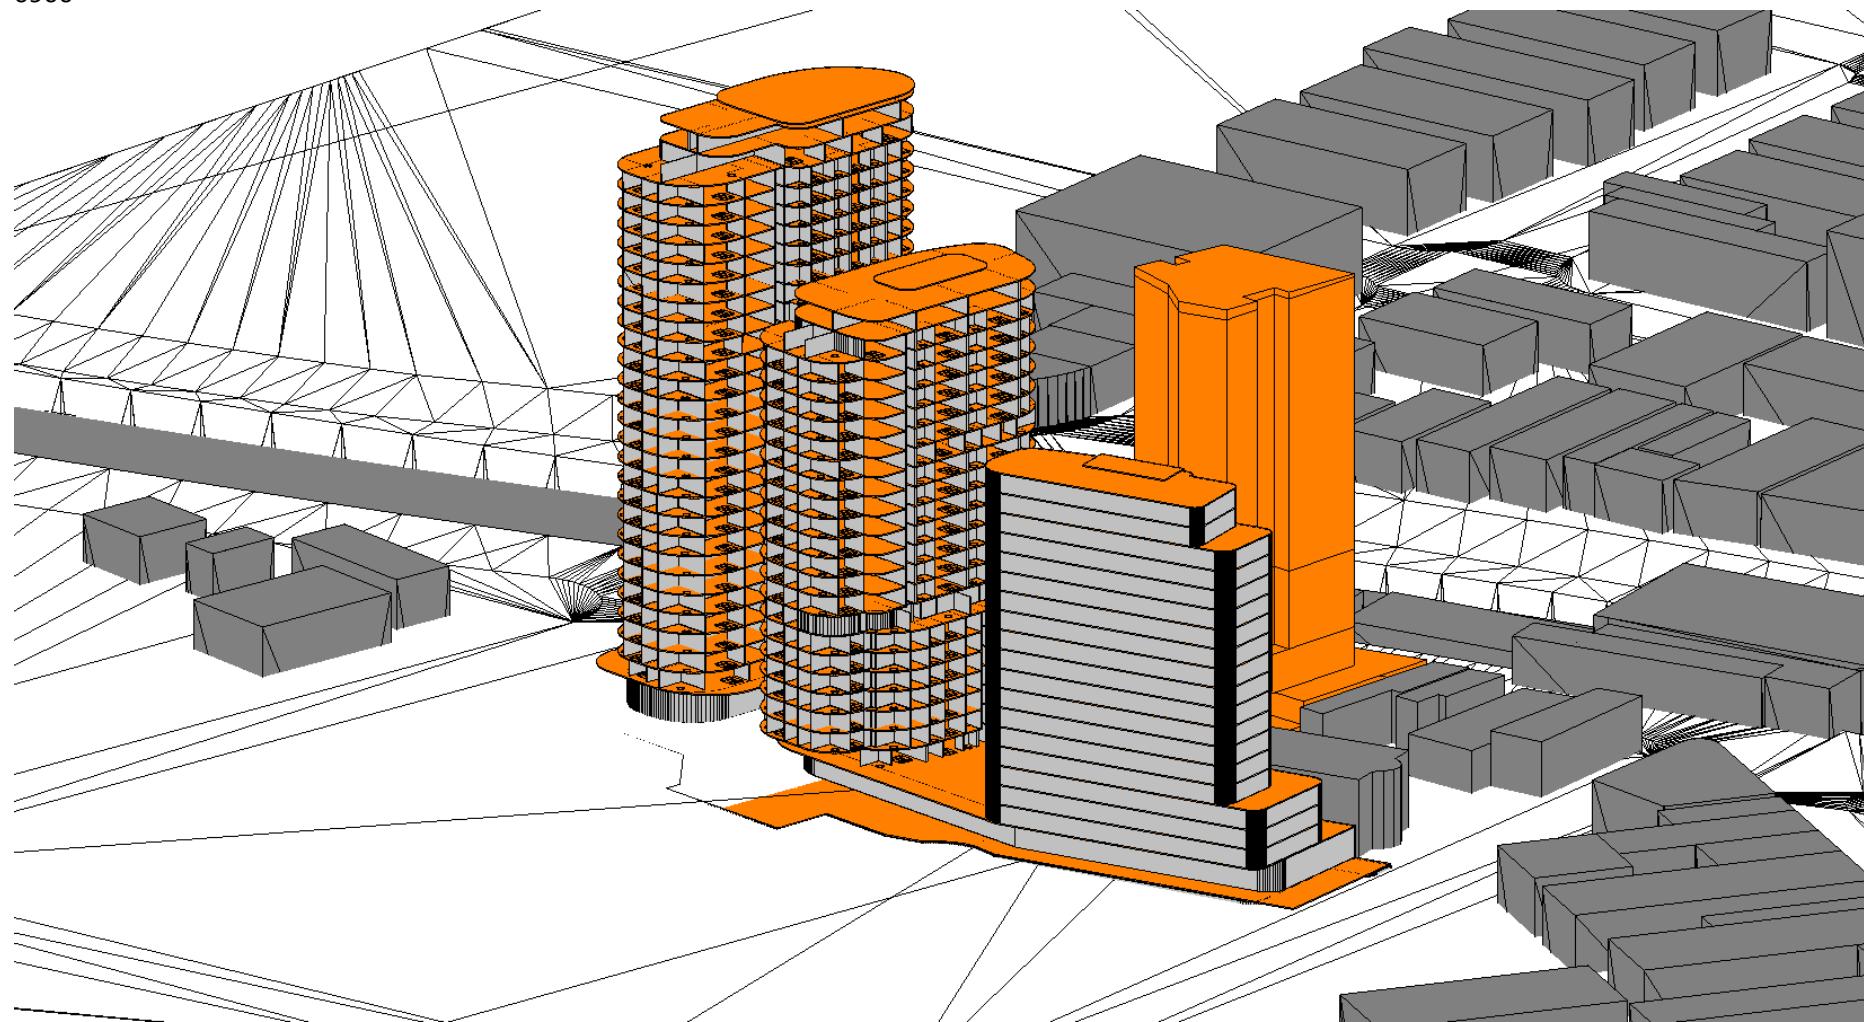
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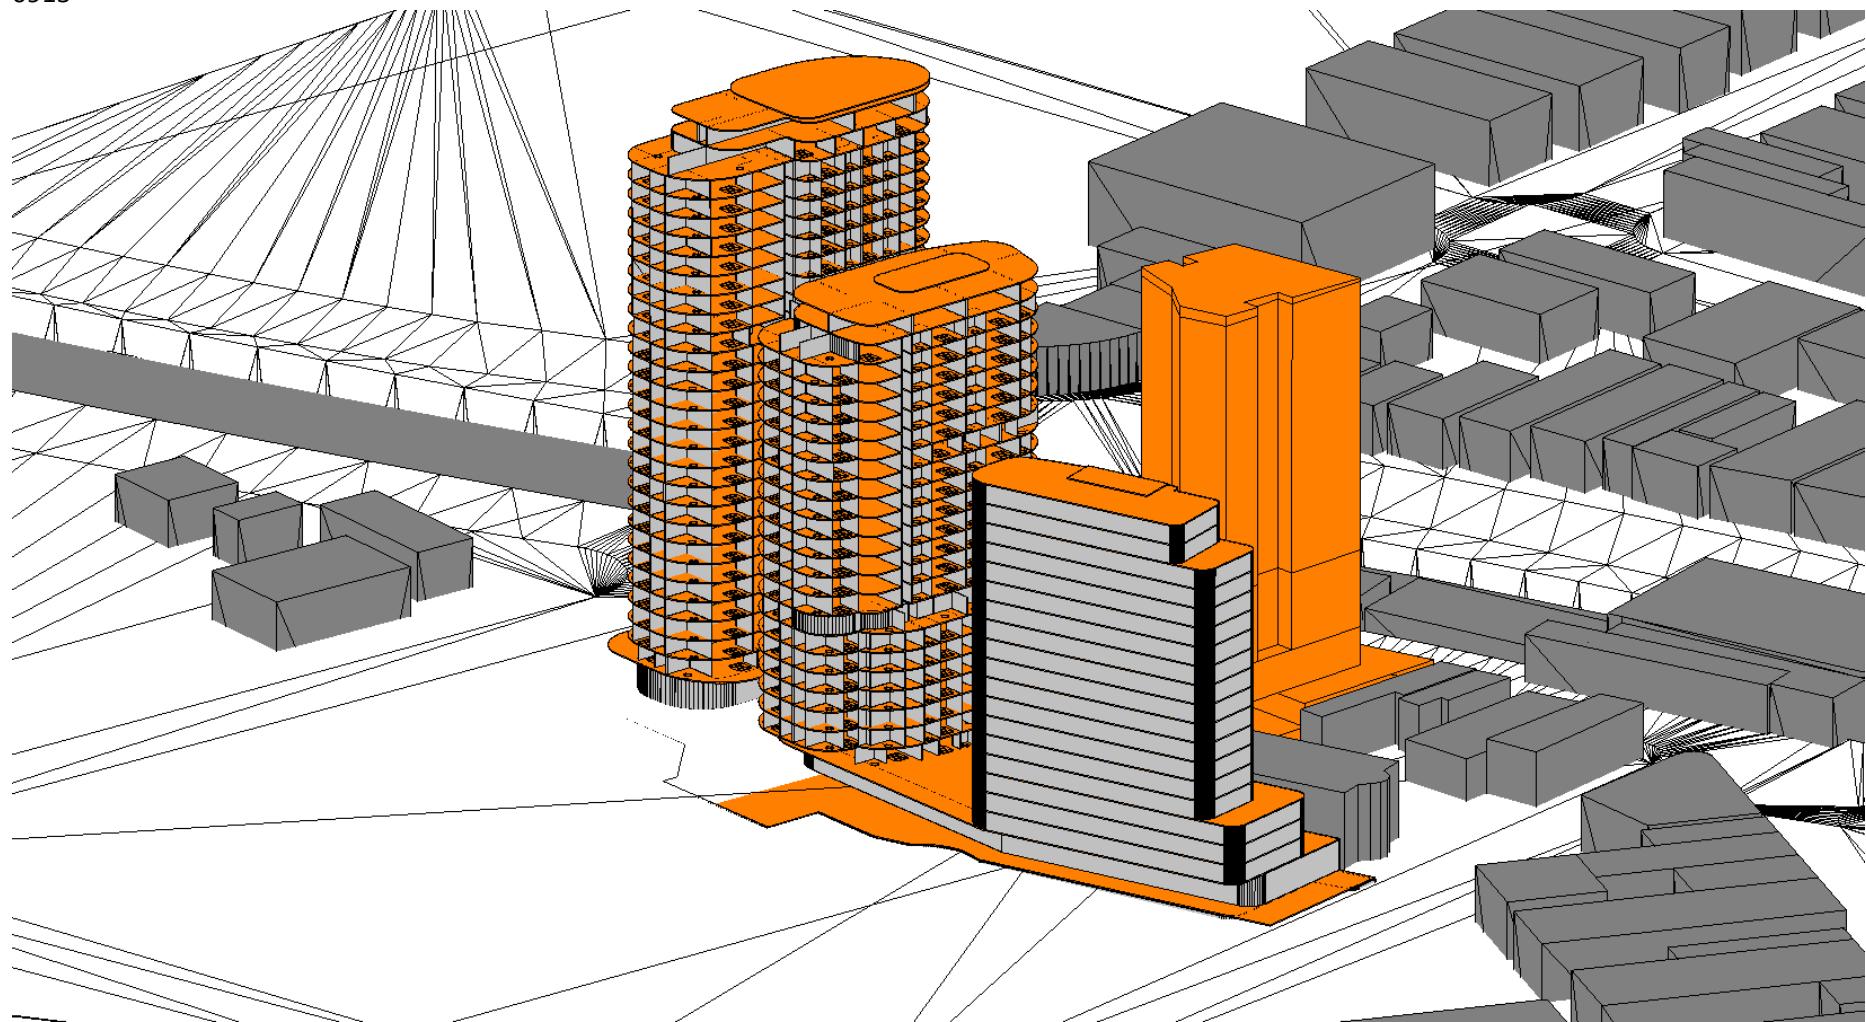
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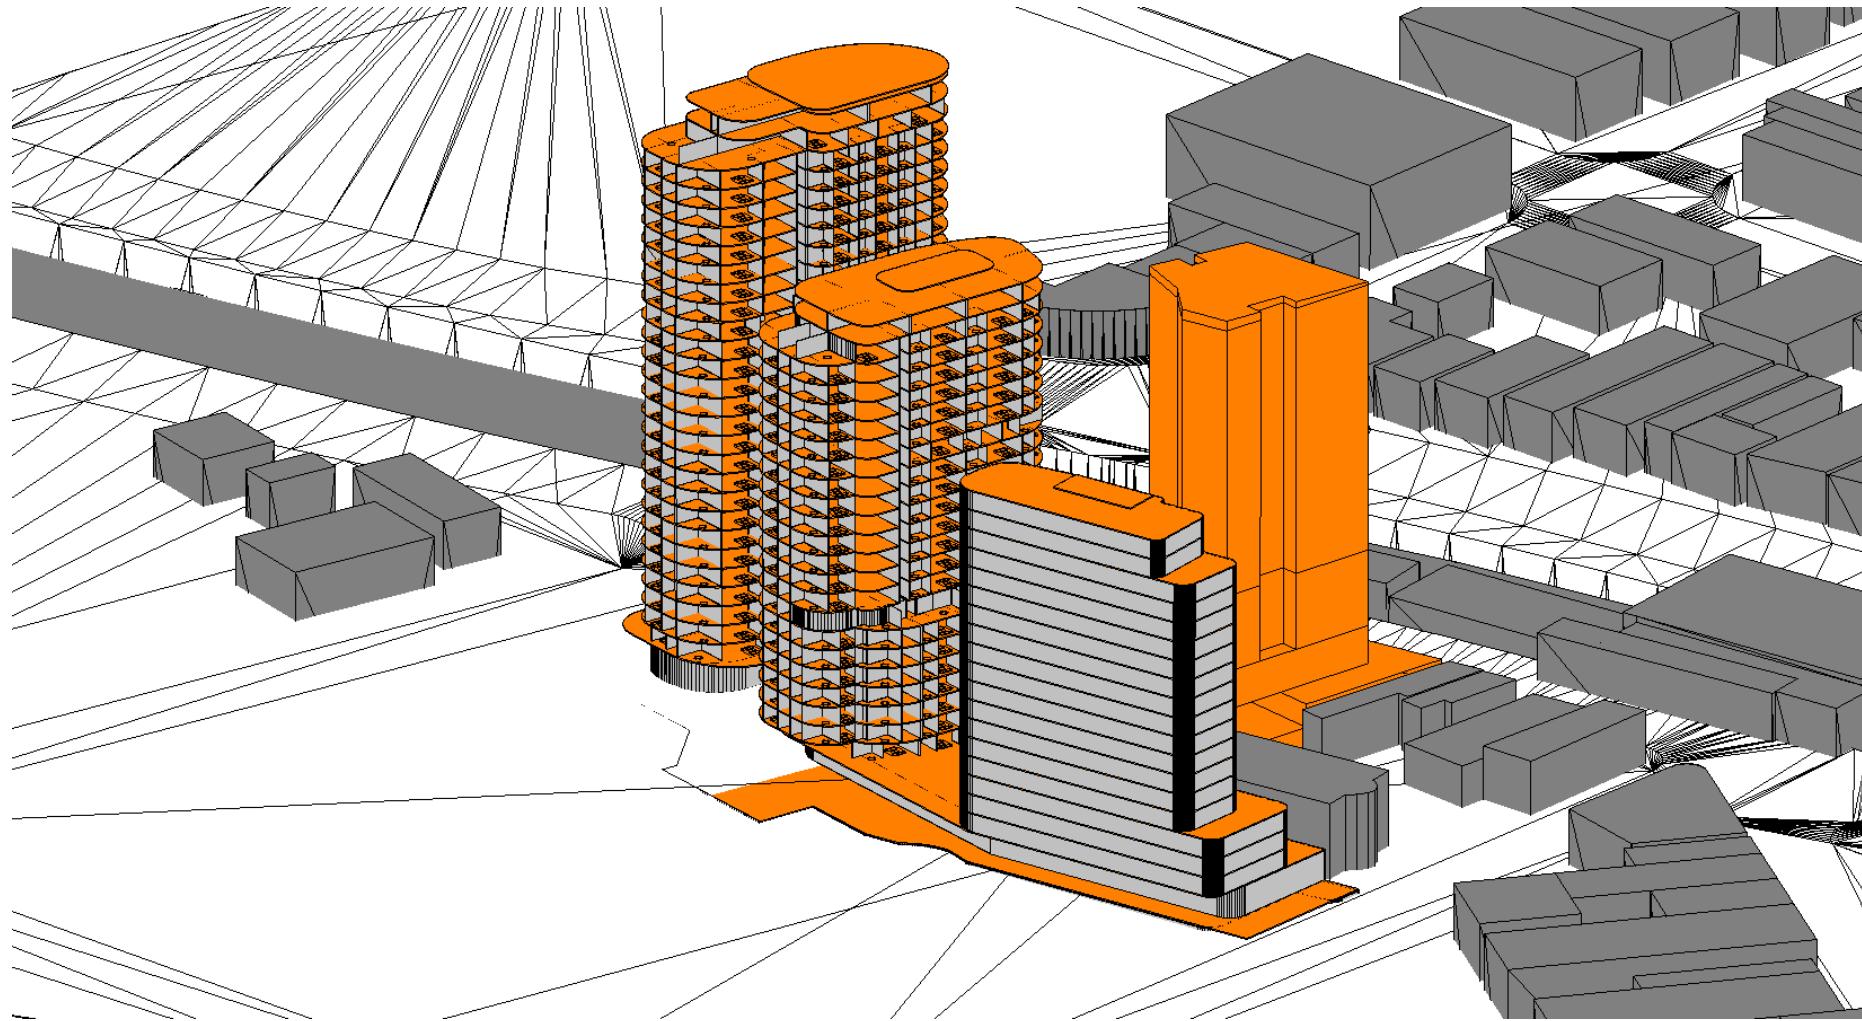
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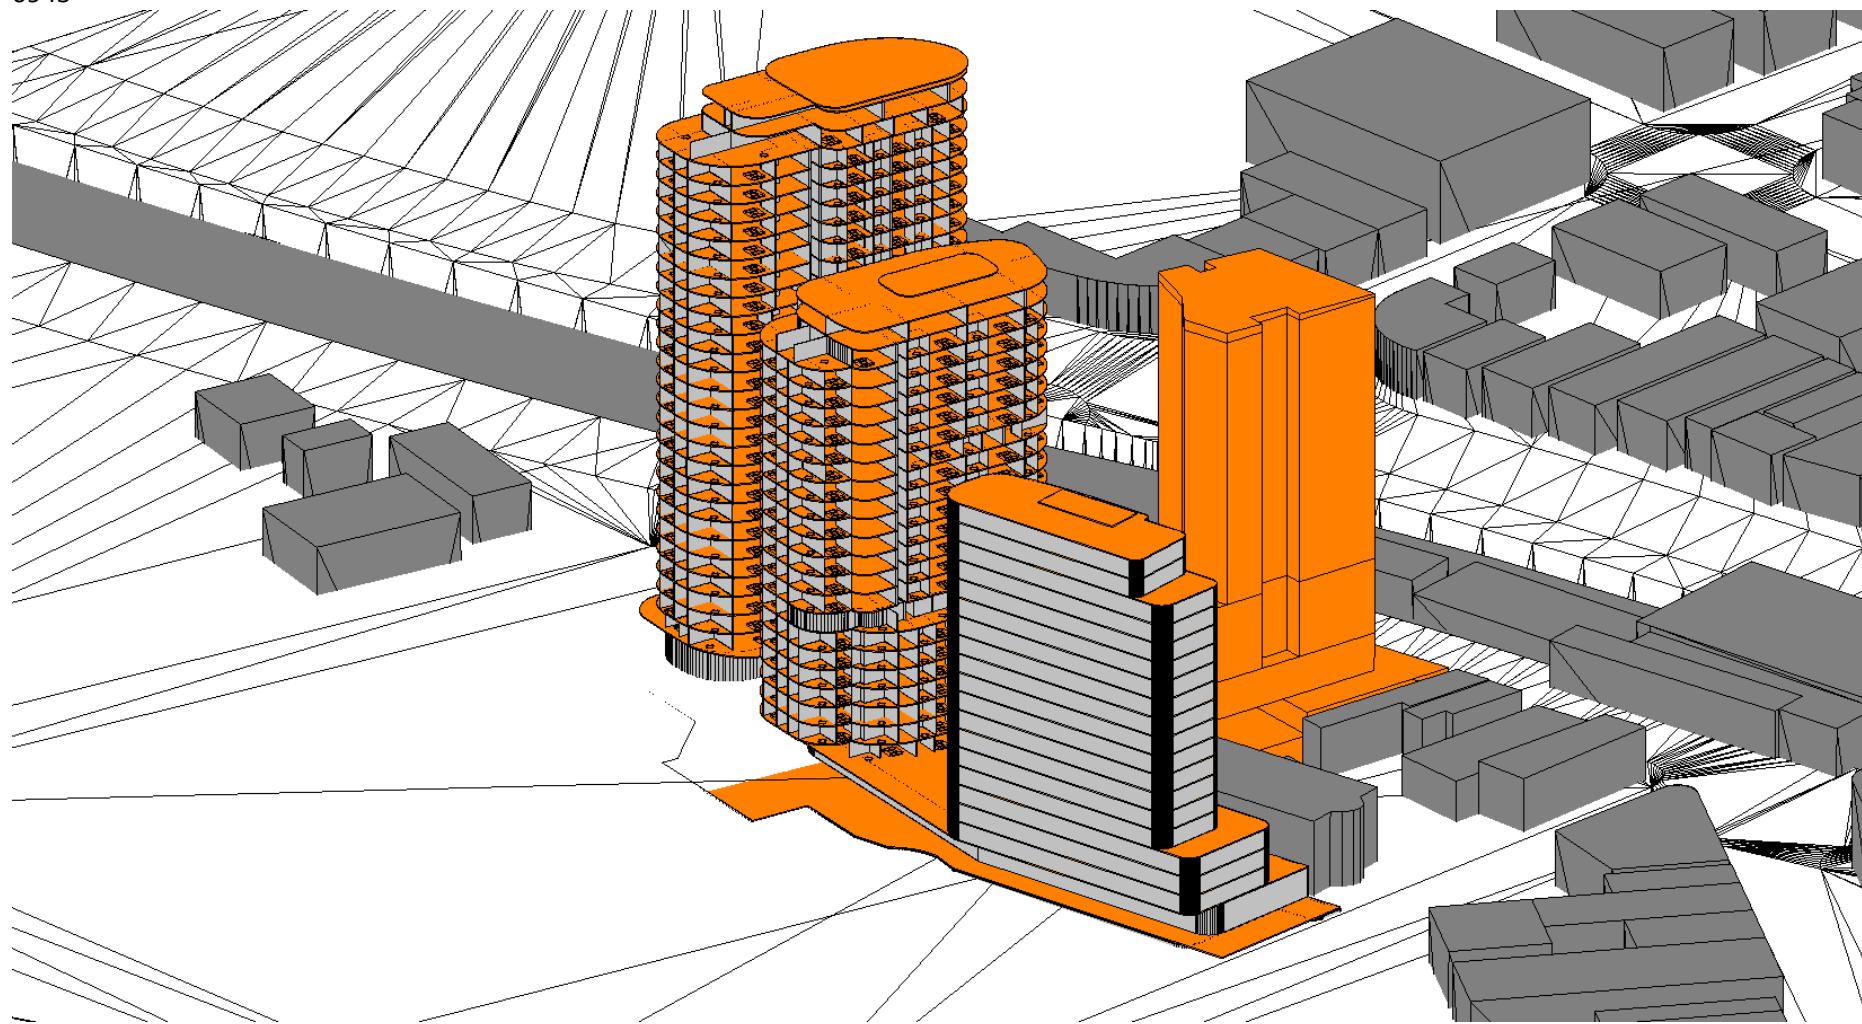
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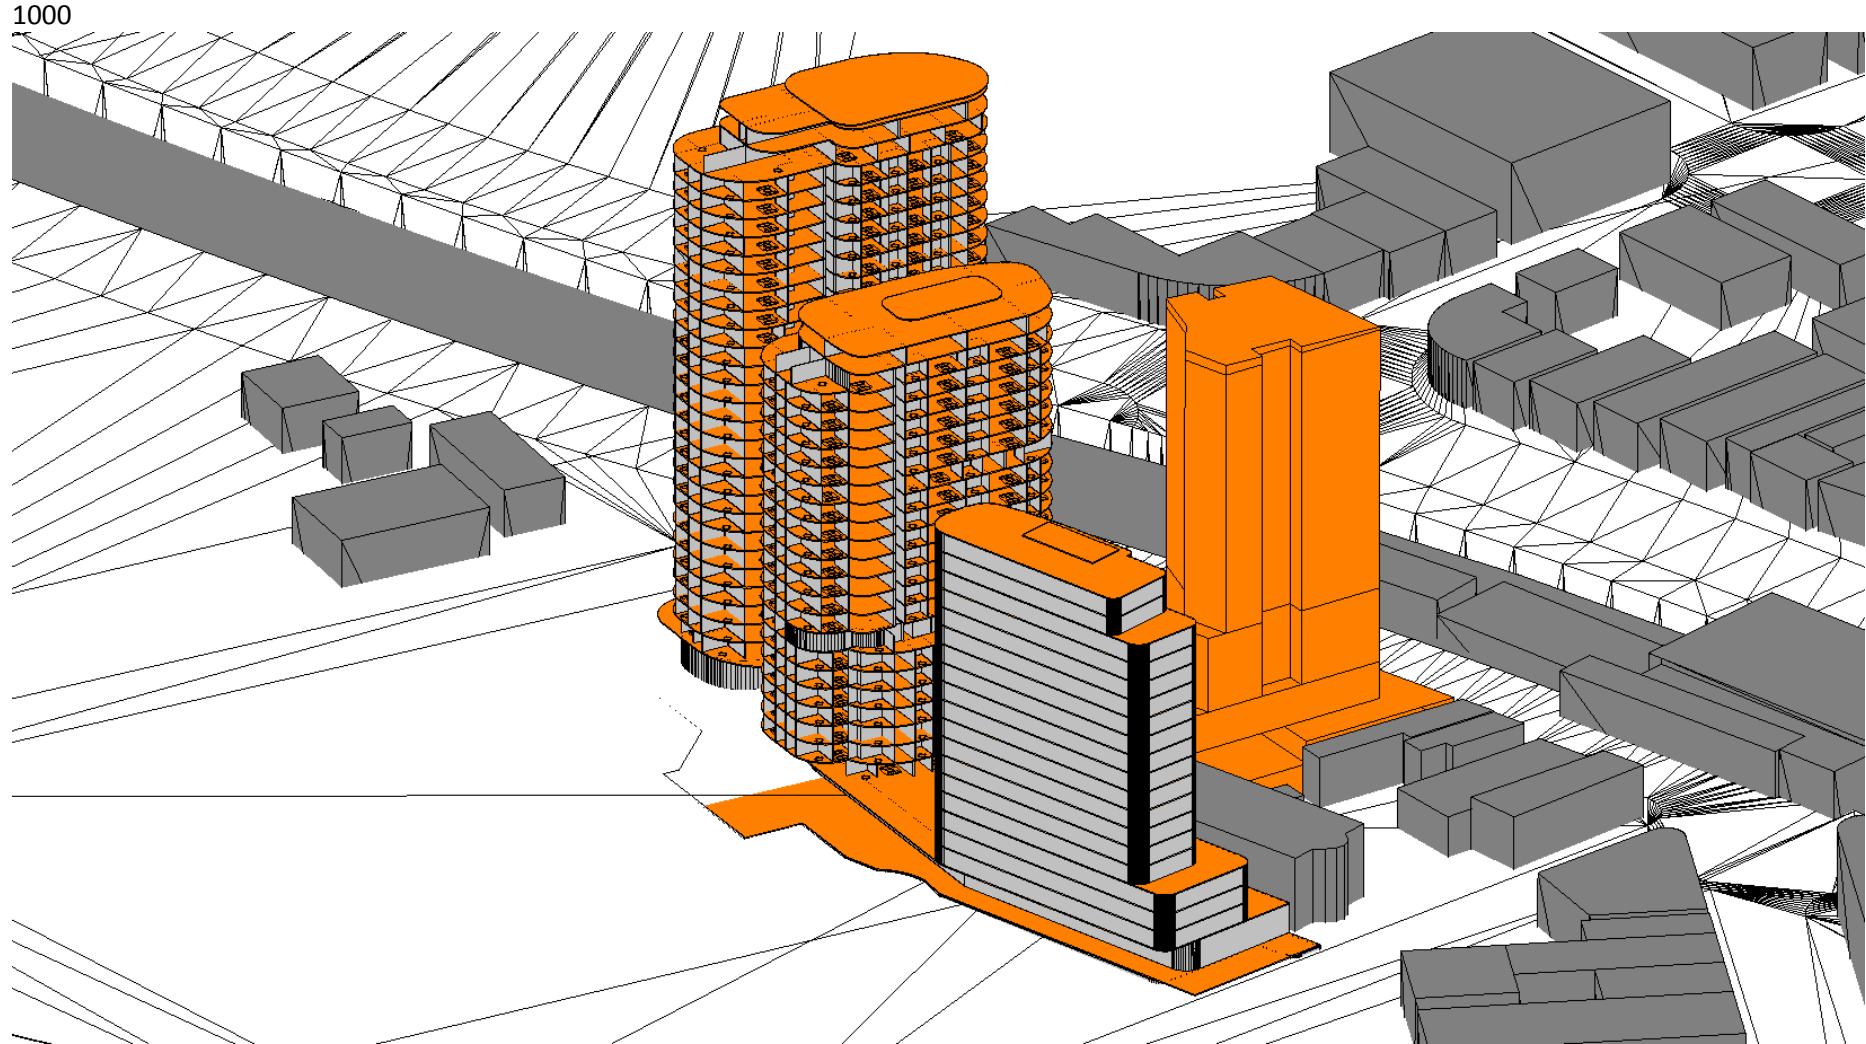


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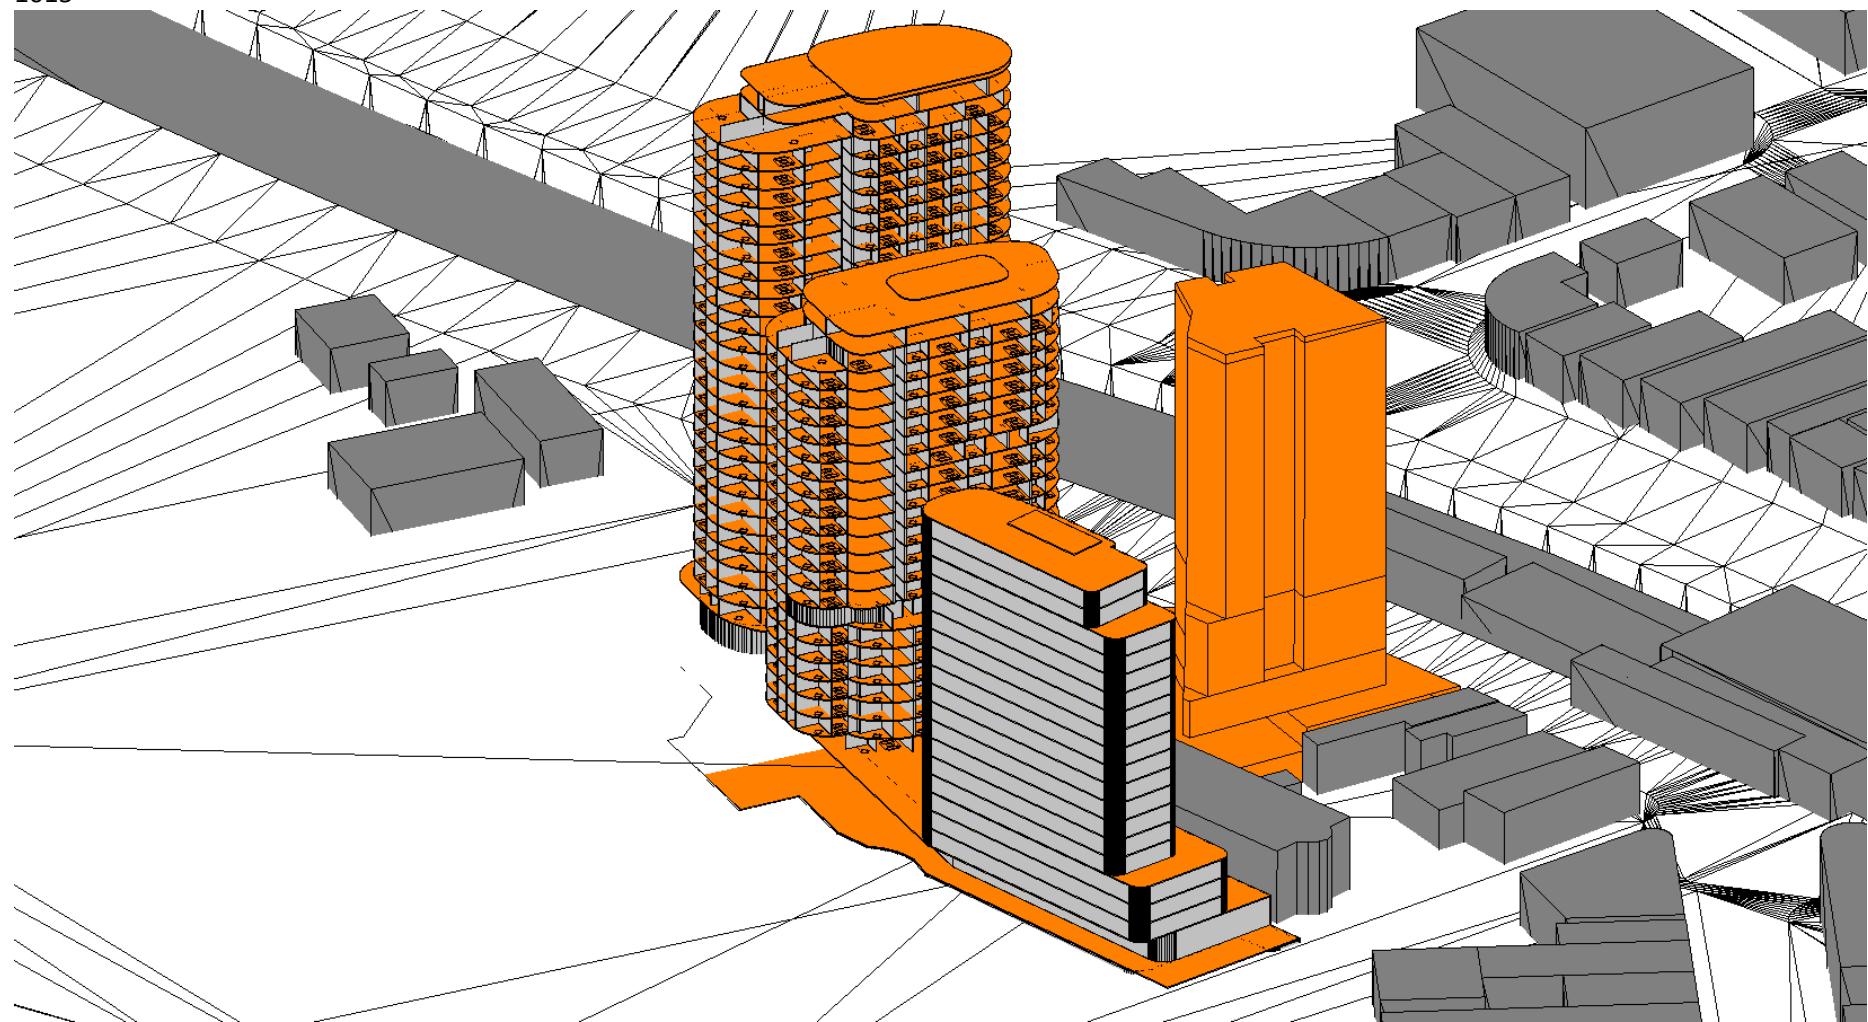


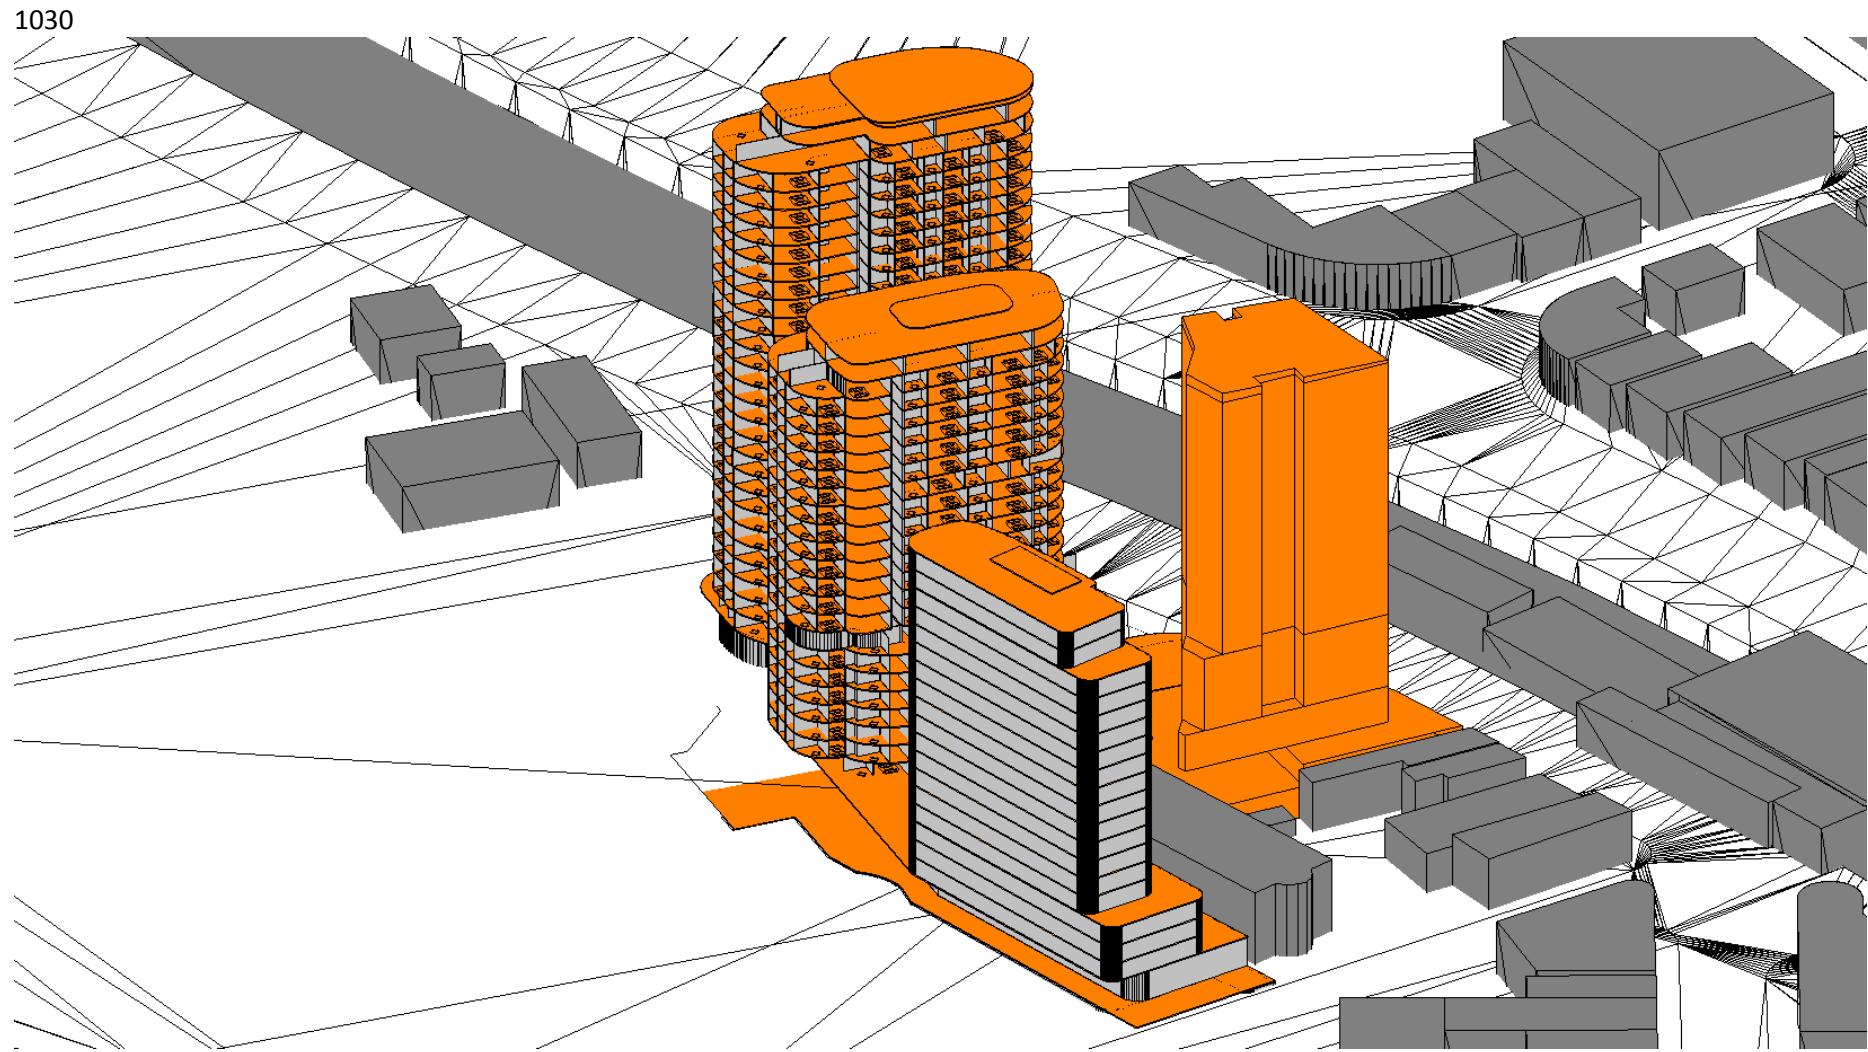
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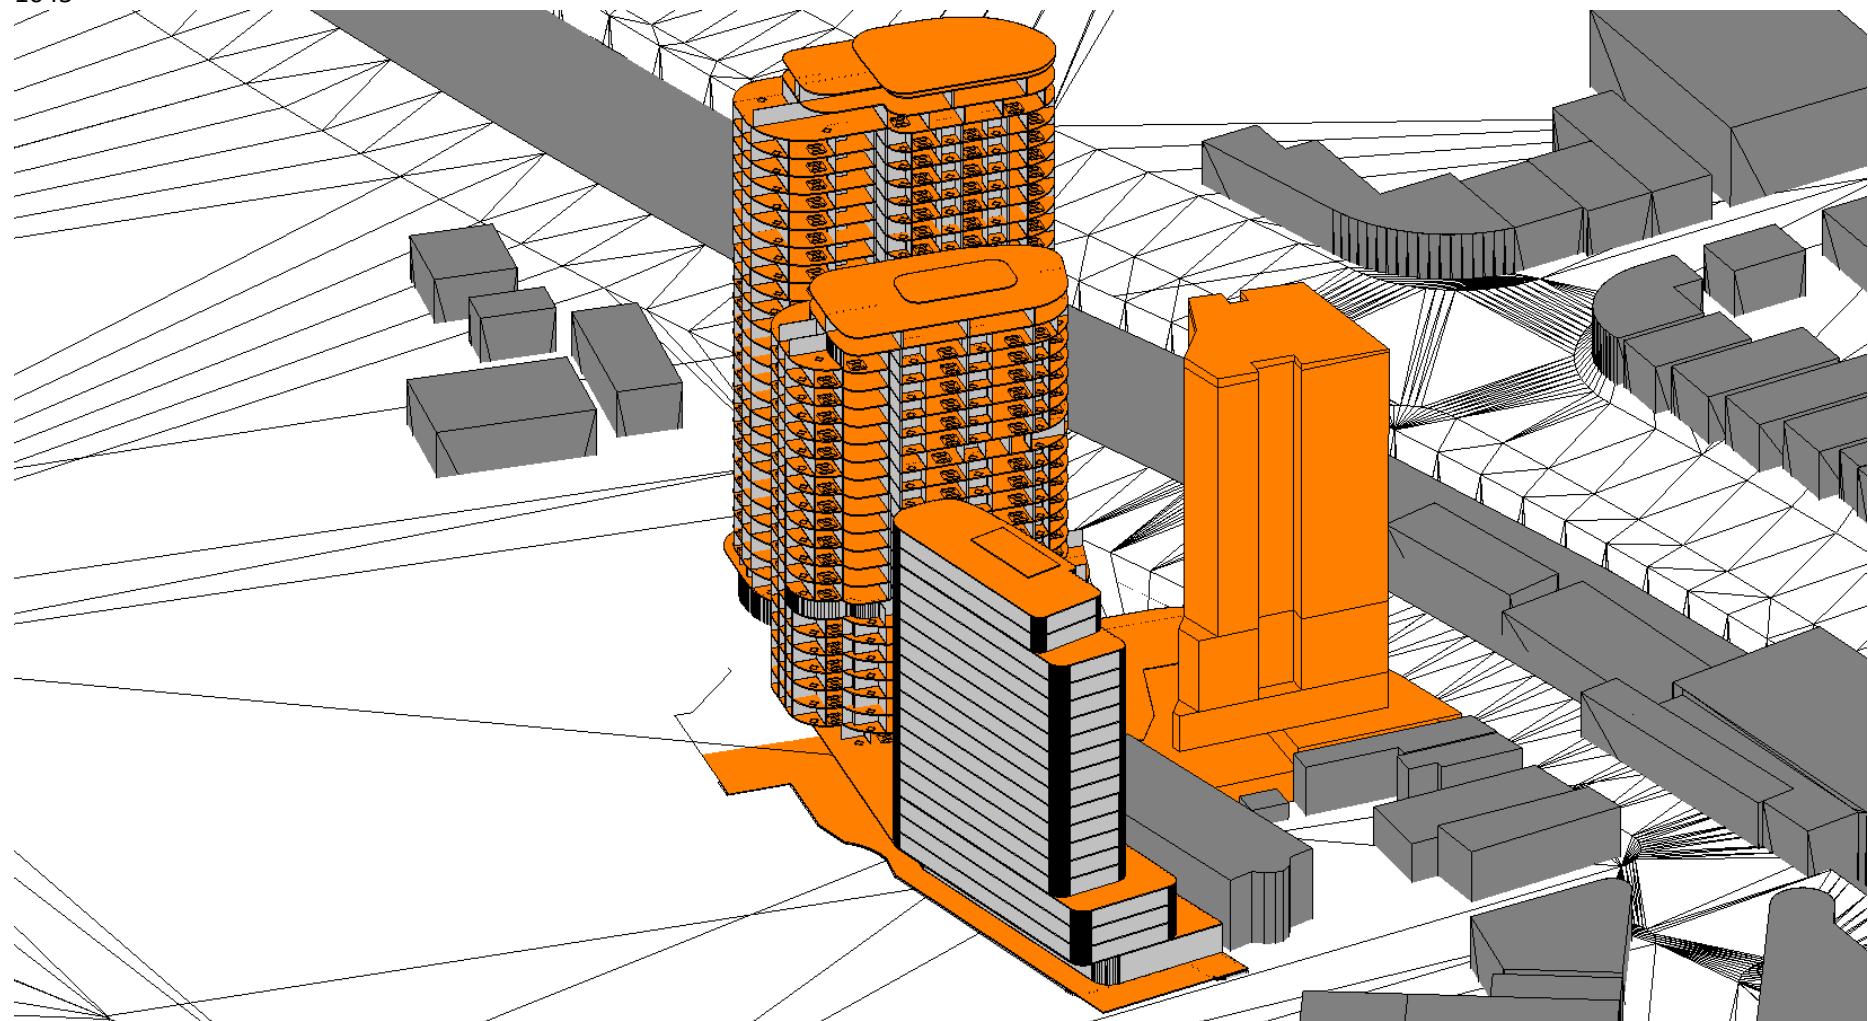


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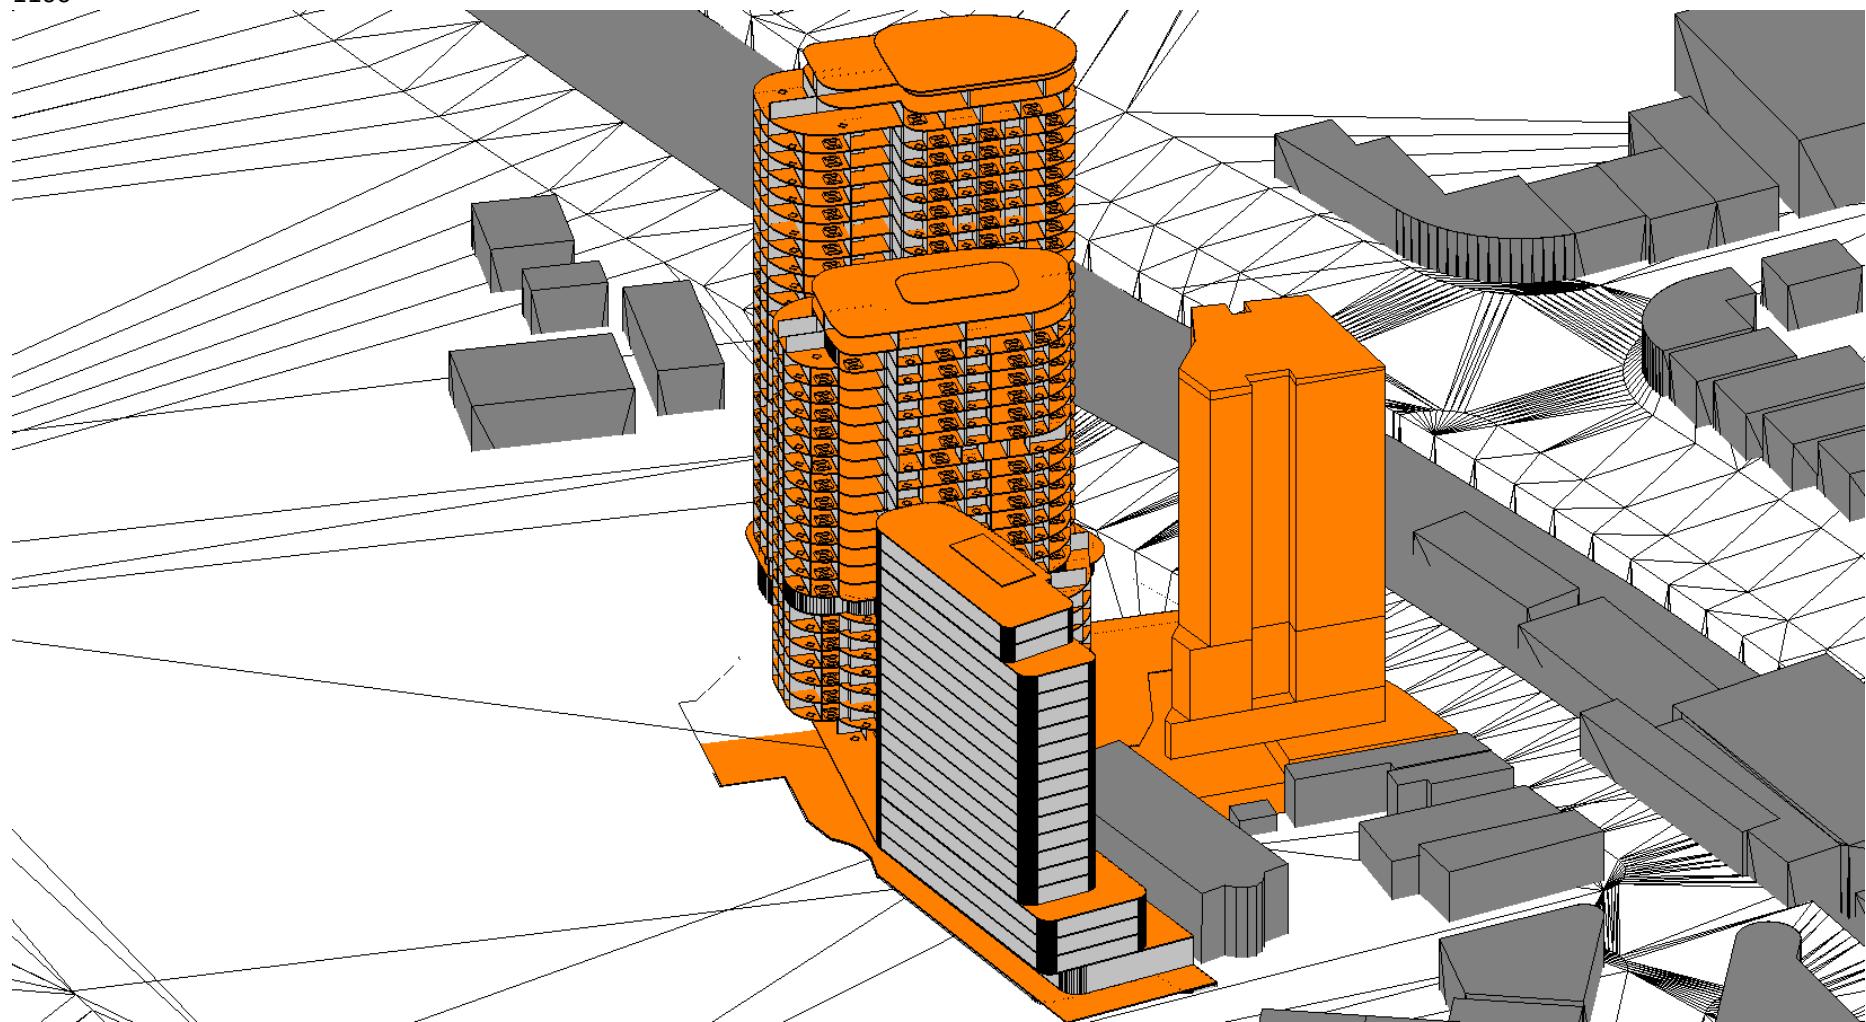




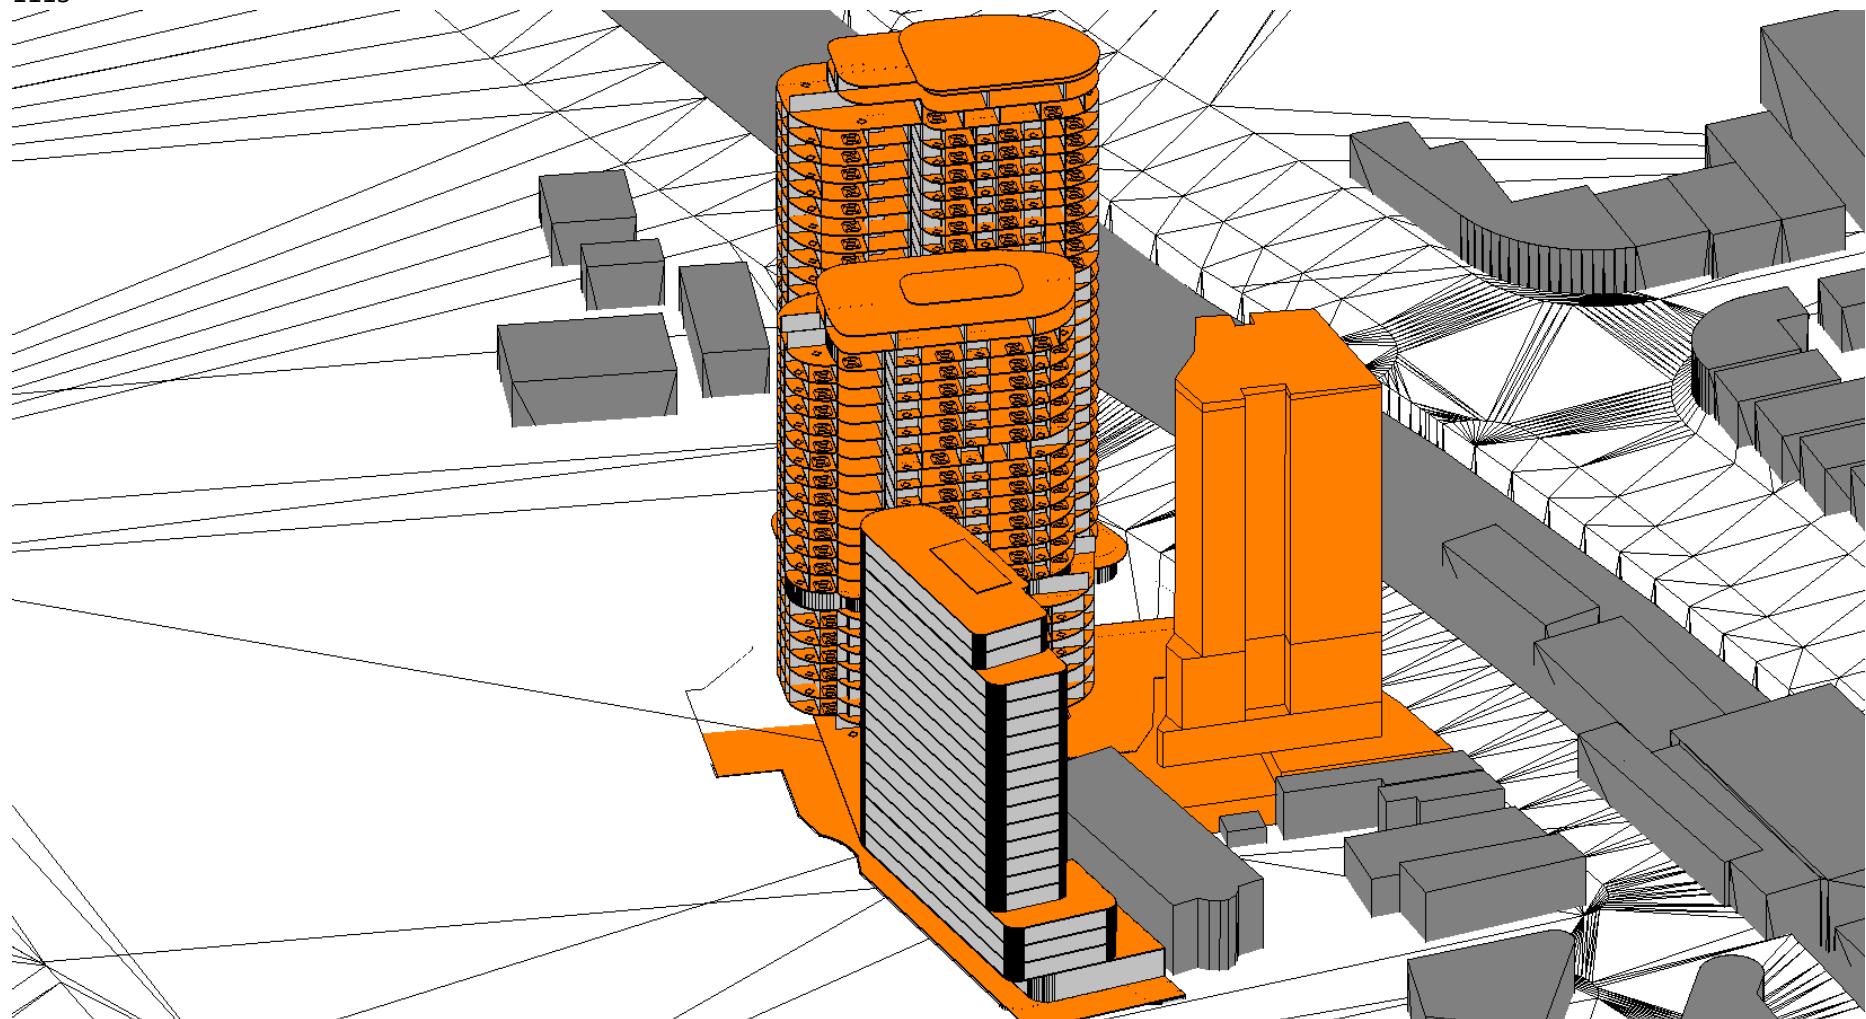
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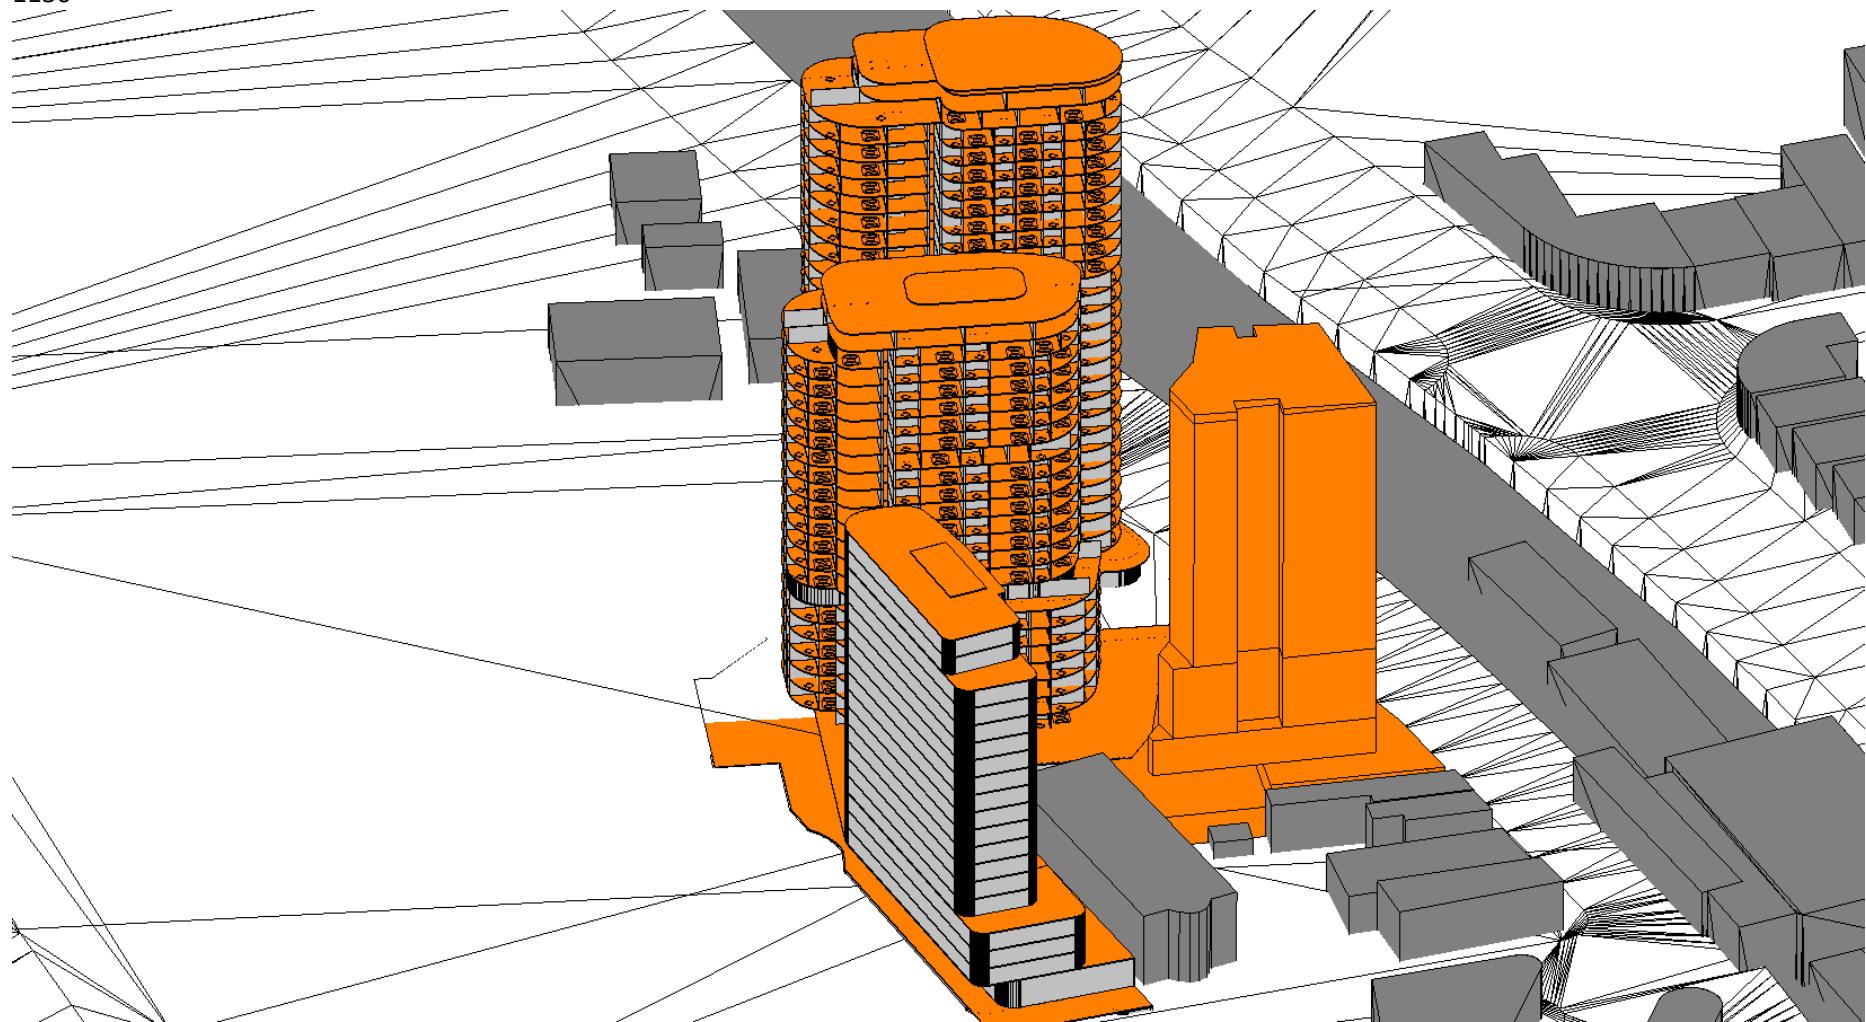
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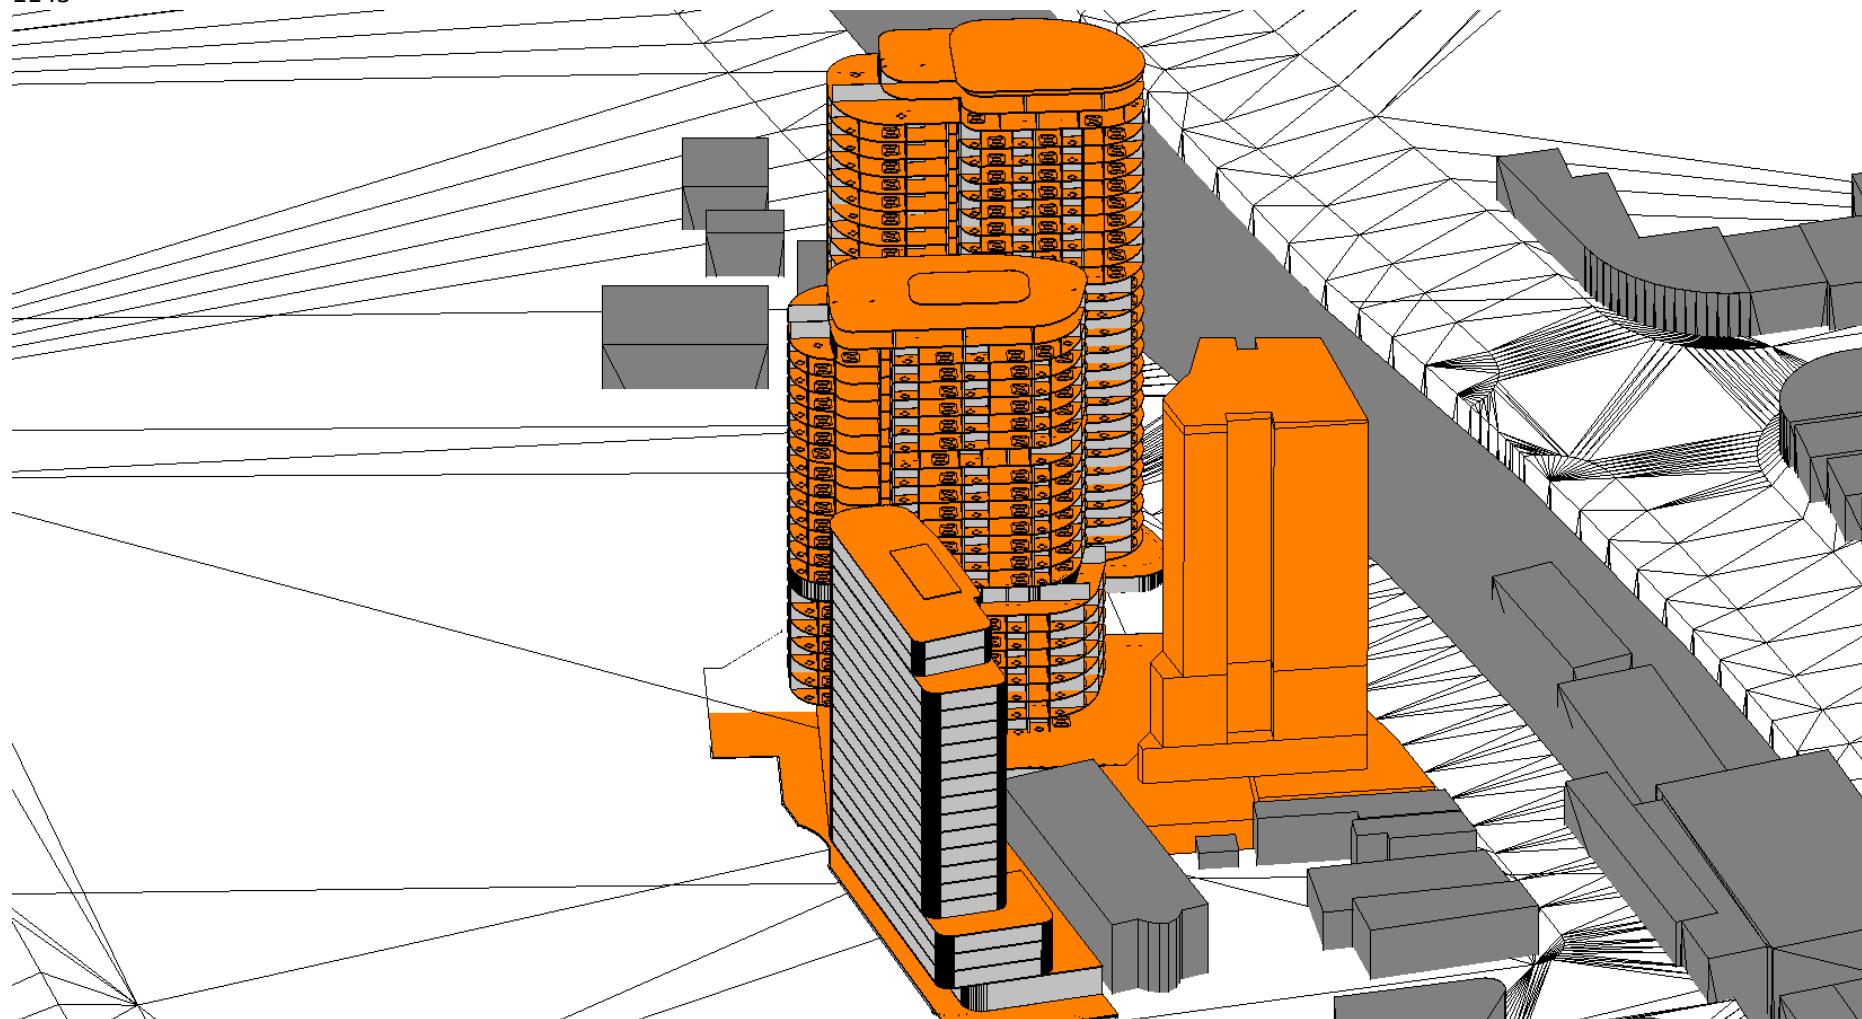
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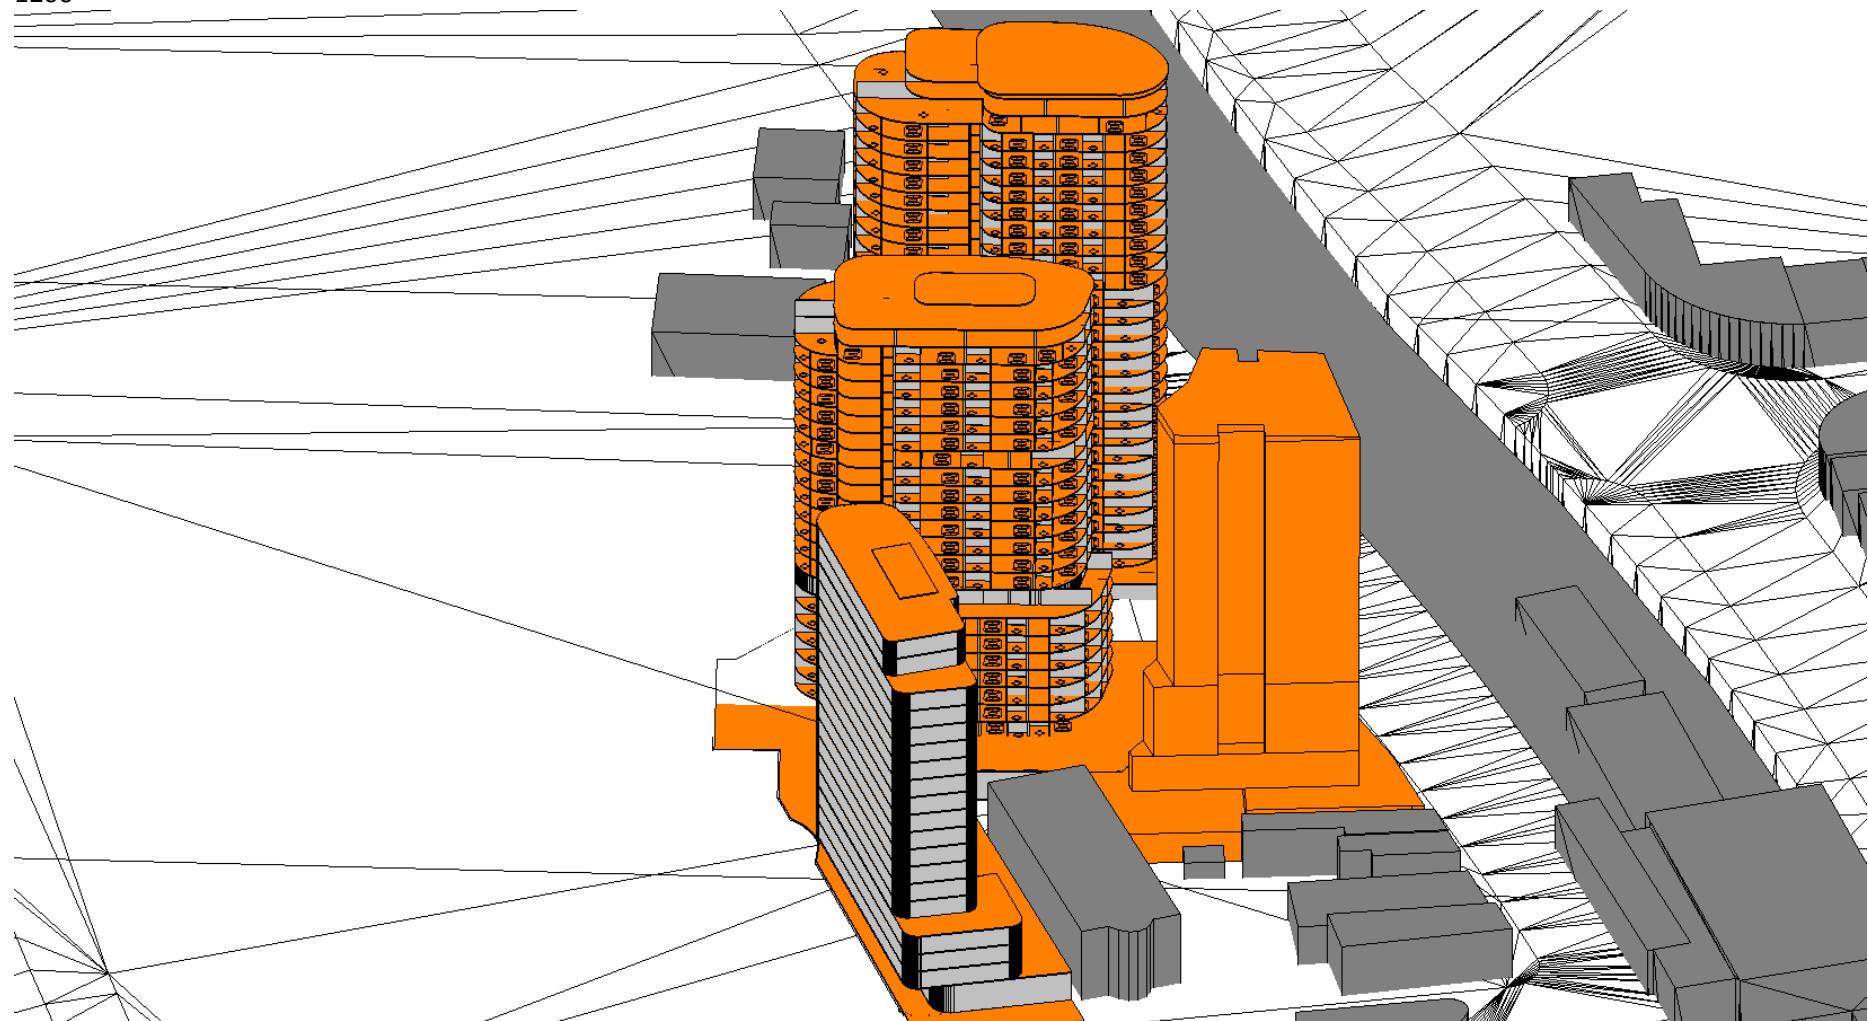
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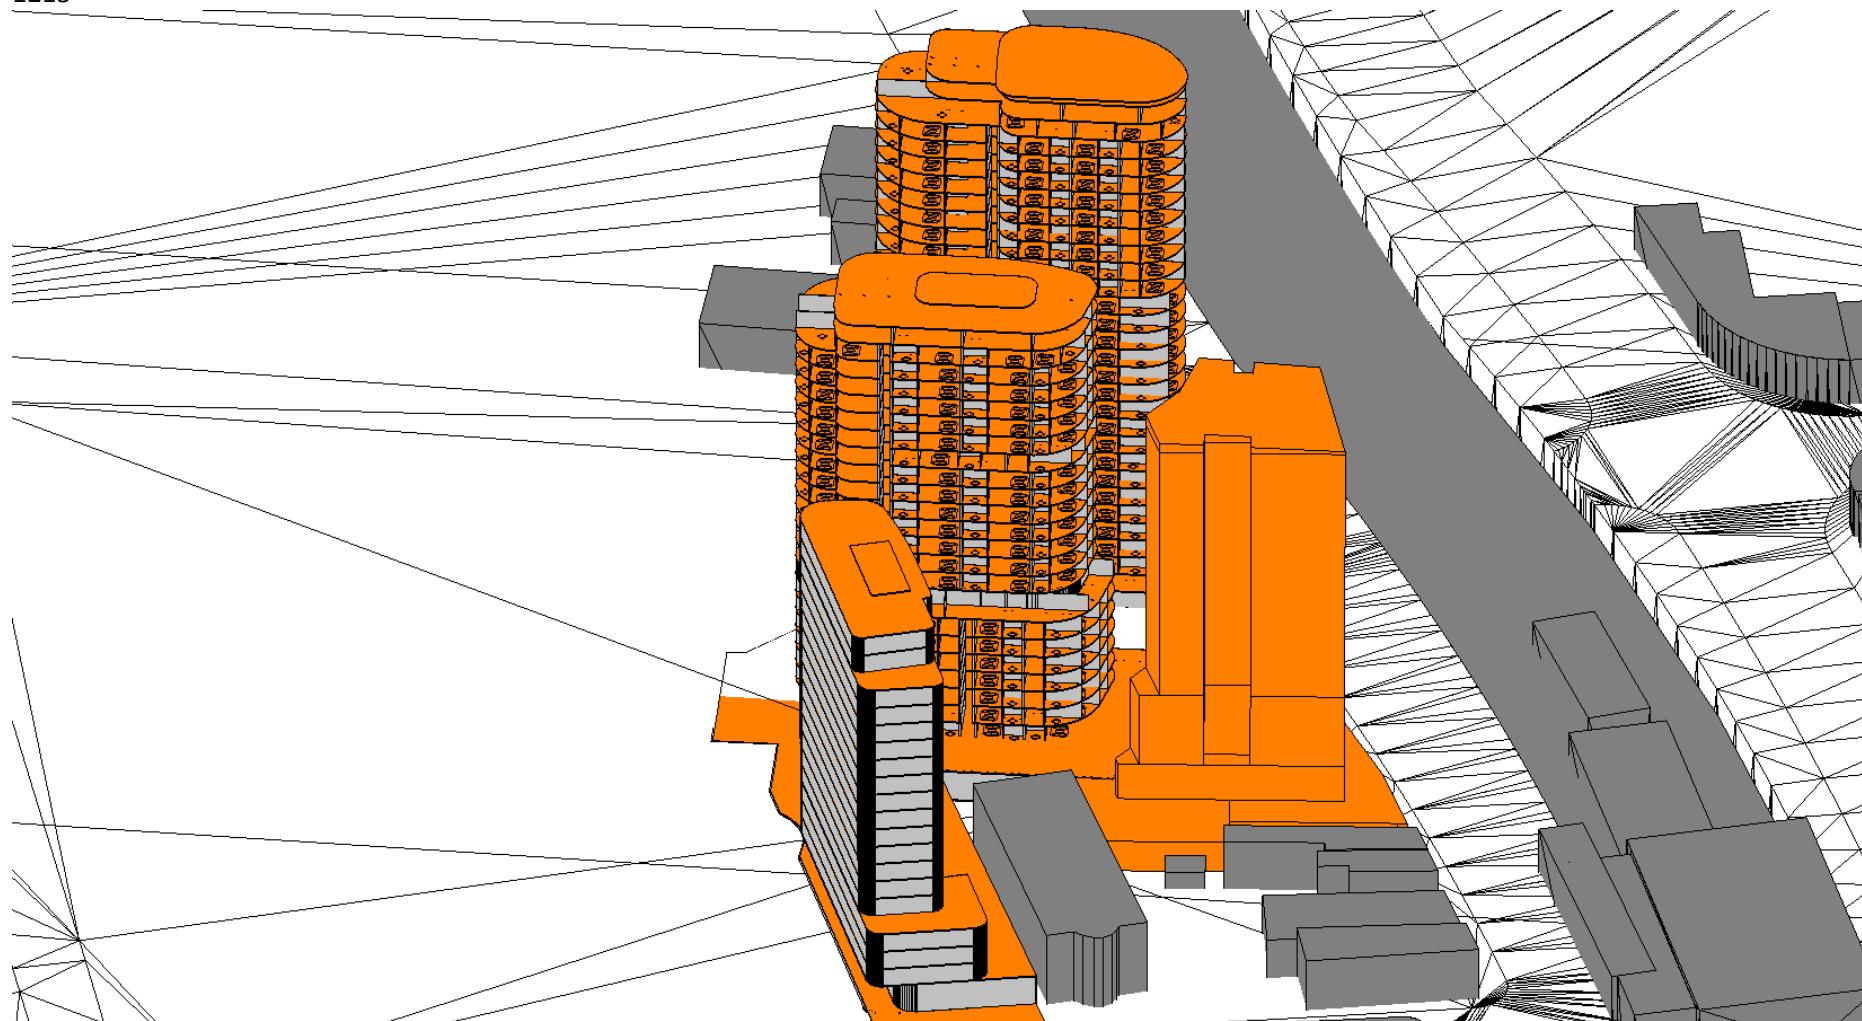
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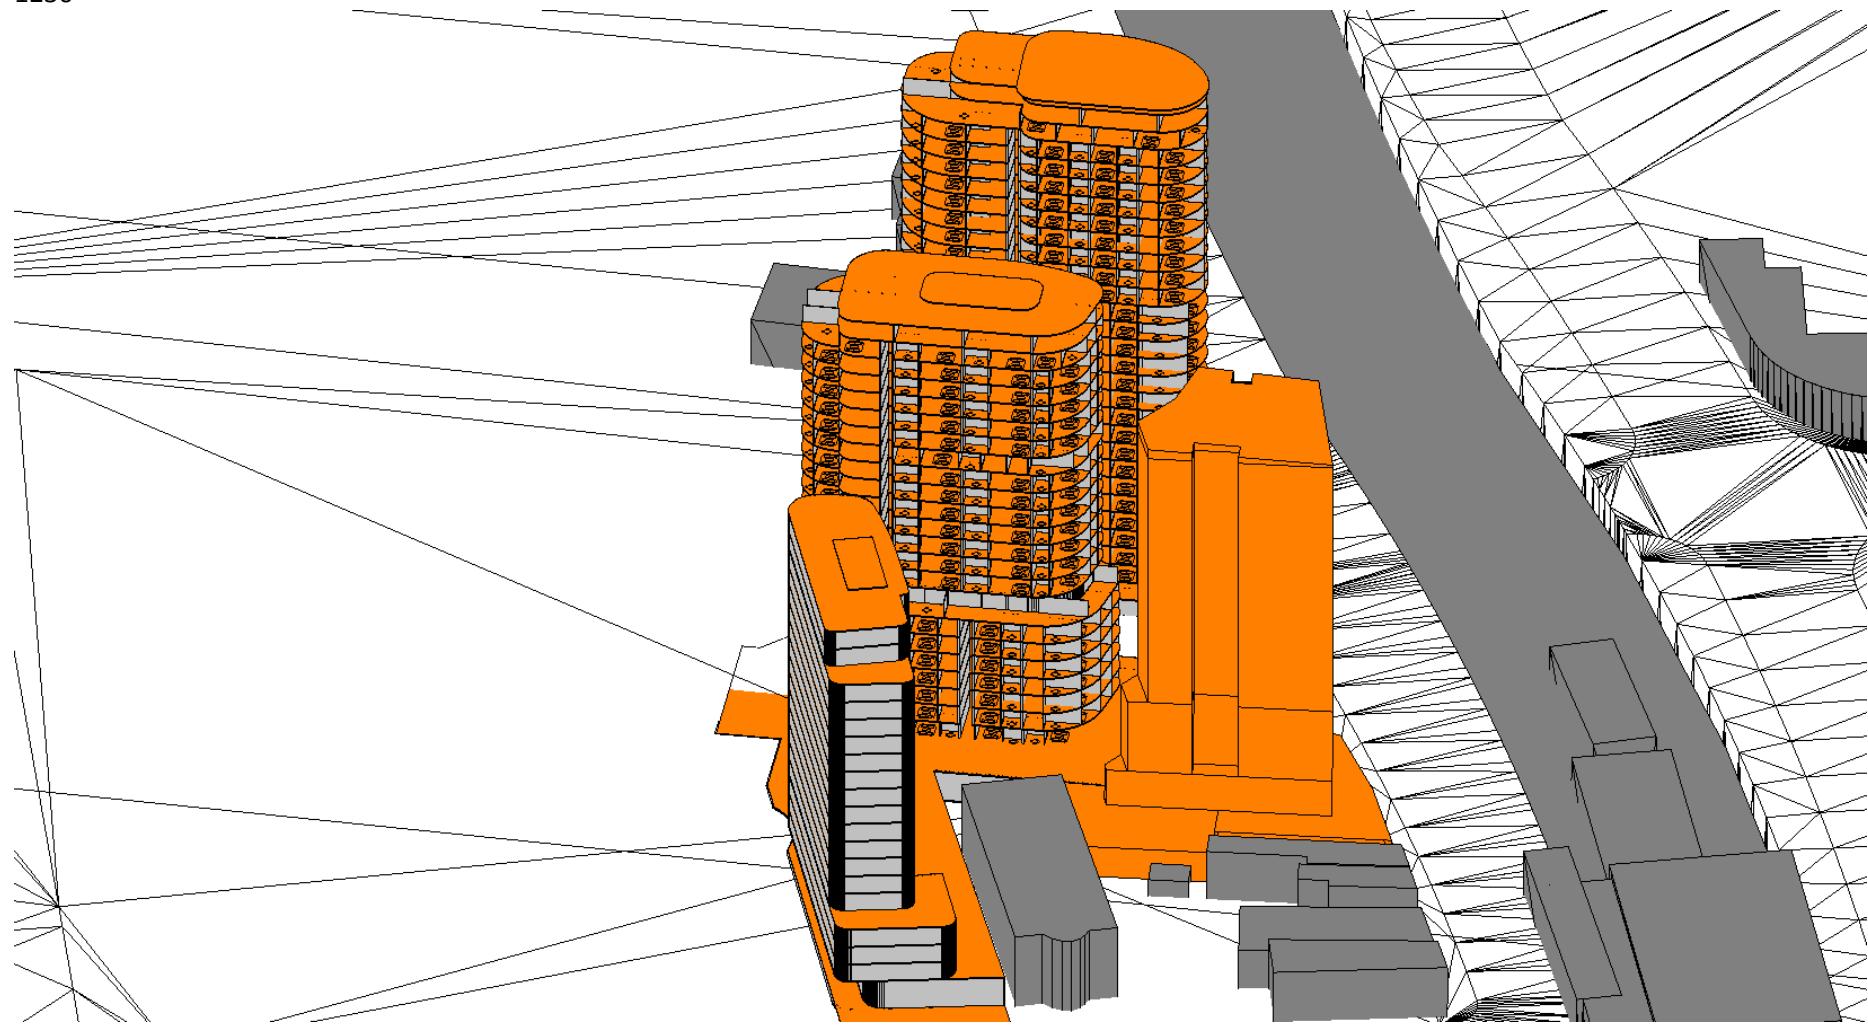
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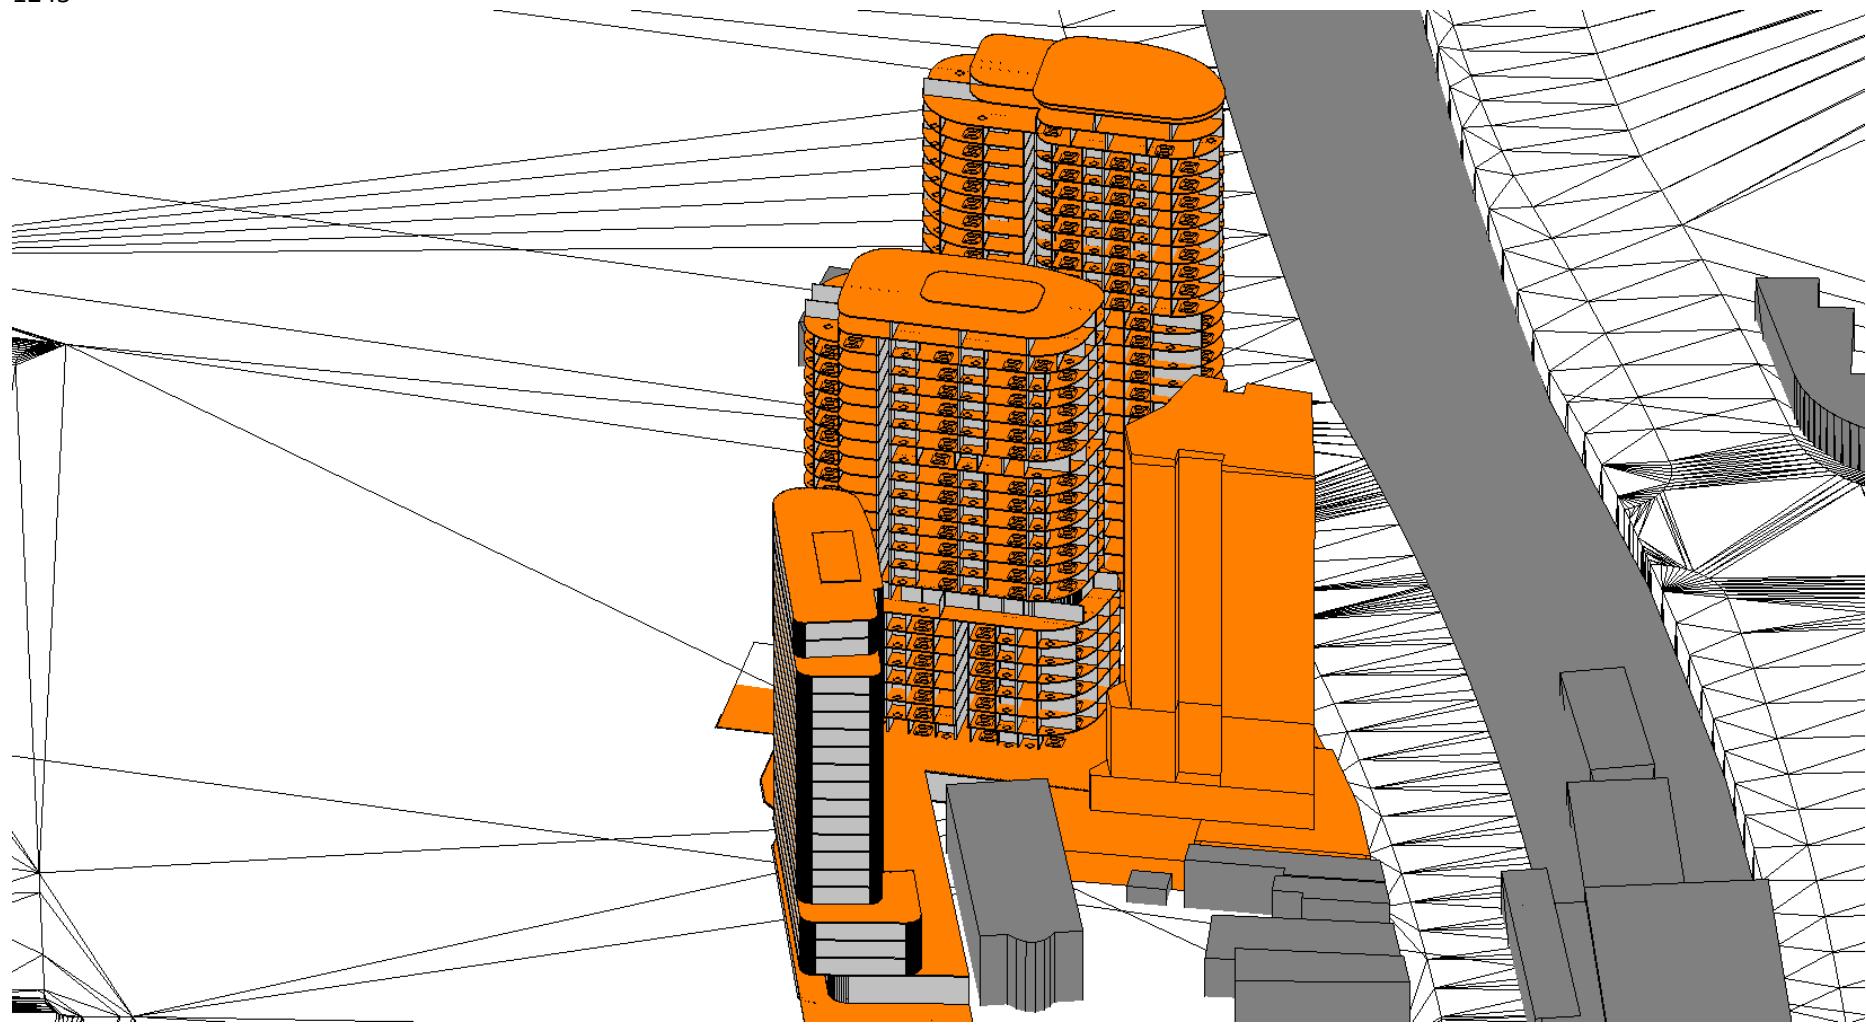
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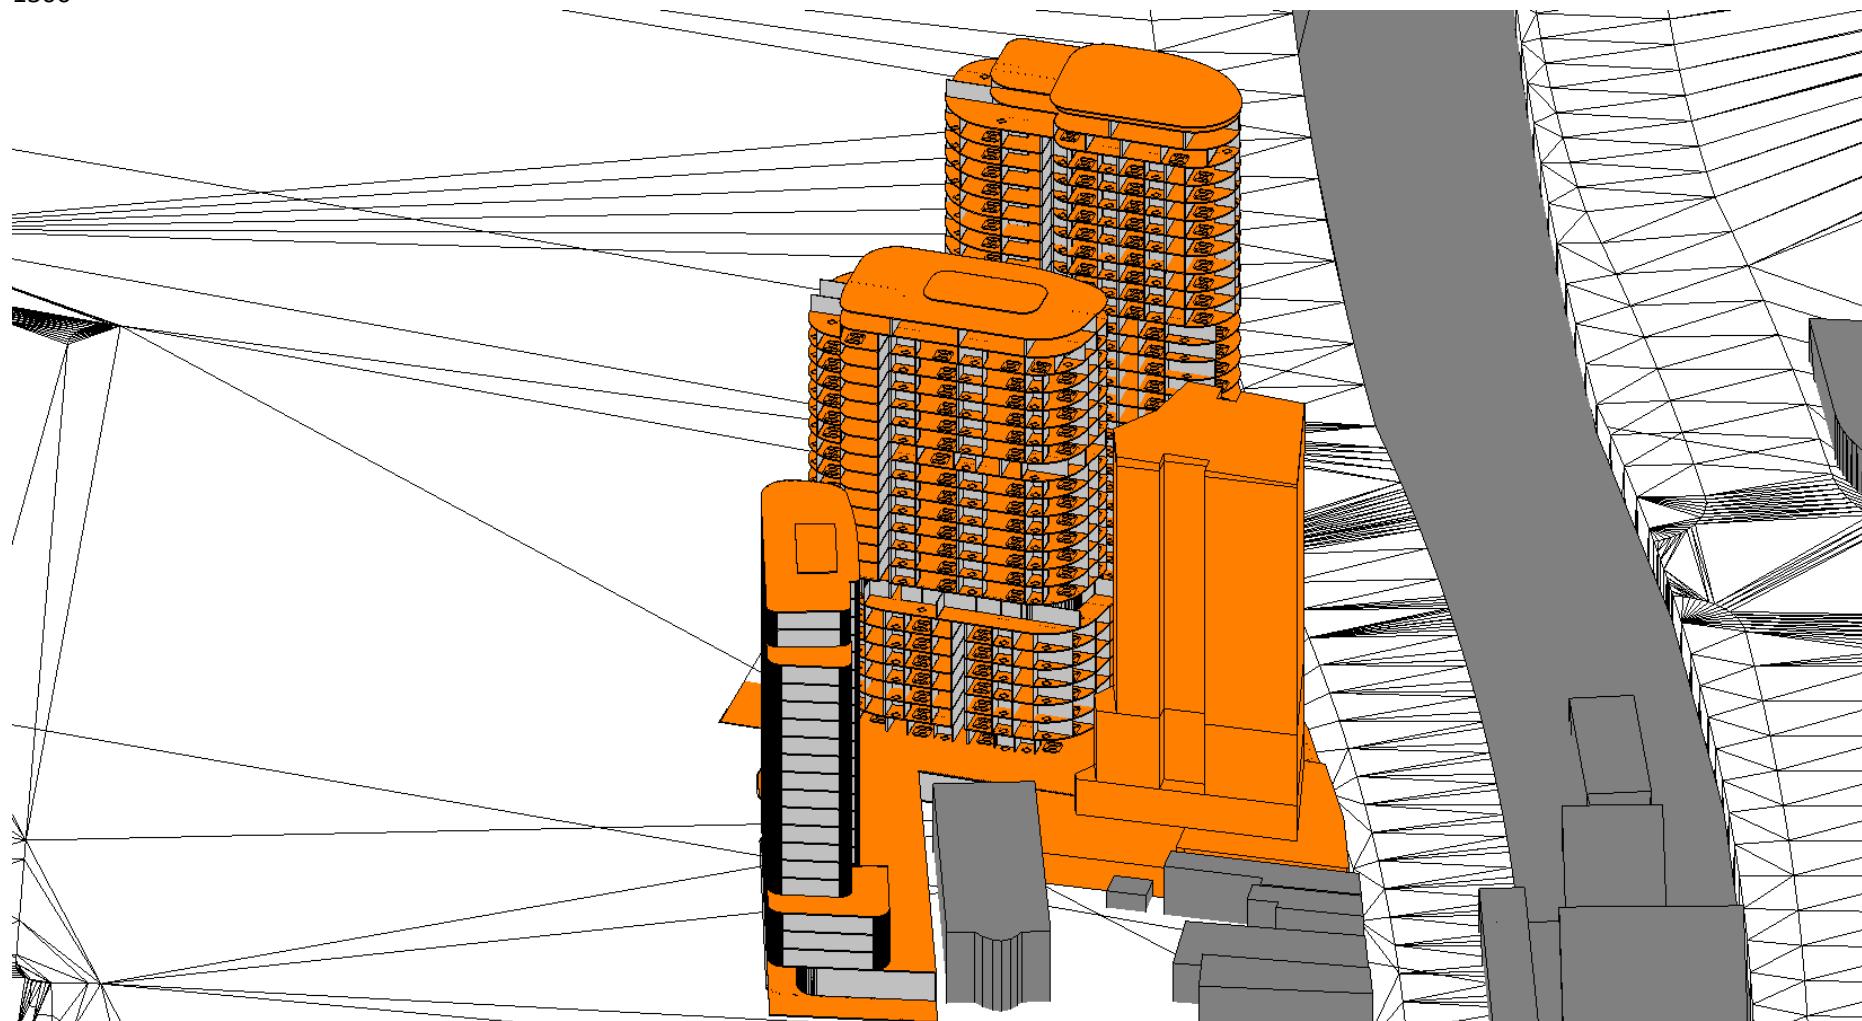
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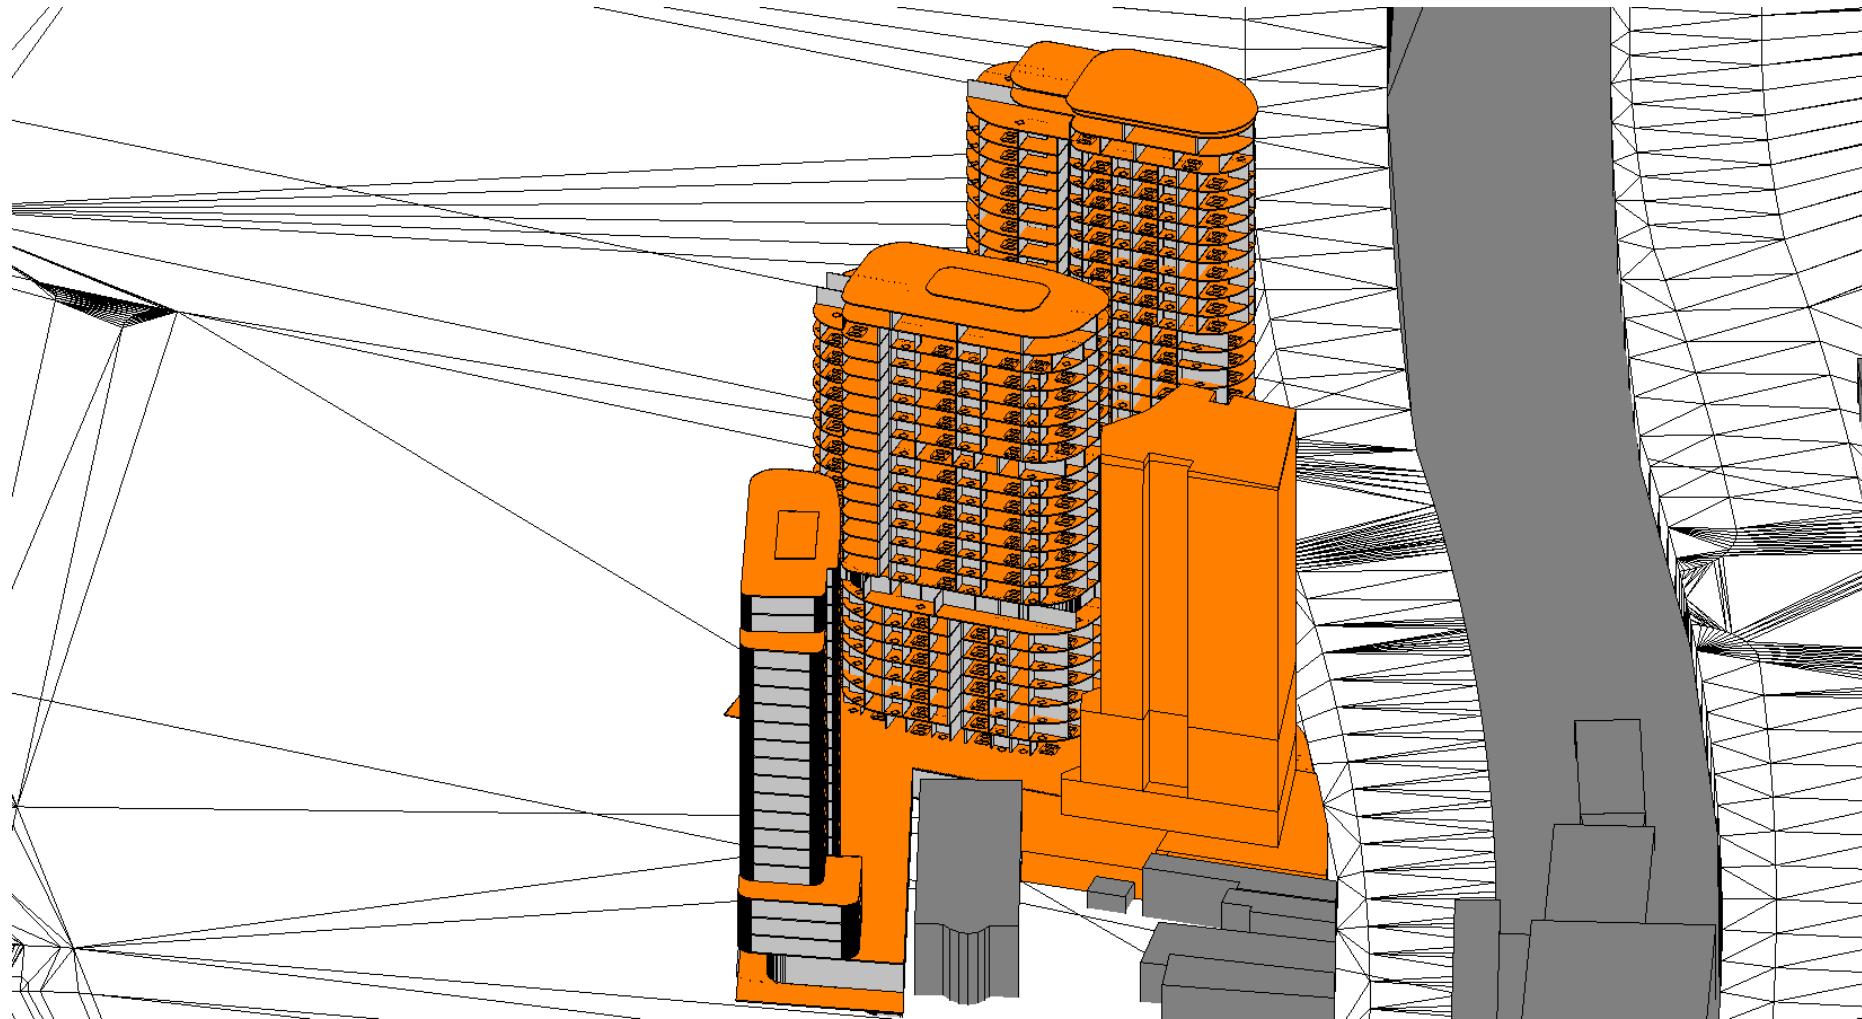
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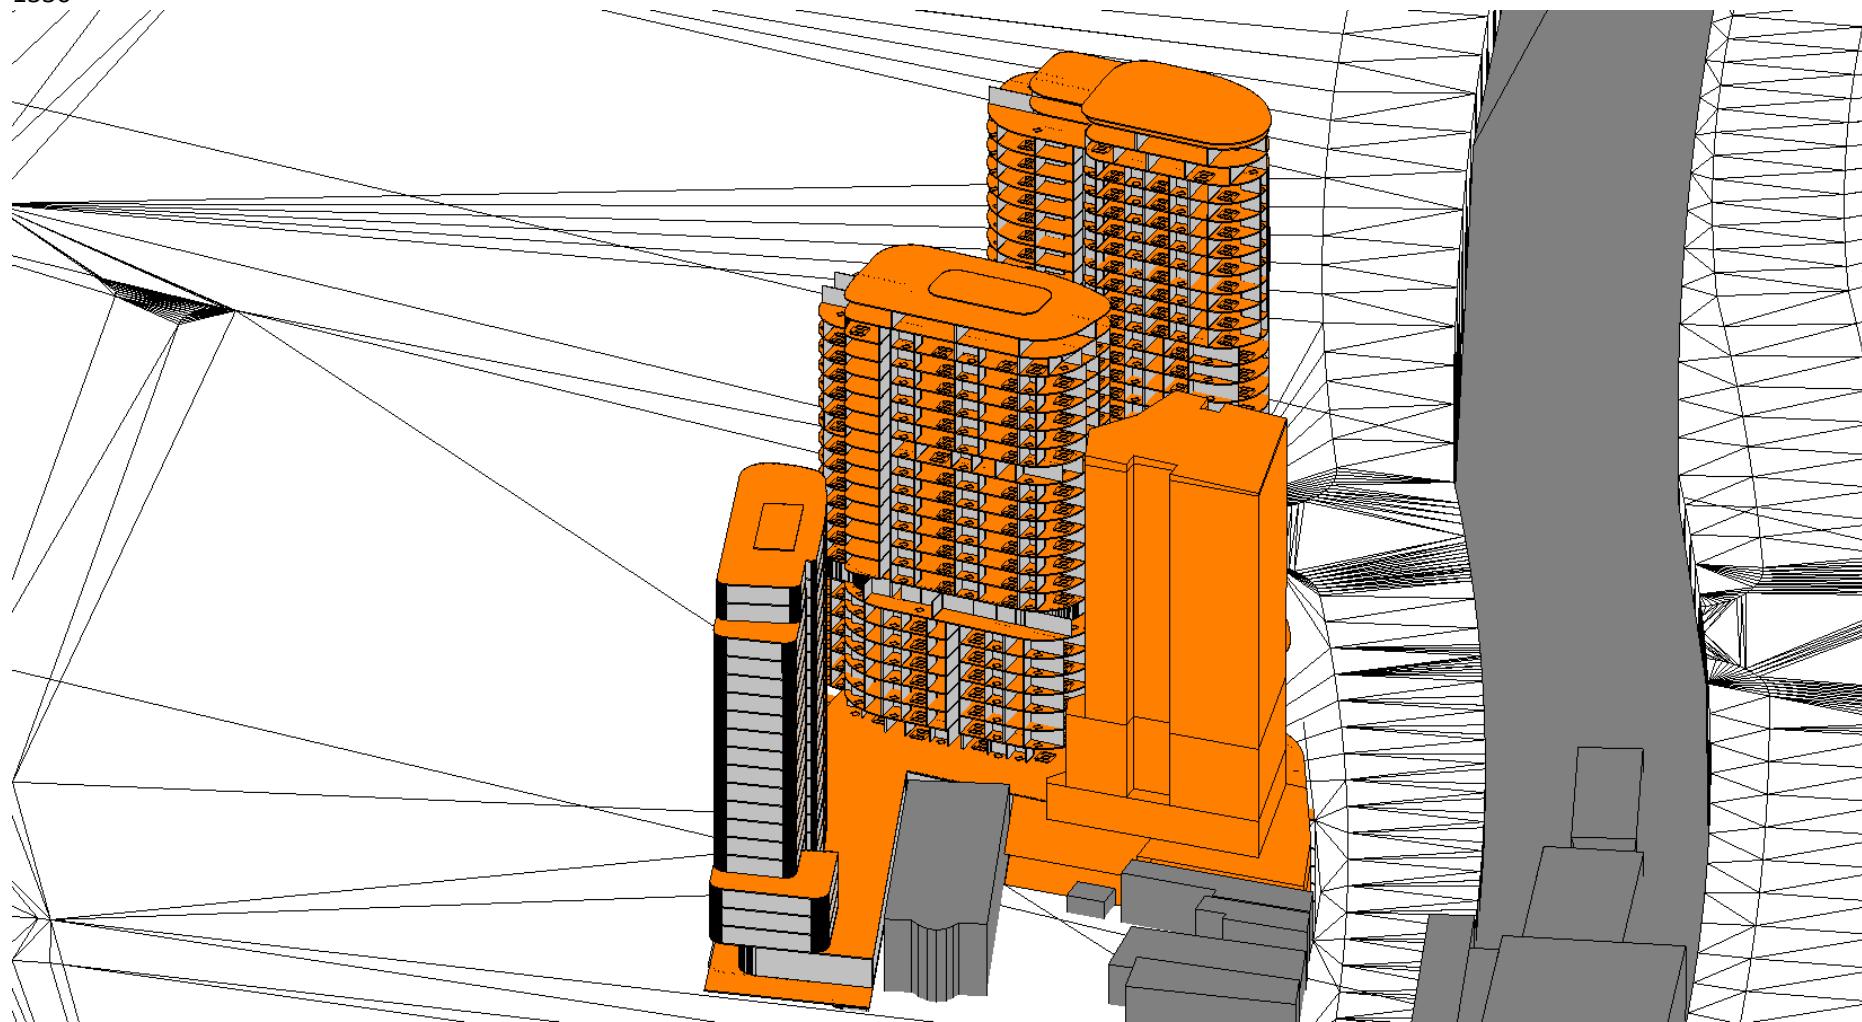
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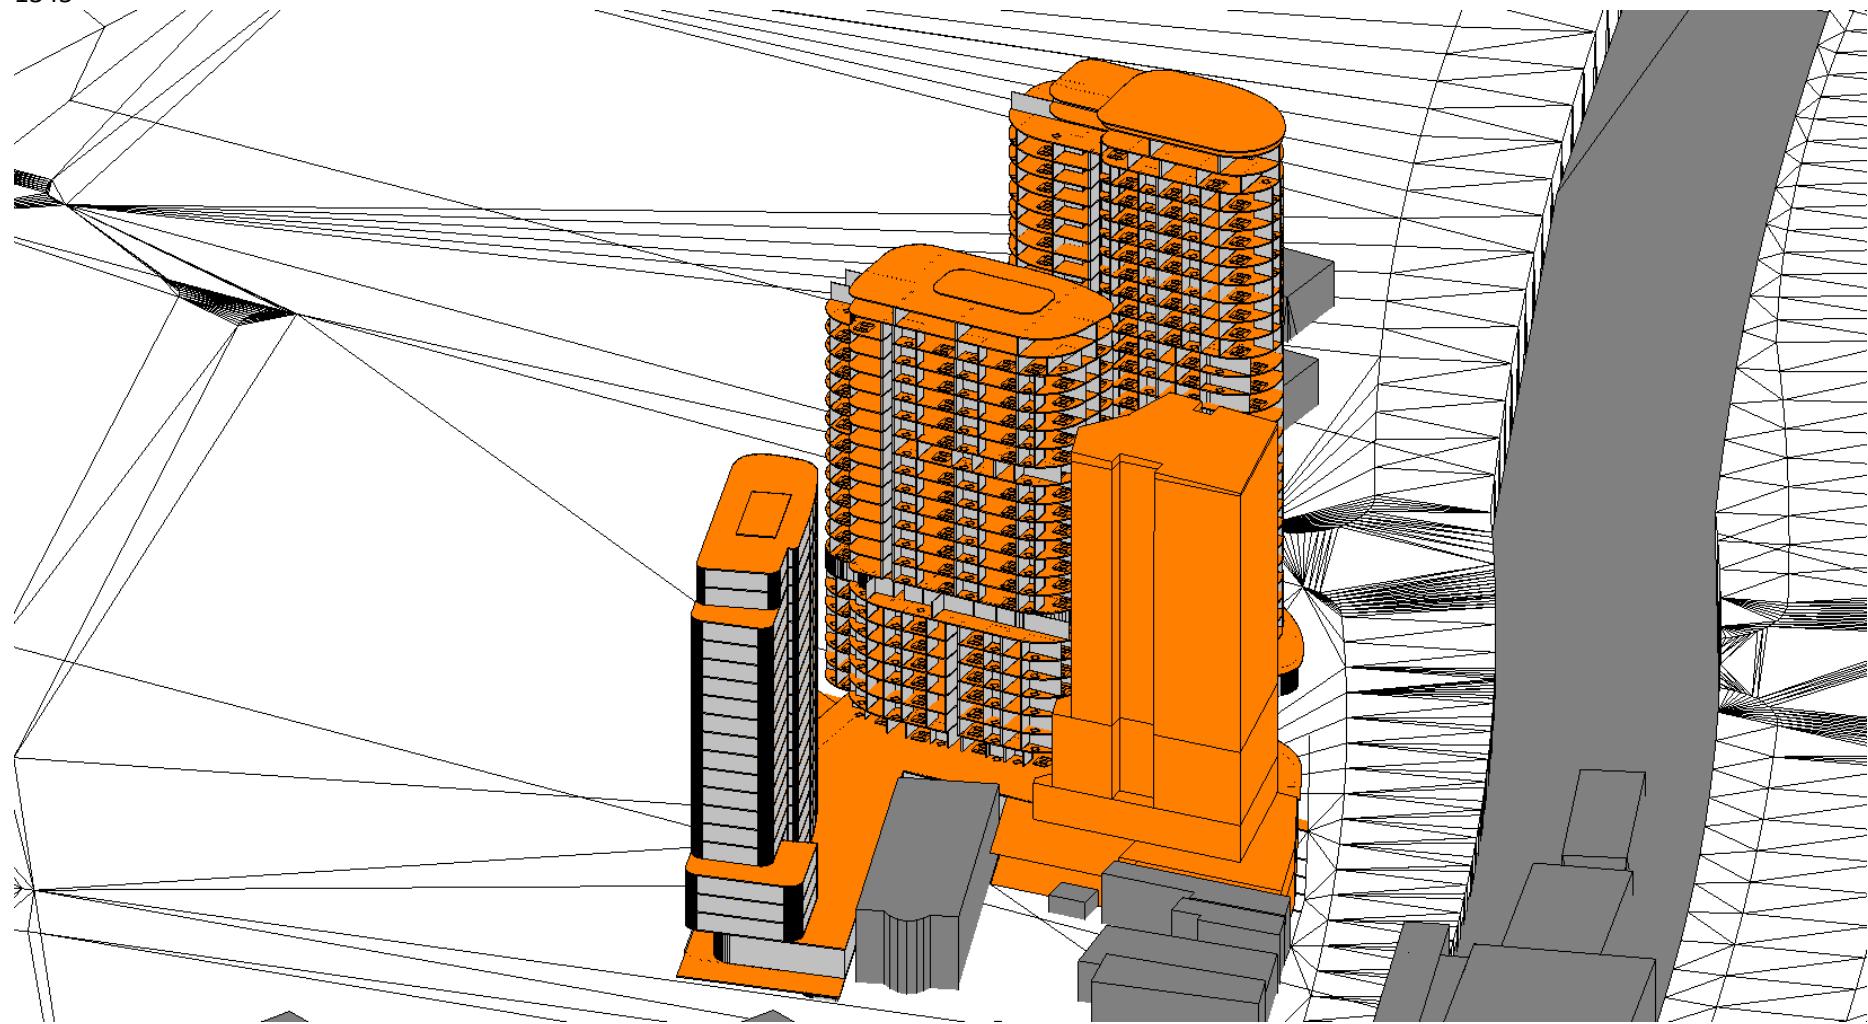
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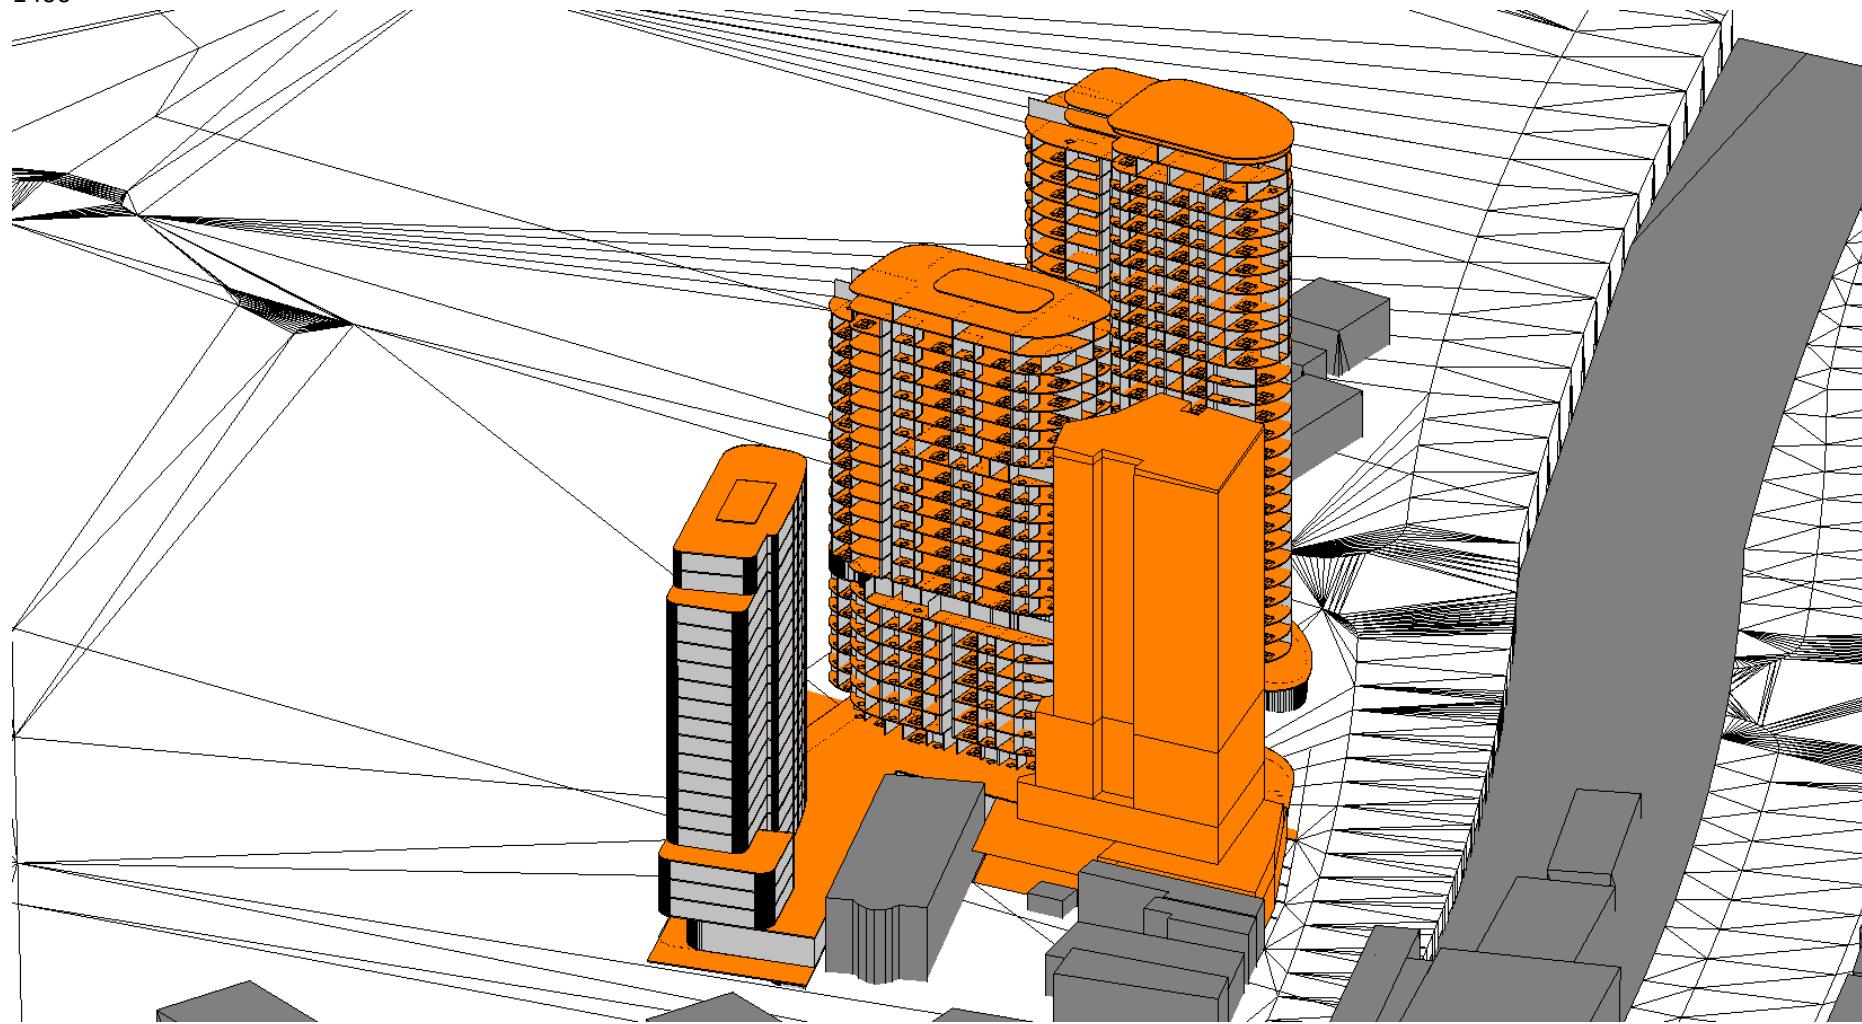
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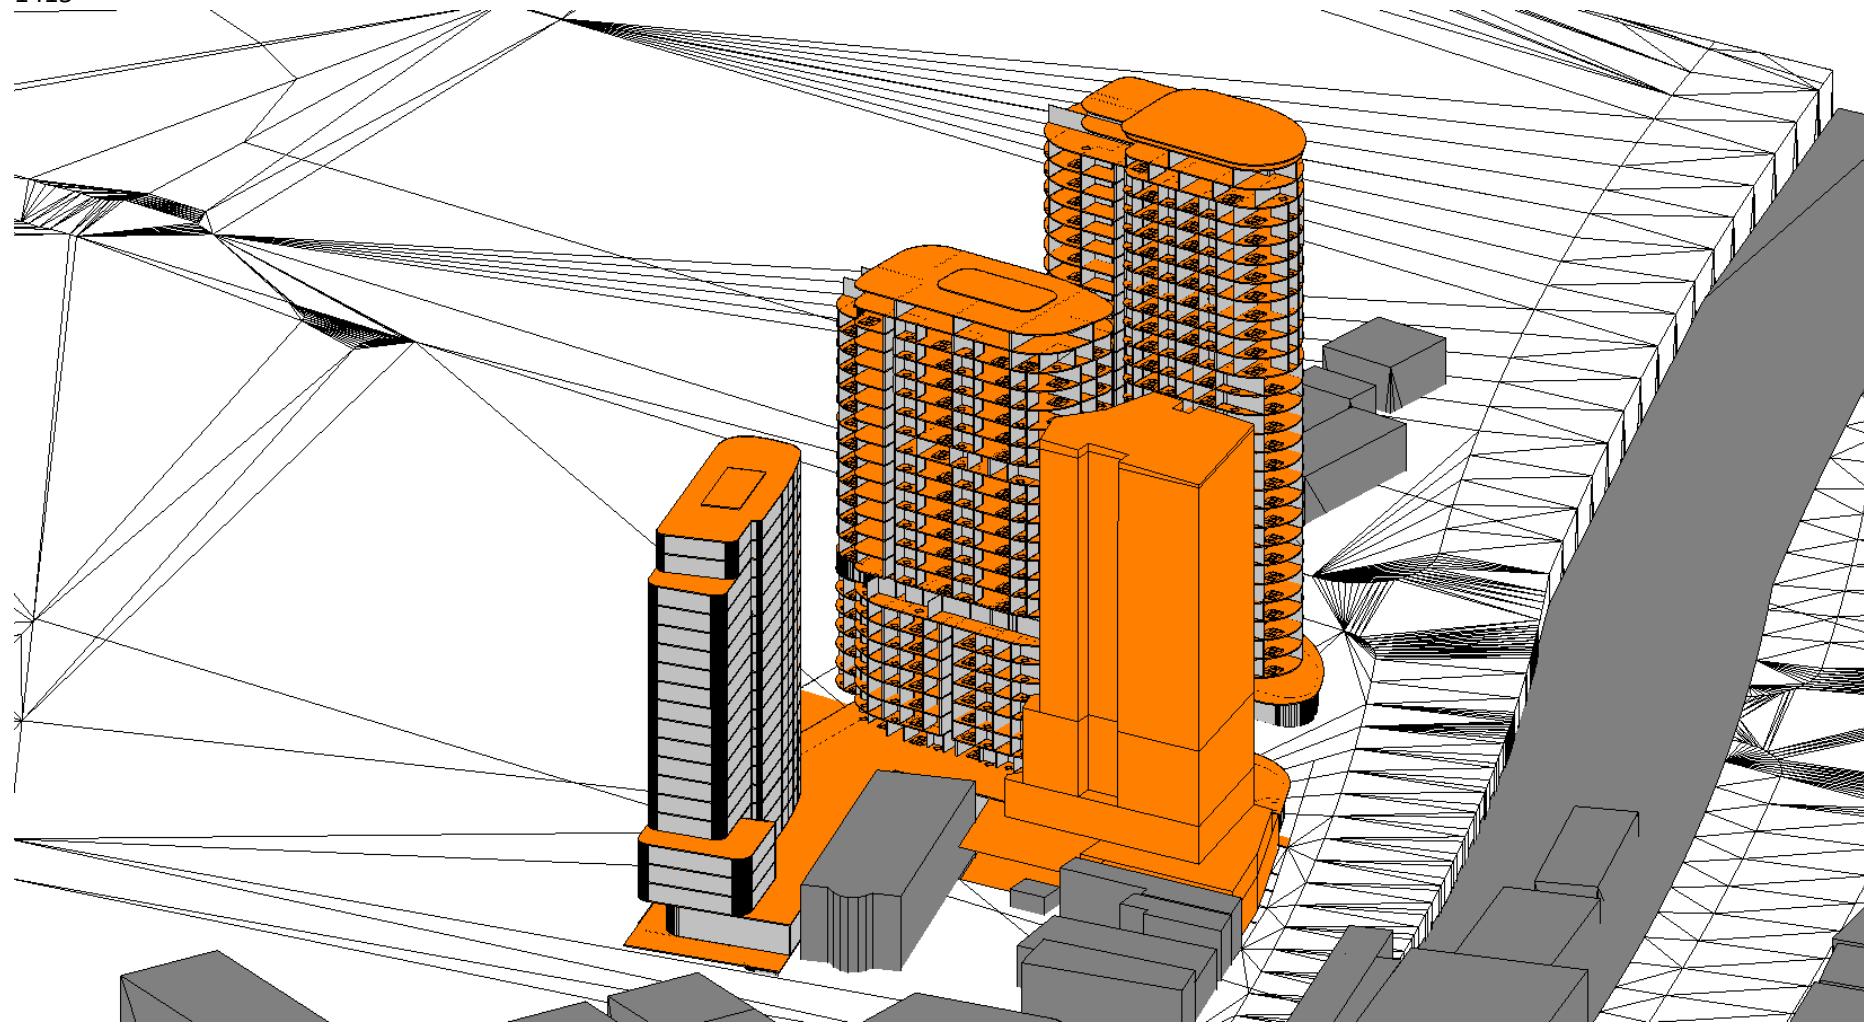
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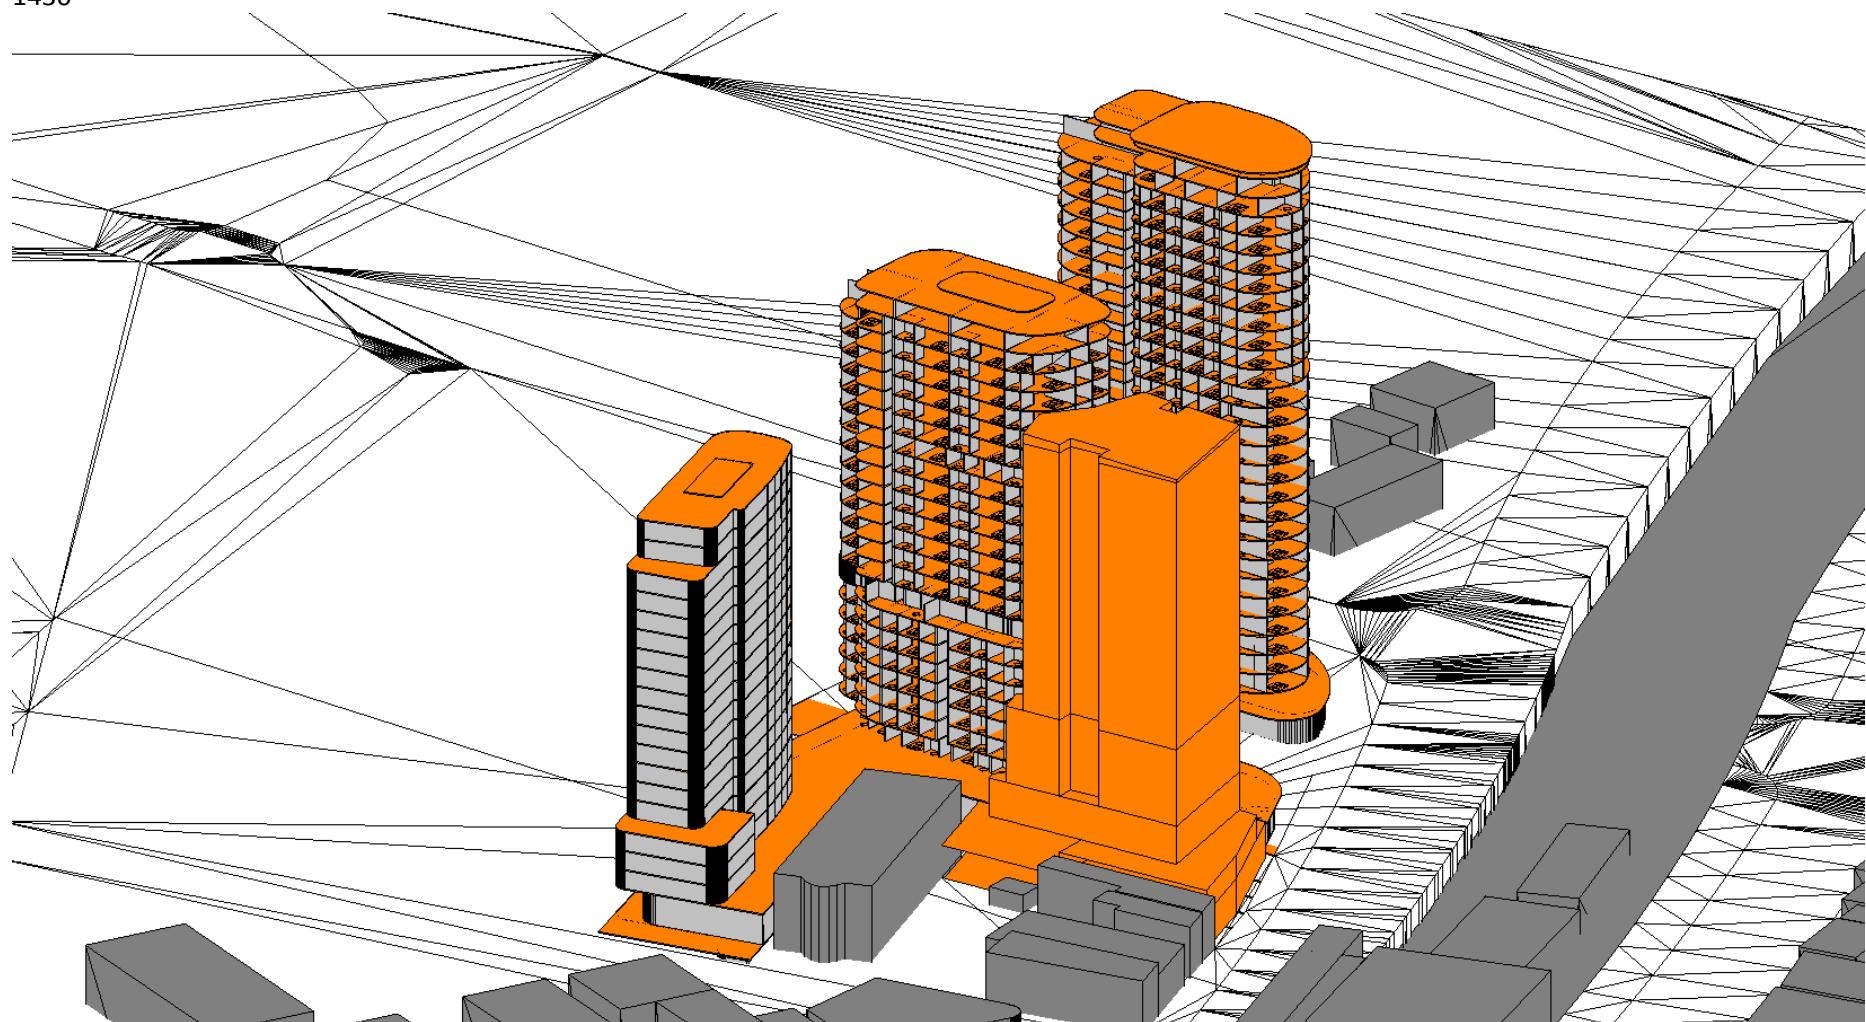
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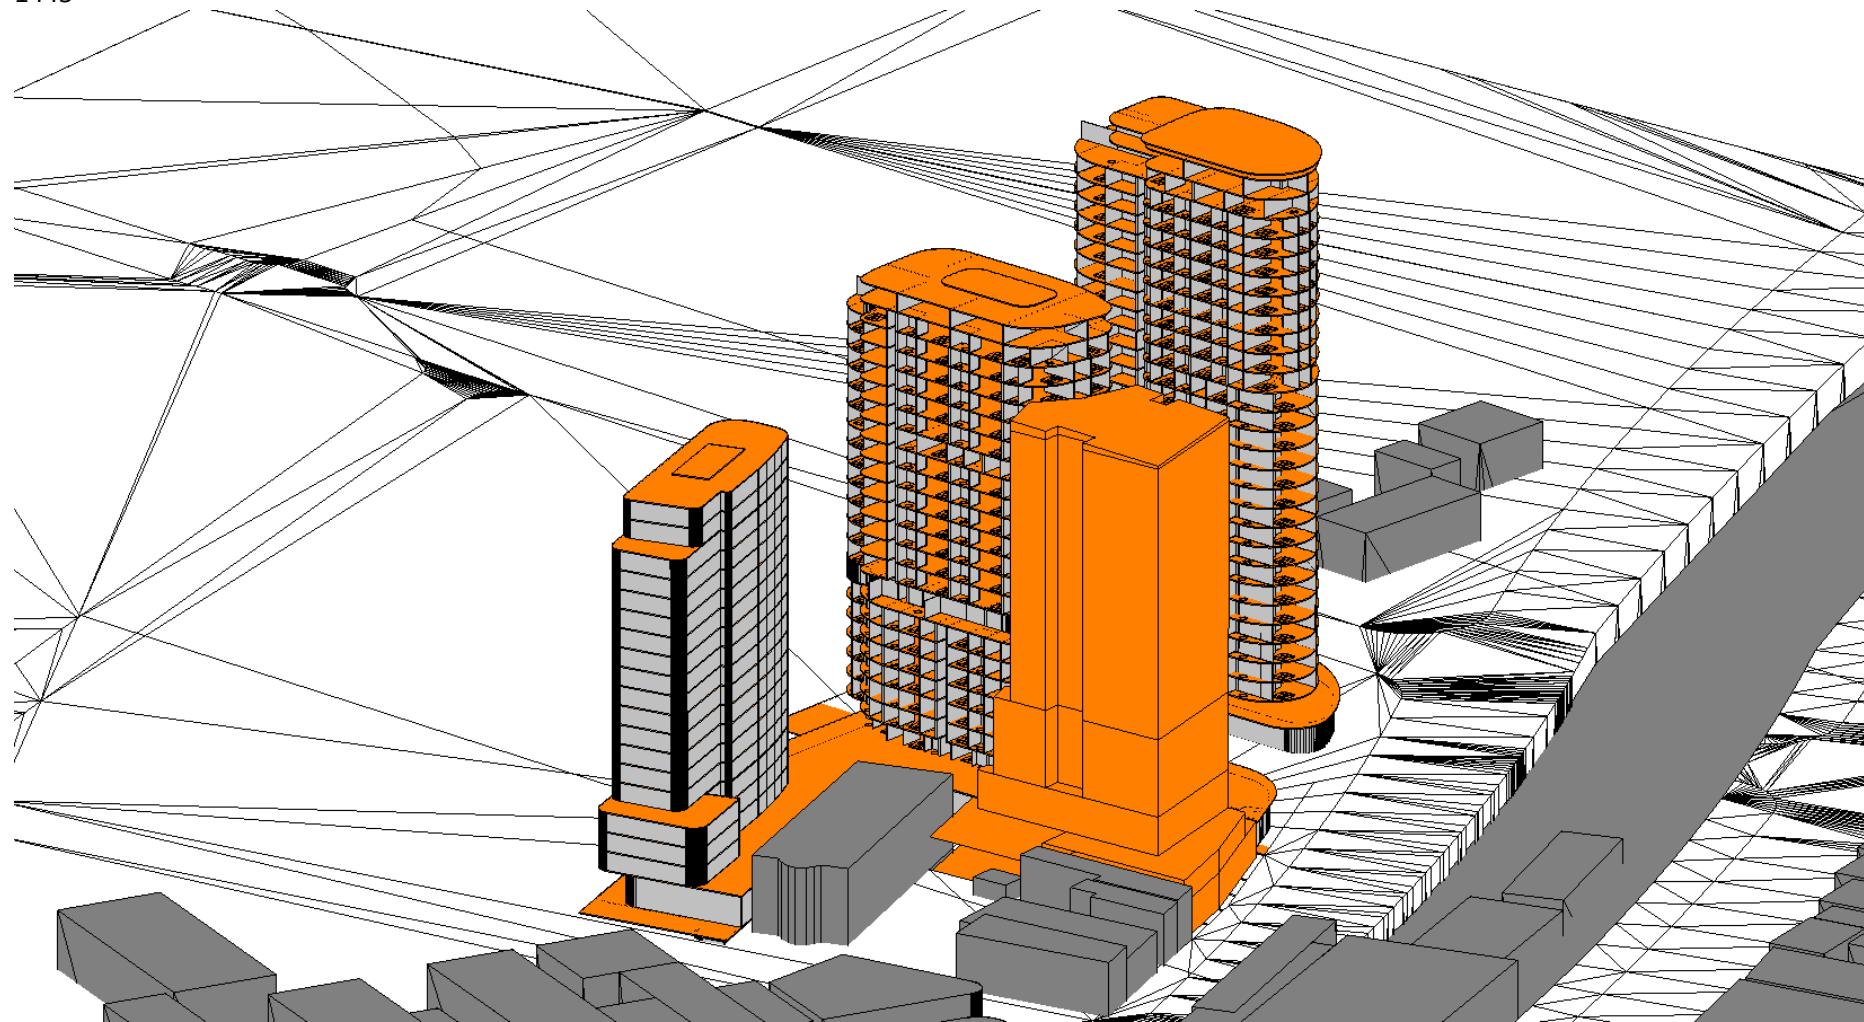
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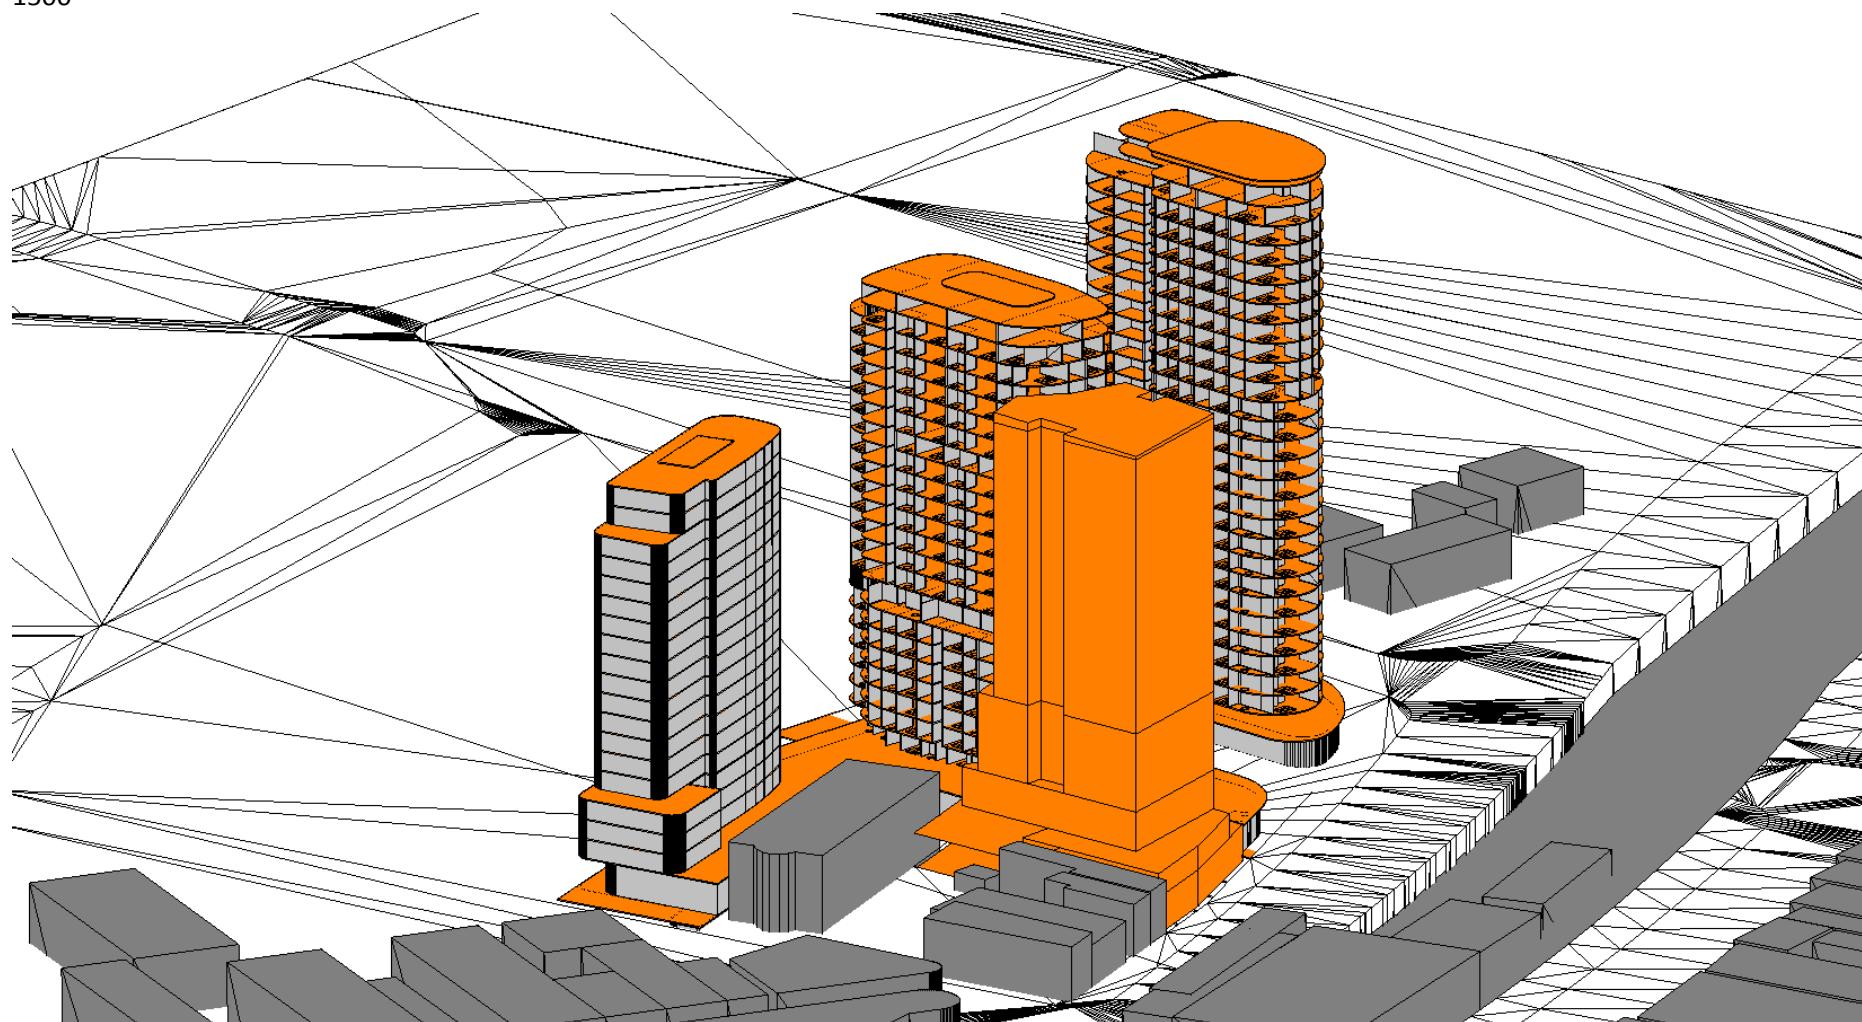
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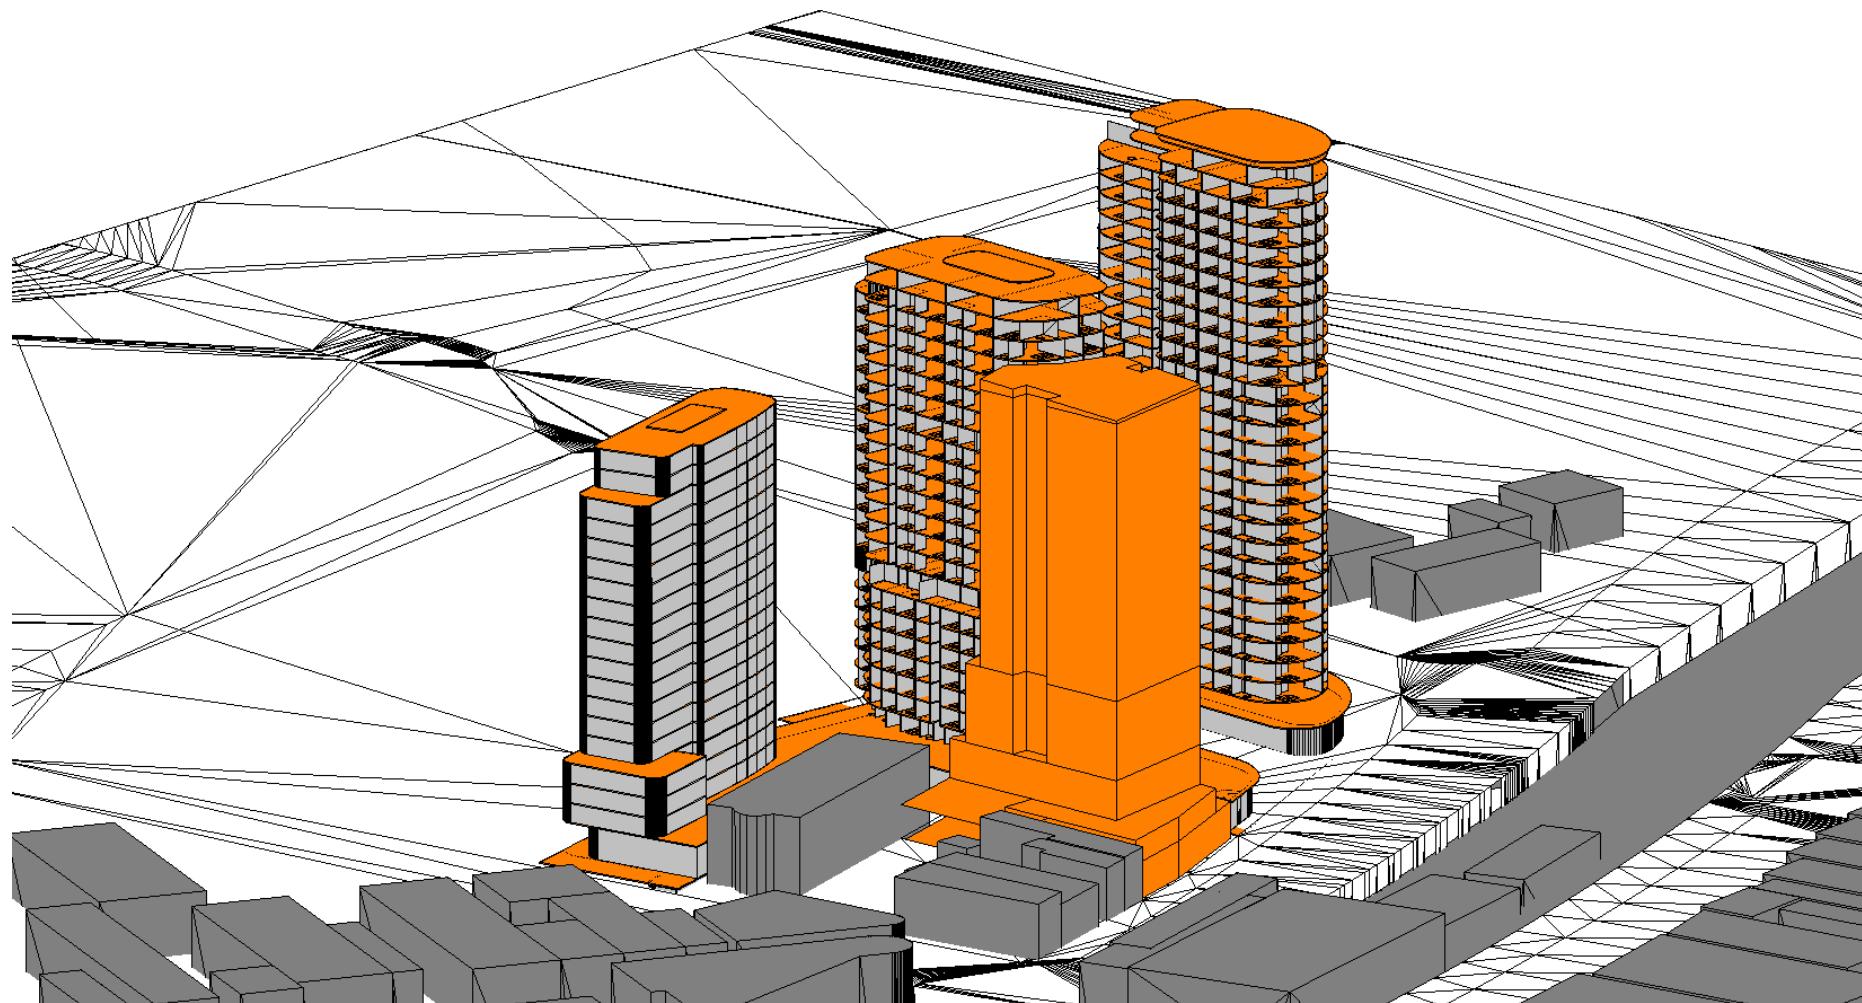


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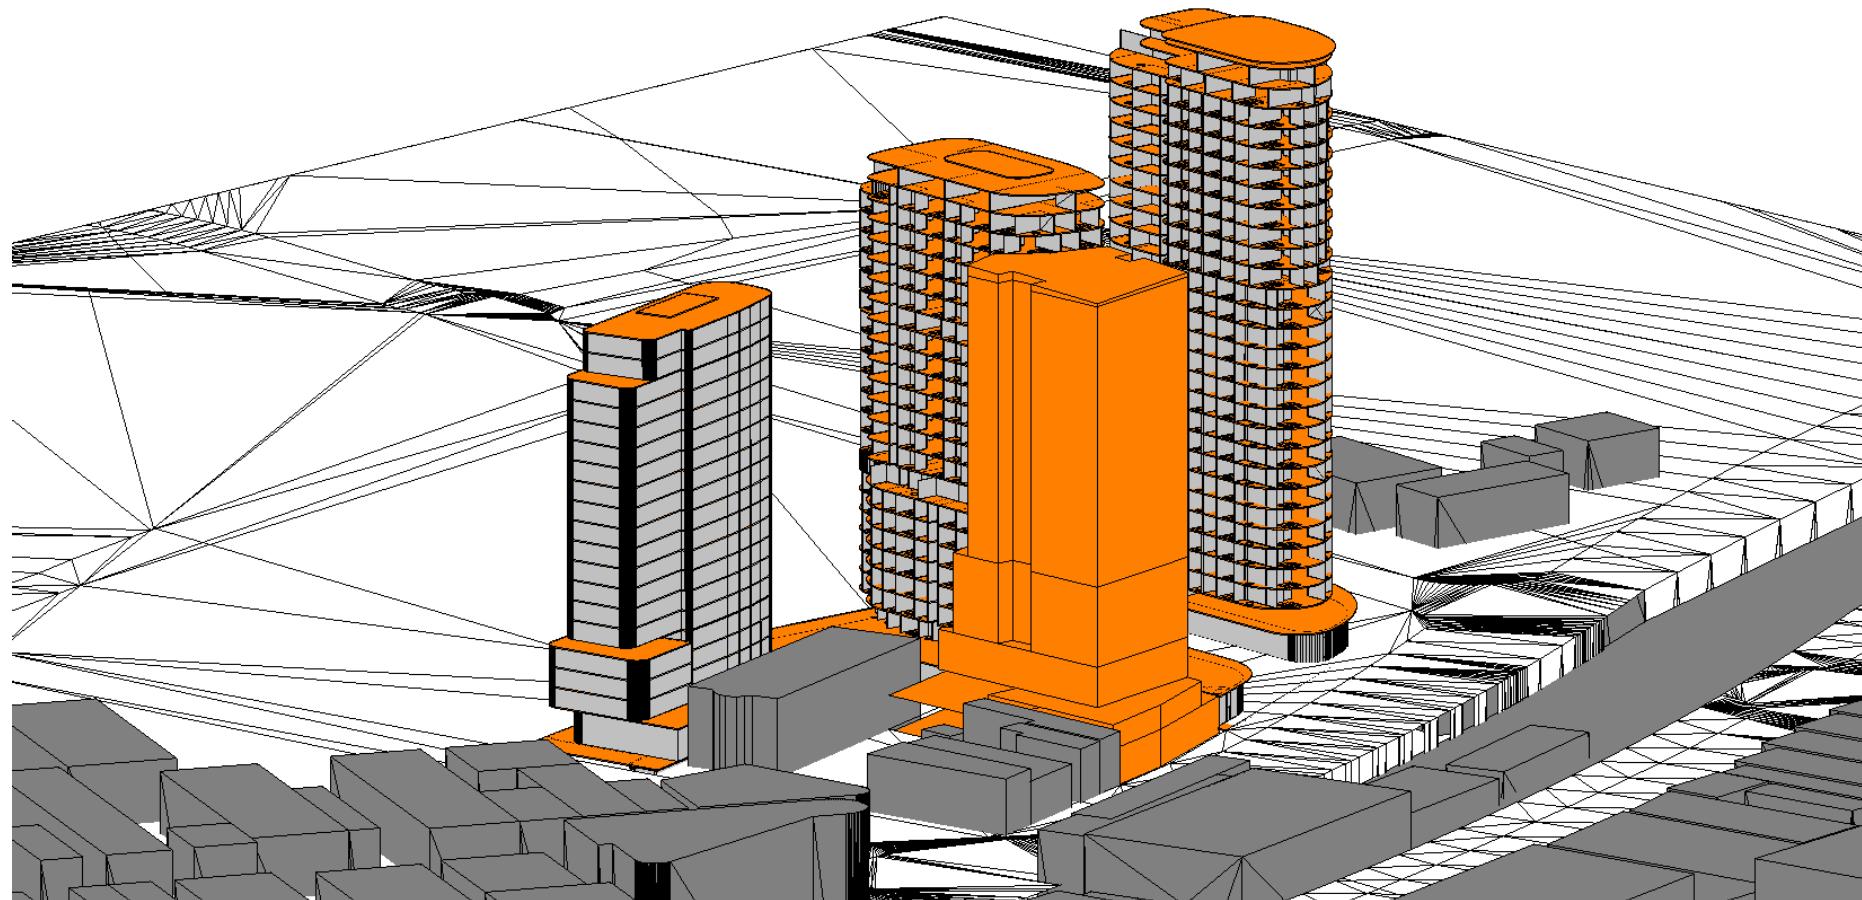


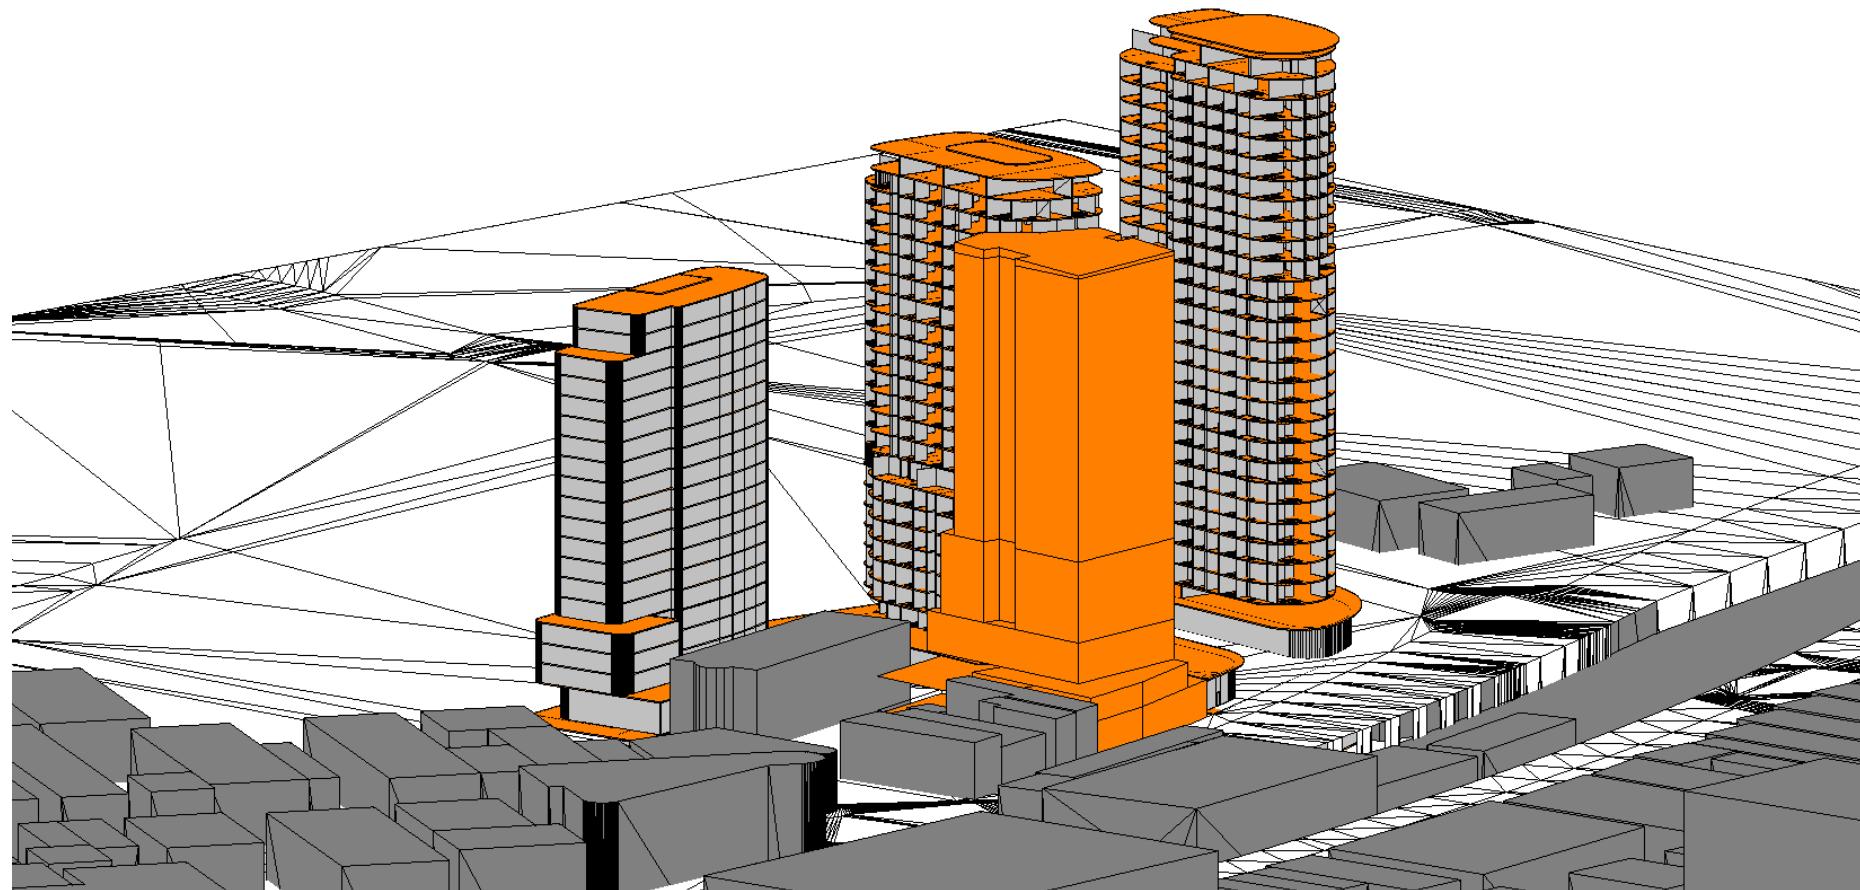
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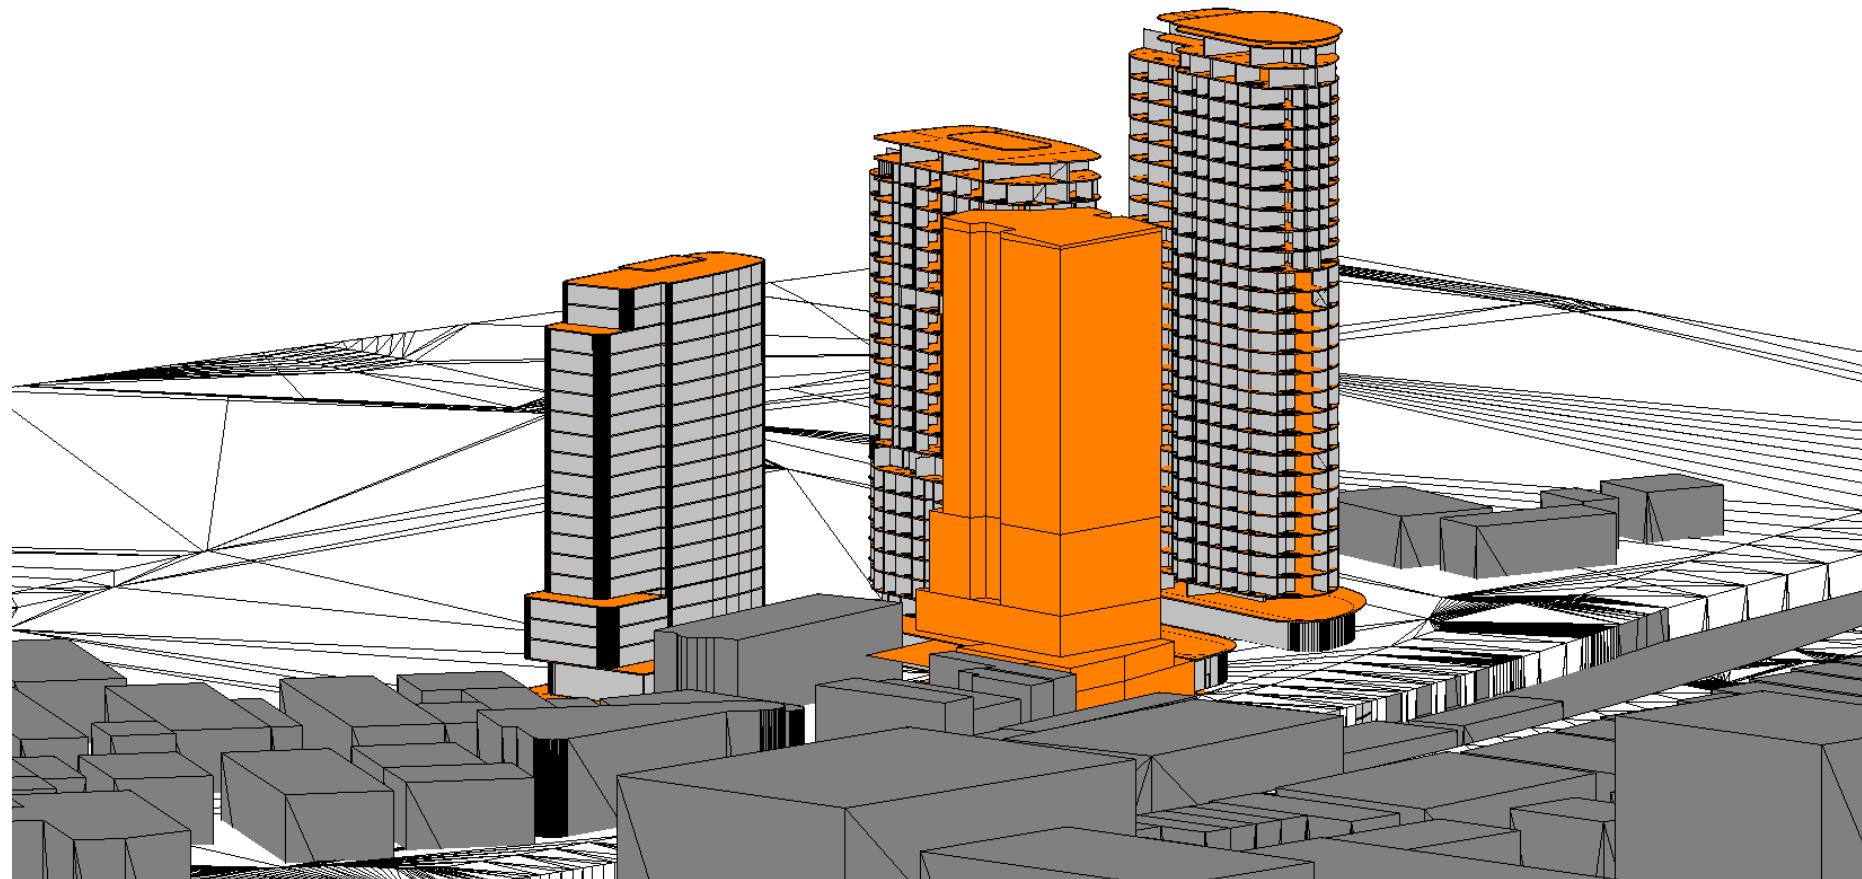


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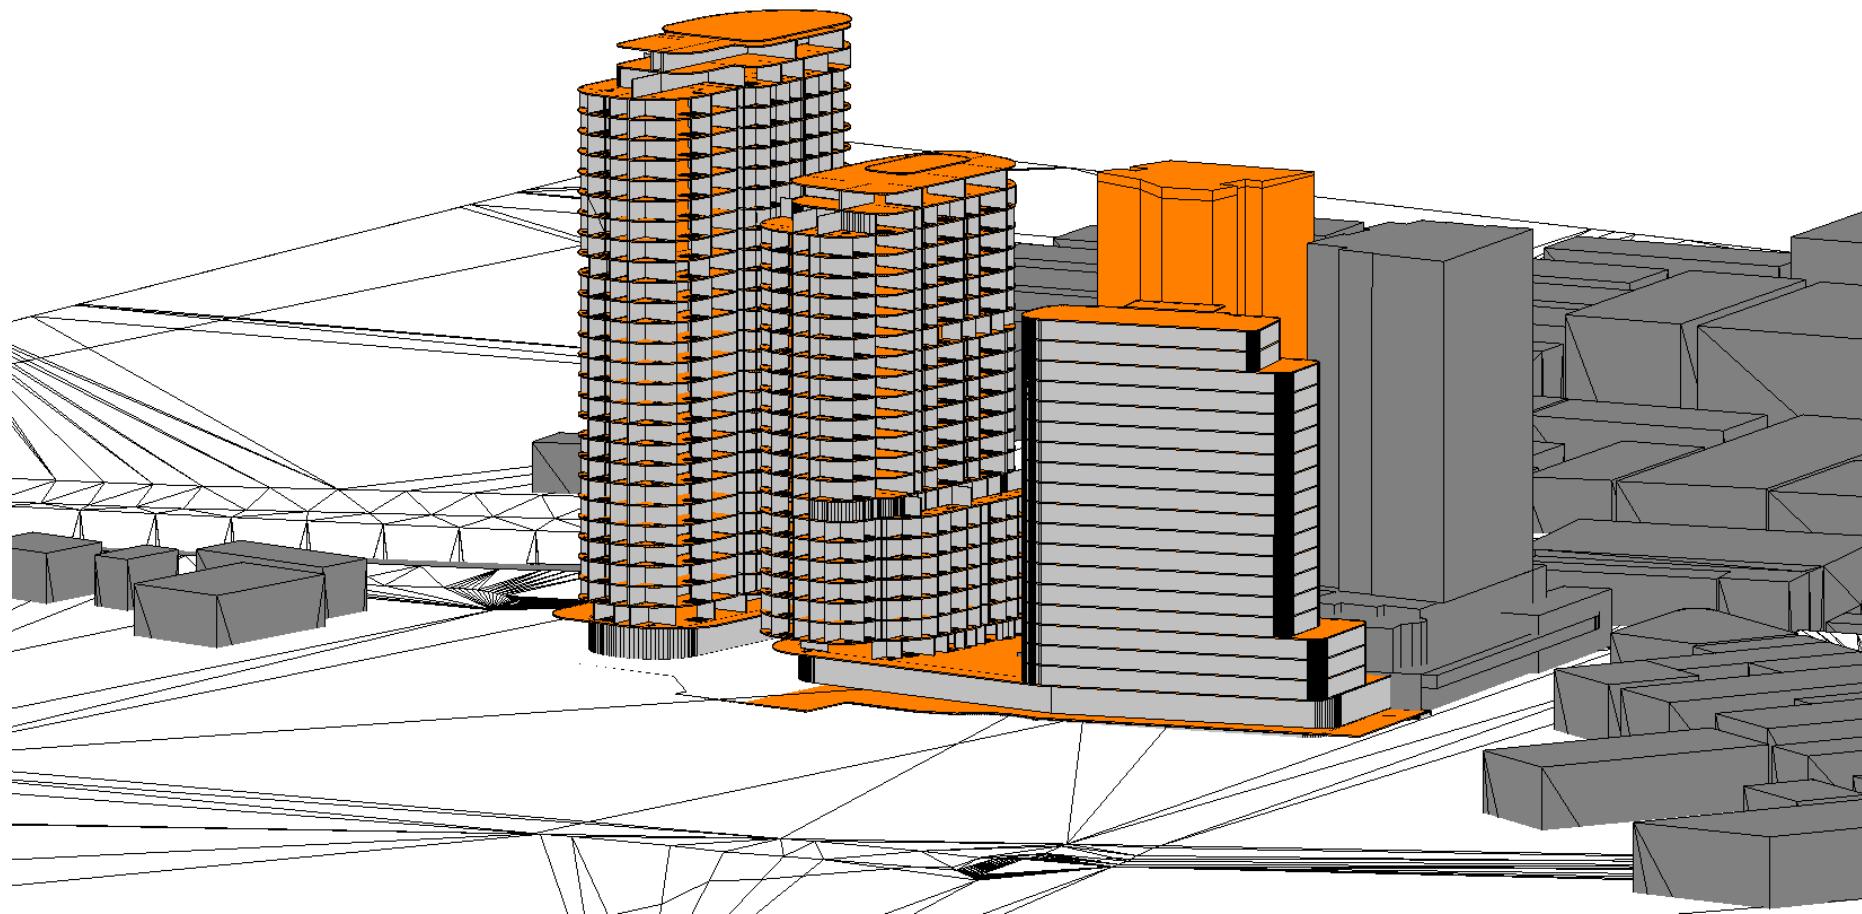
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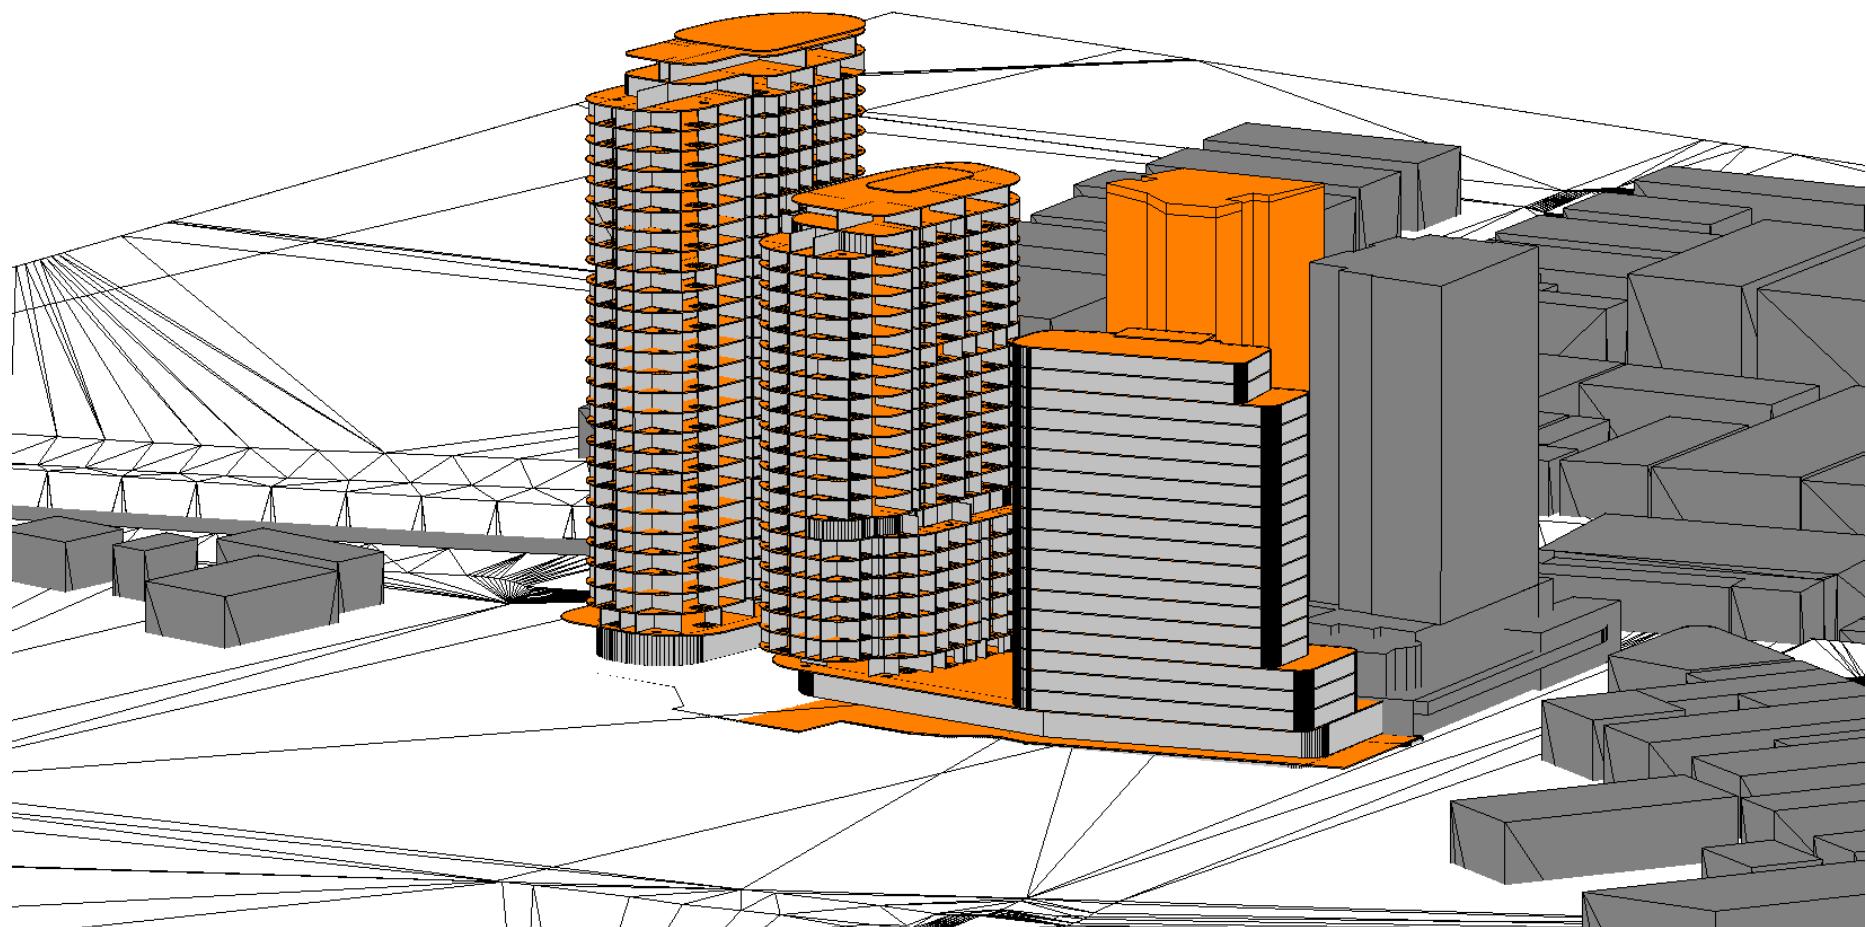
# APPENDIX E

Sun Eye Views ADG Massing + Future Northern Development

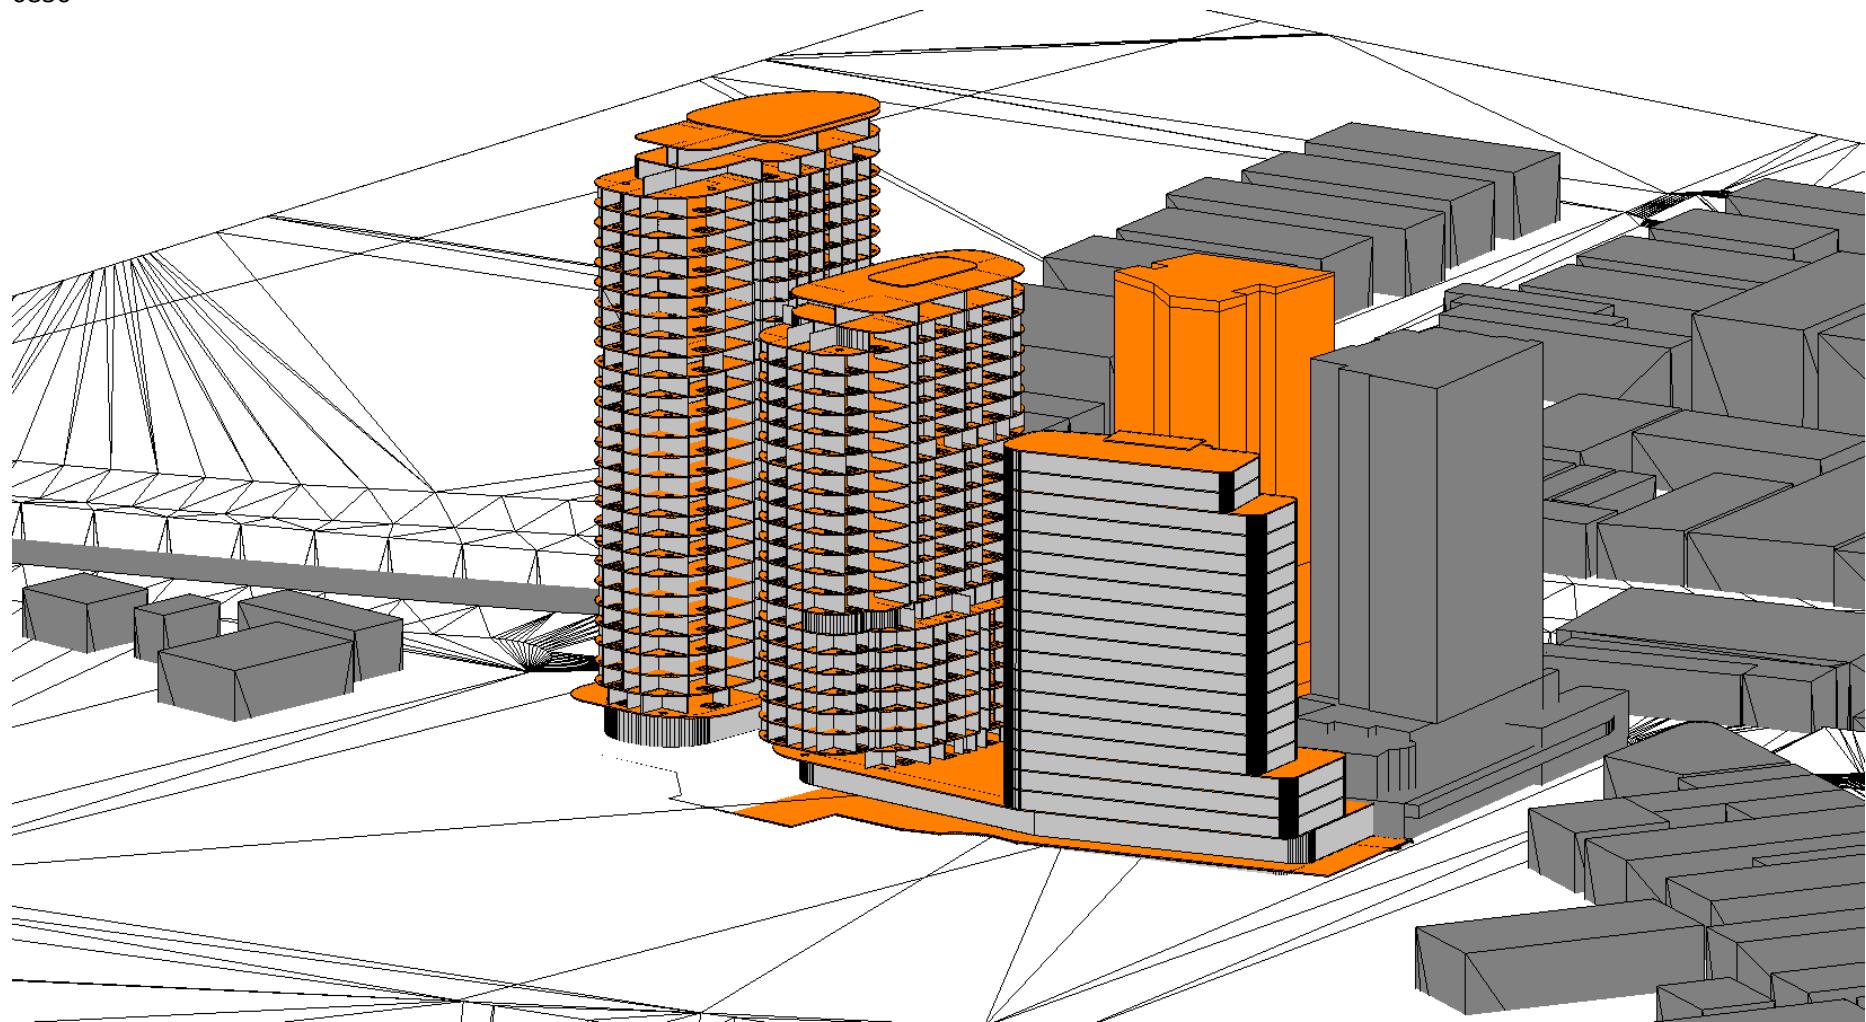
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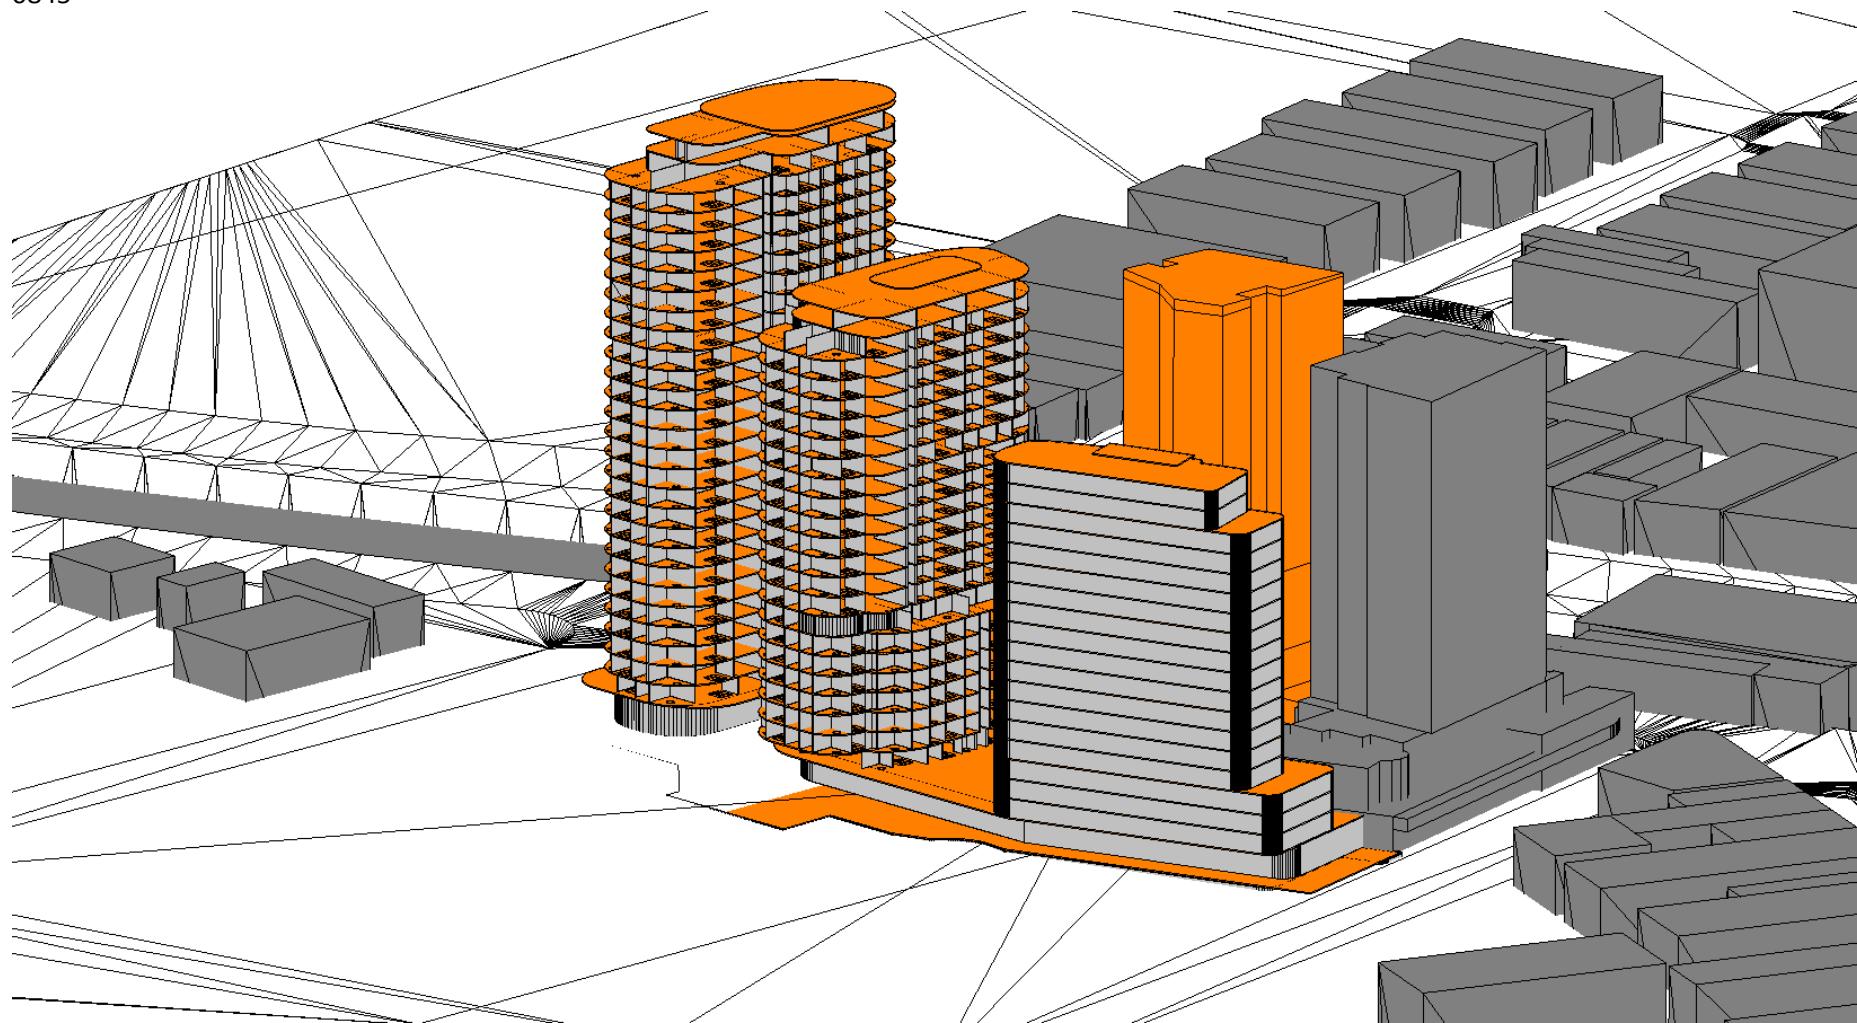
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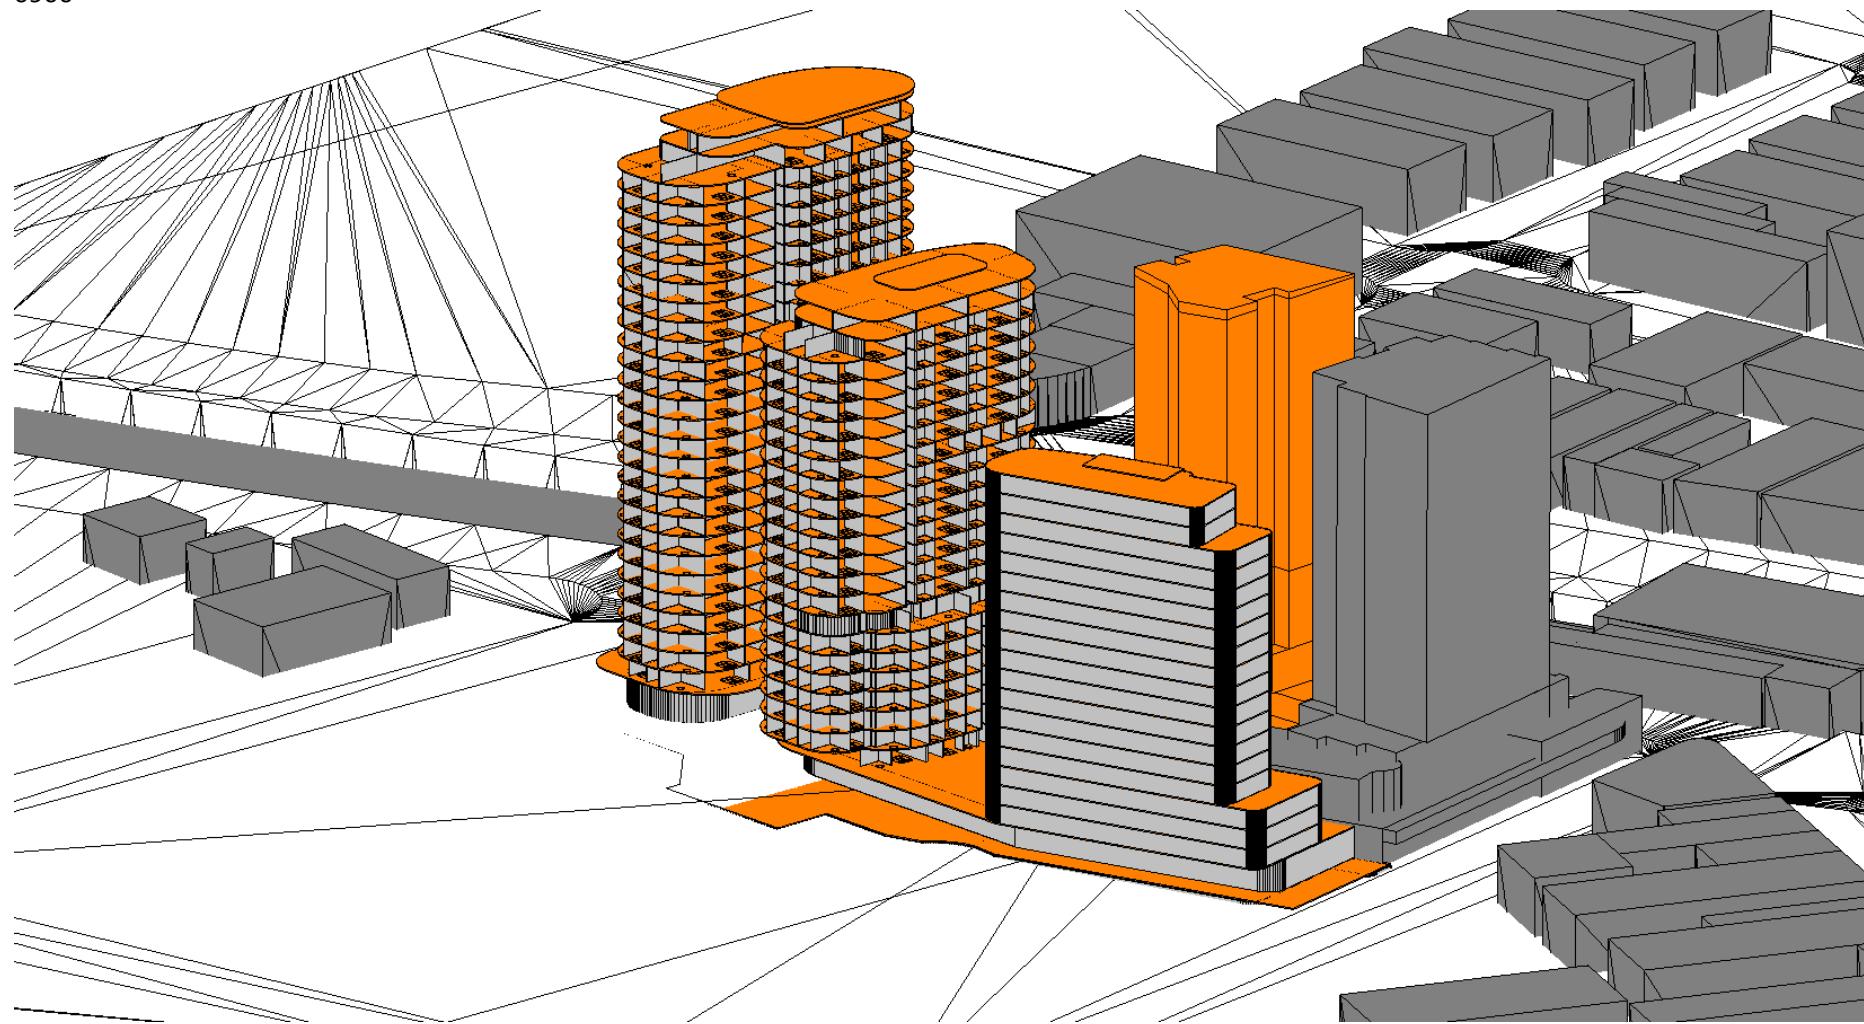
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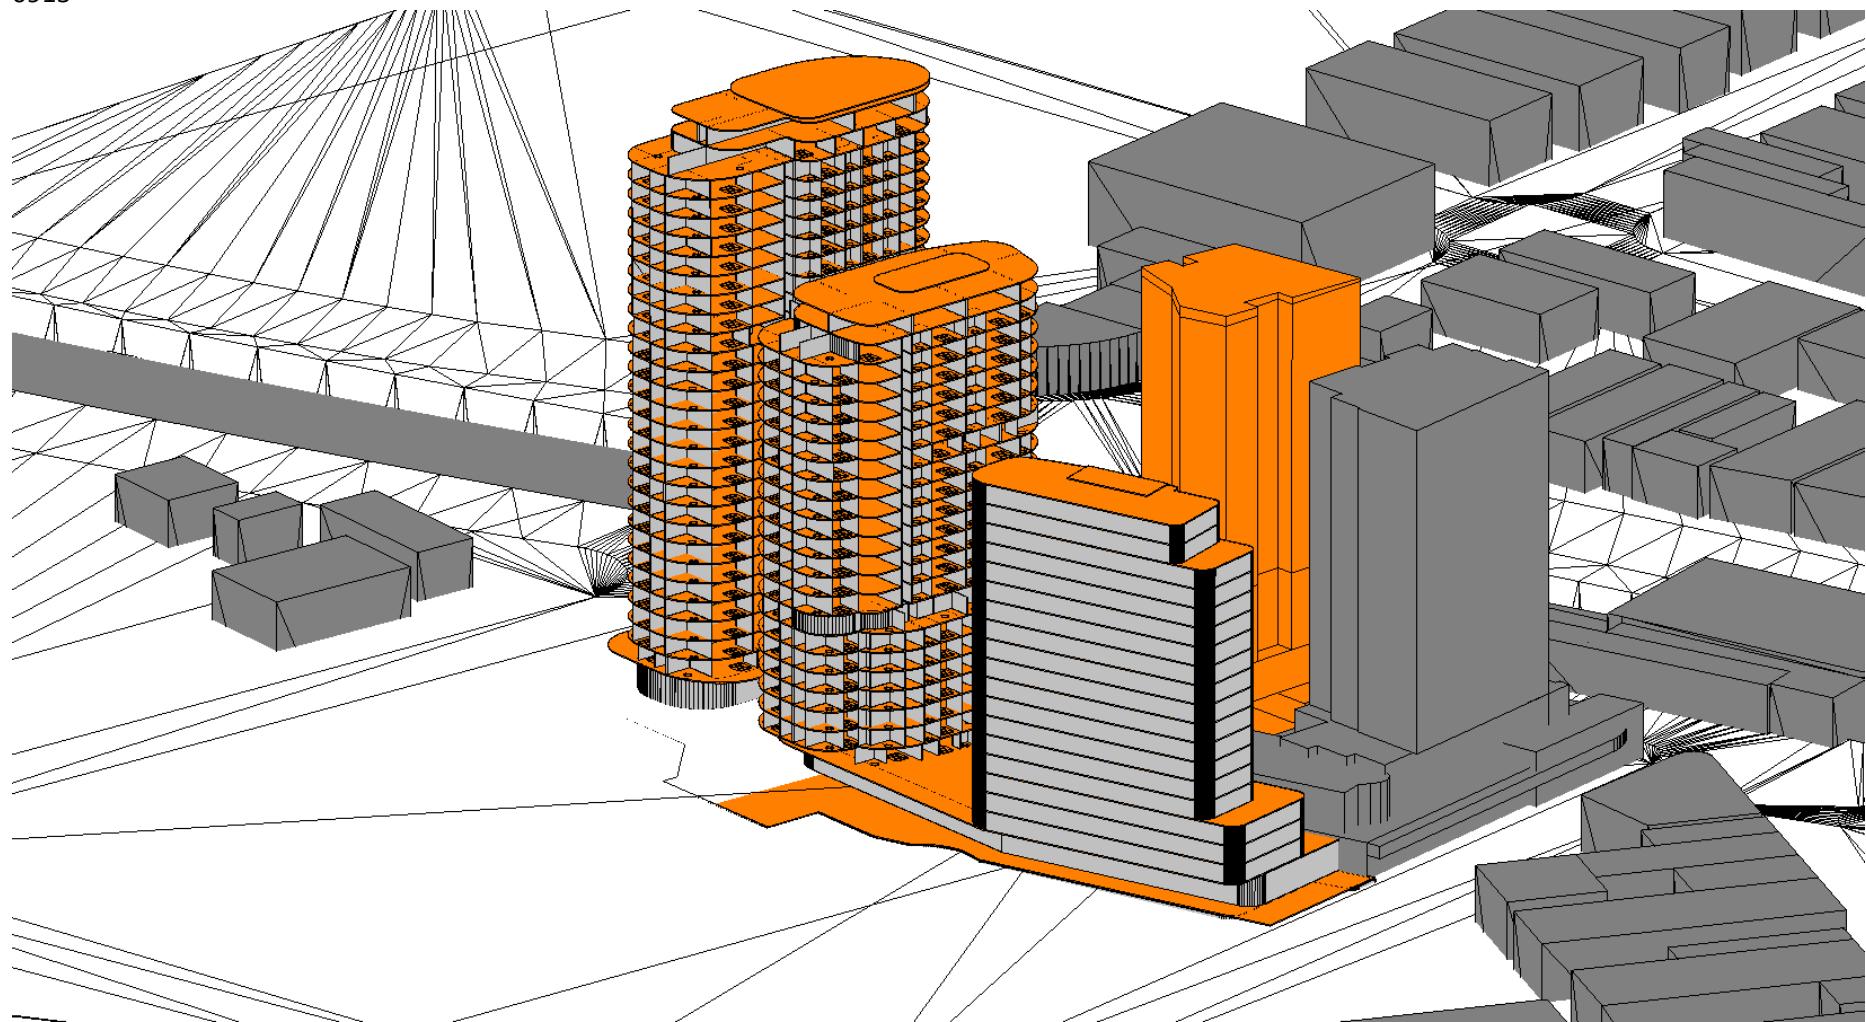
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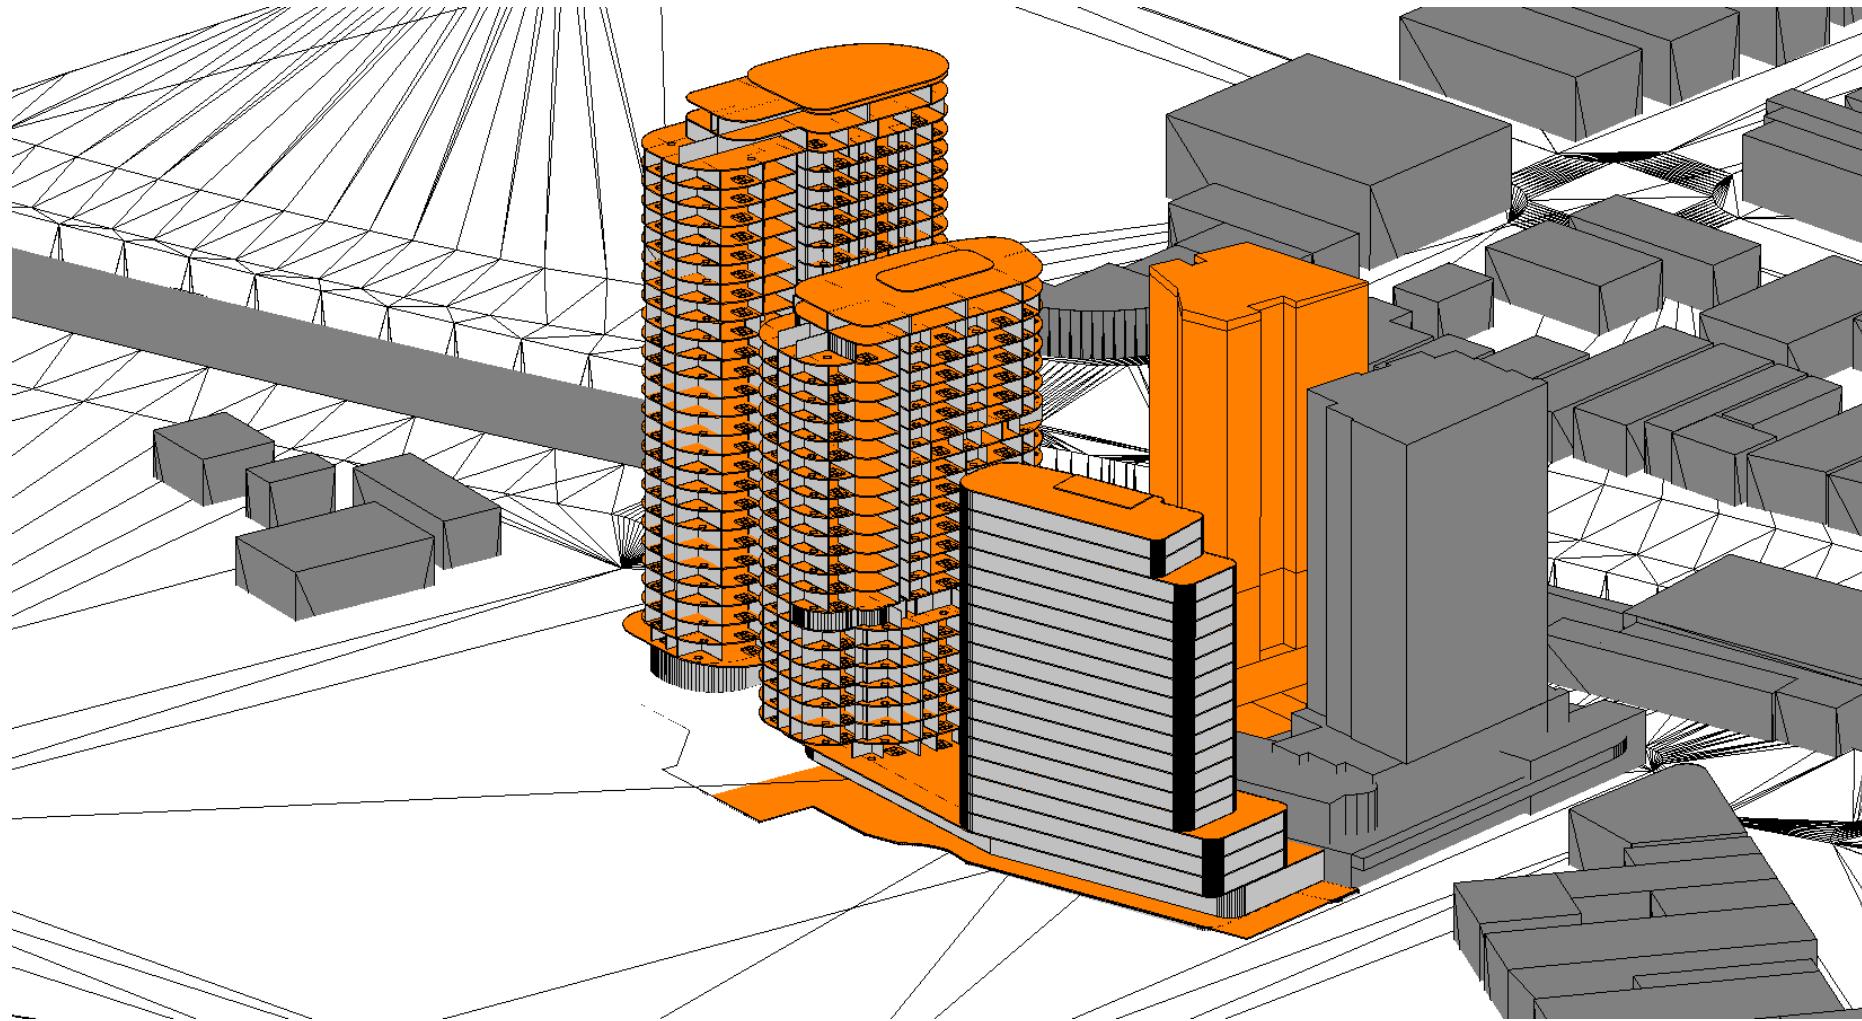
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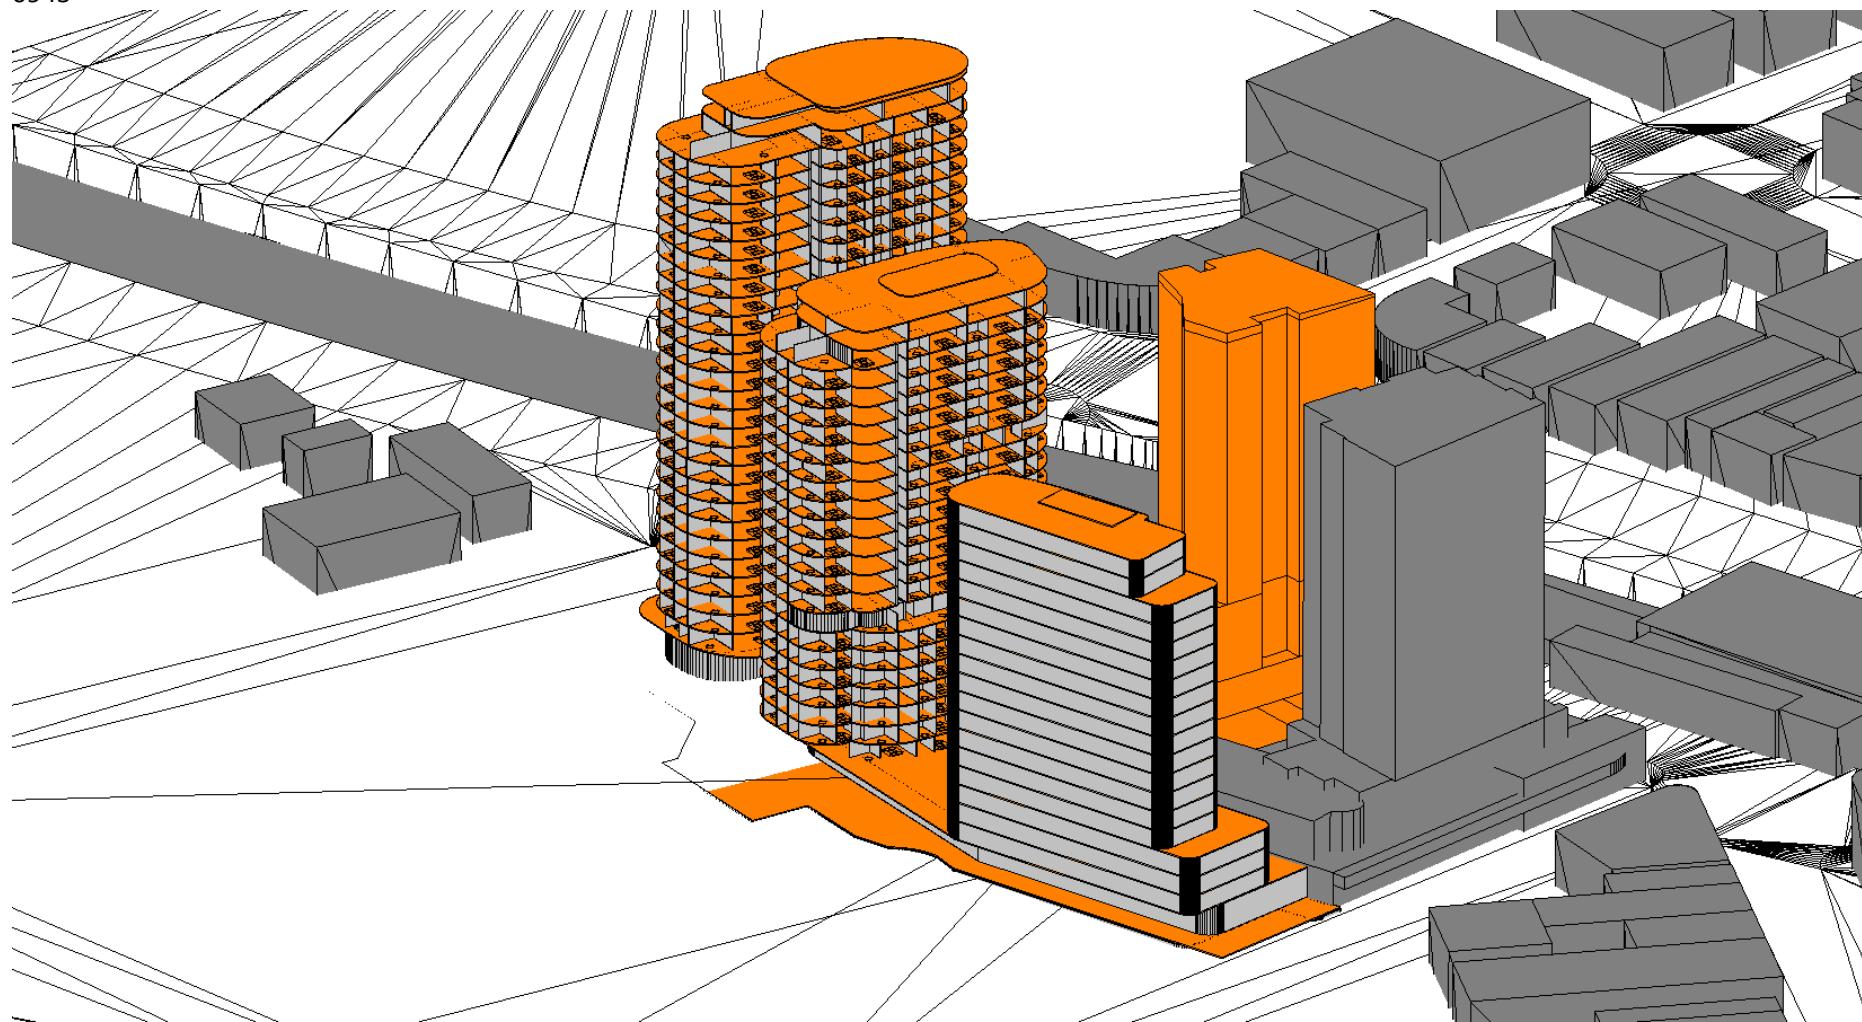
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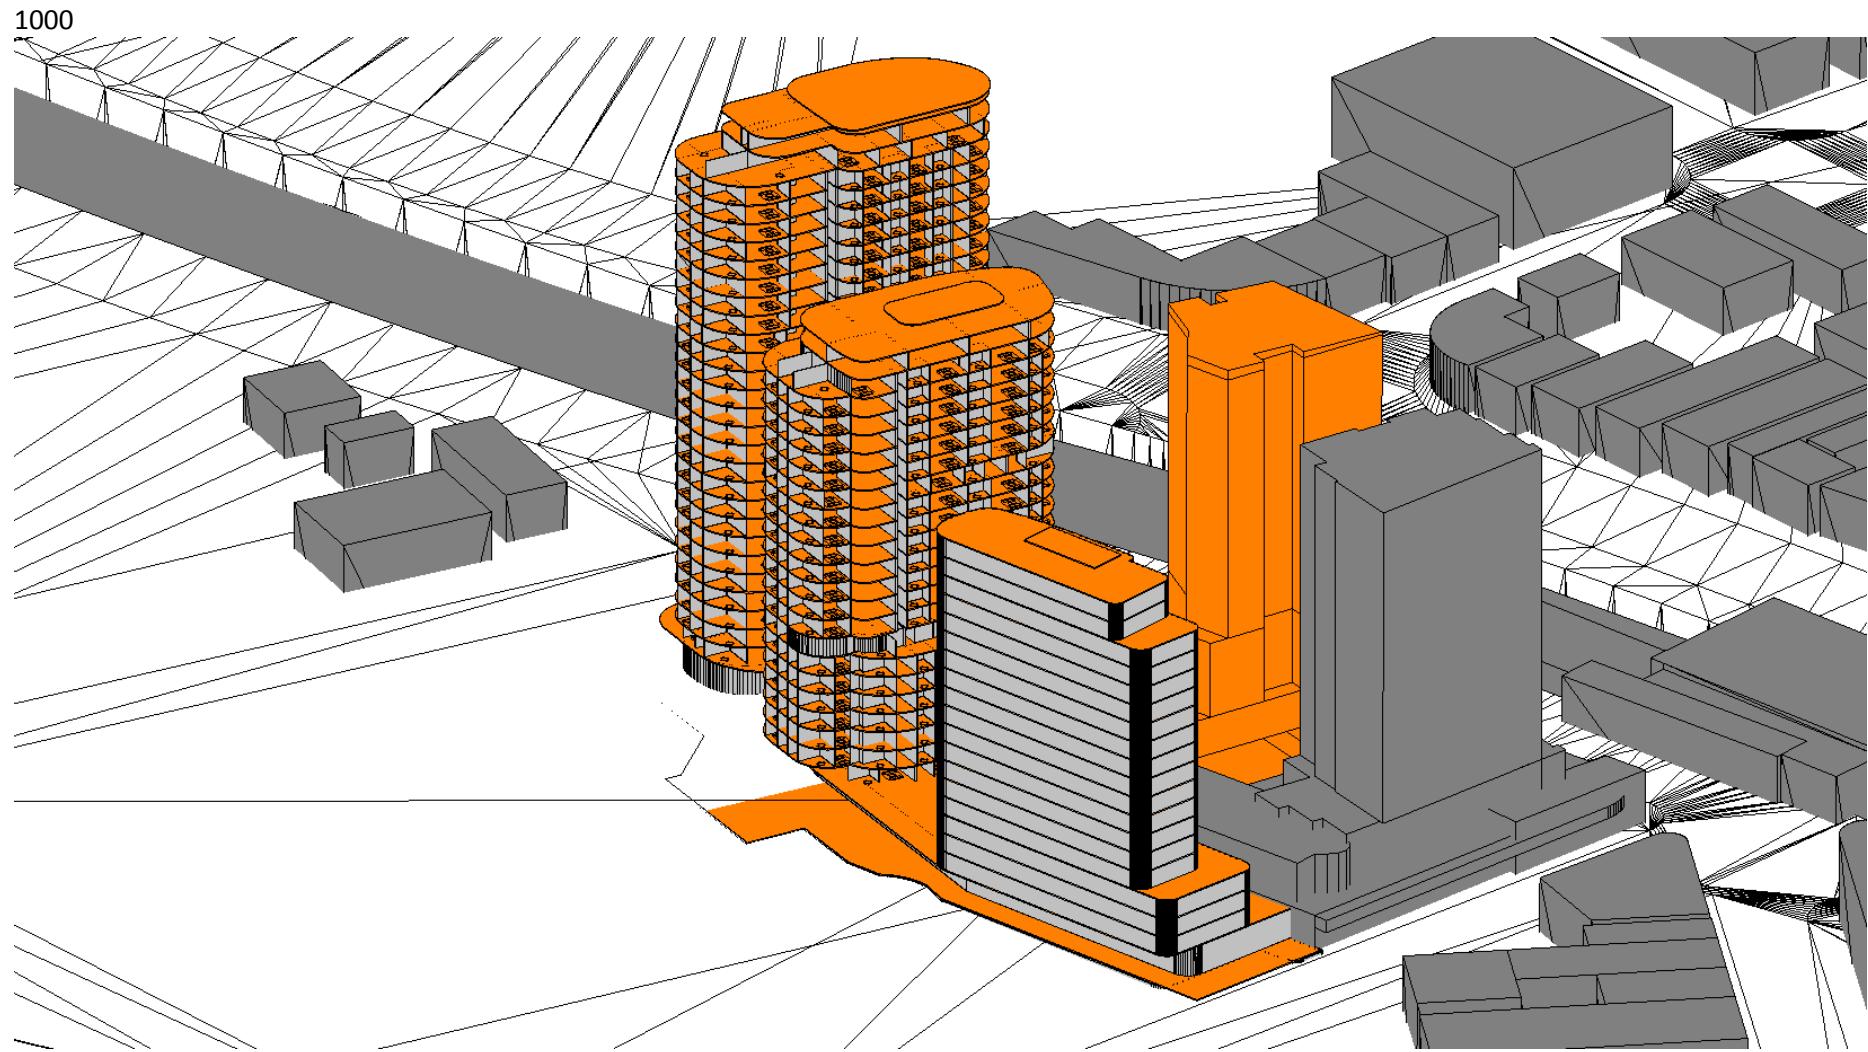


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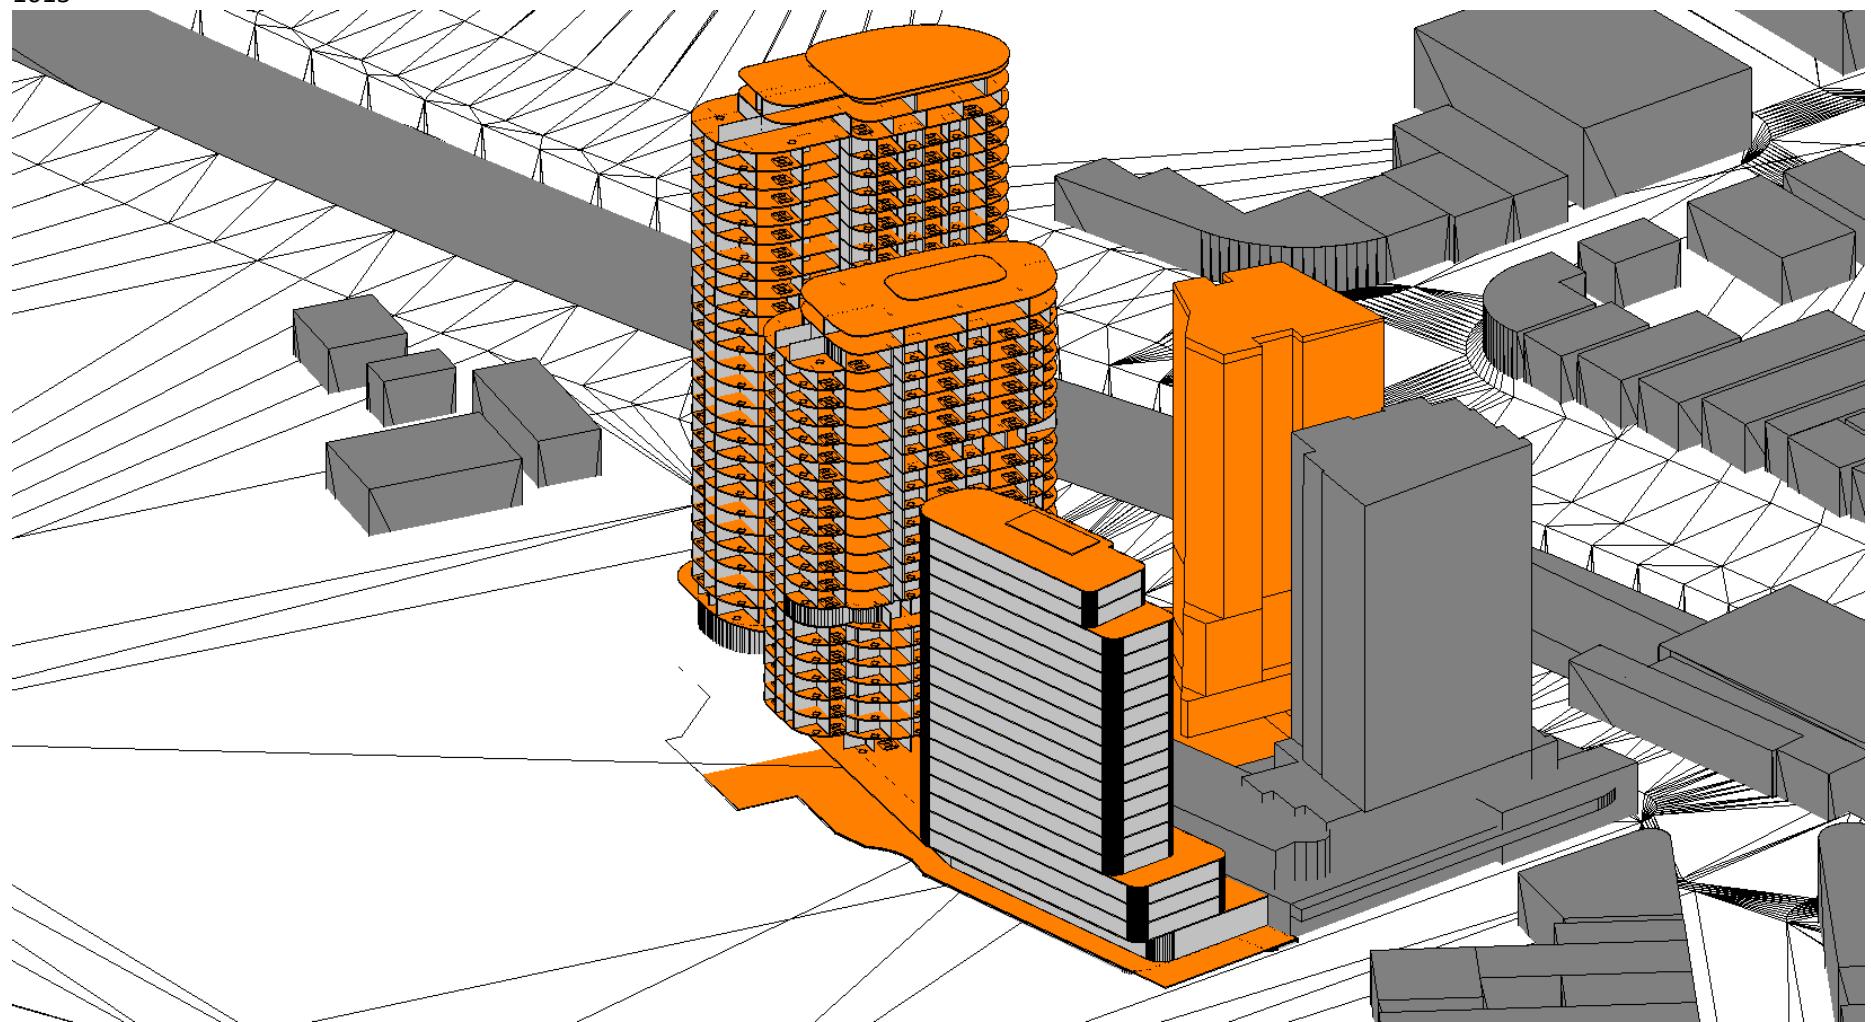


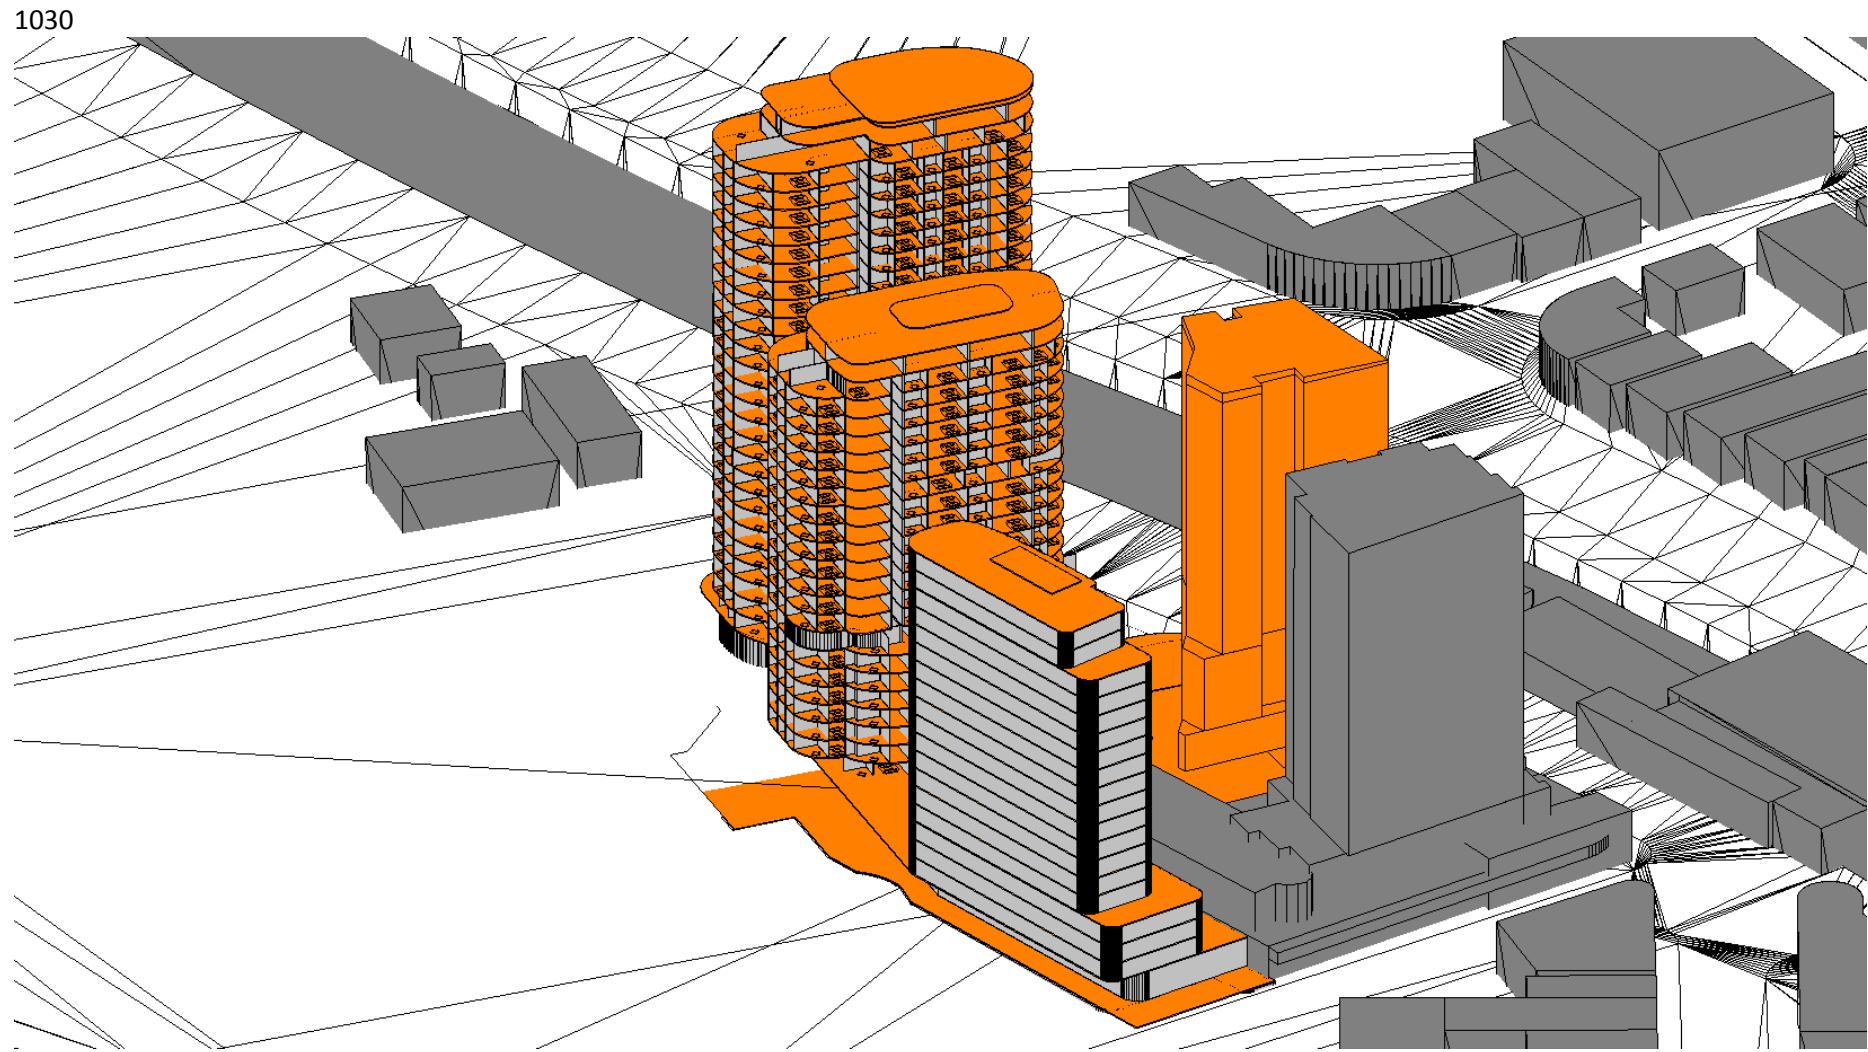
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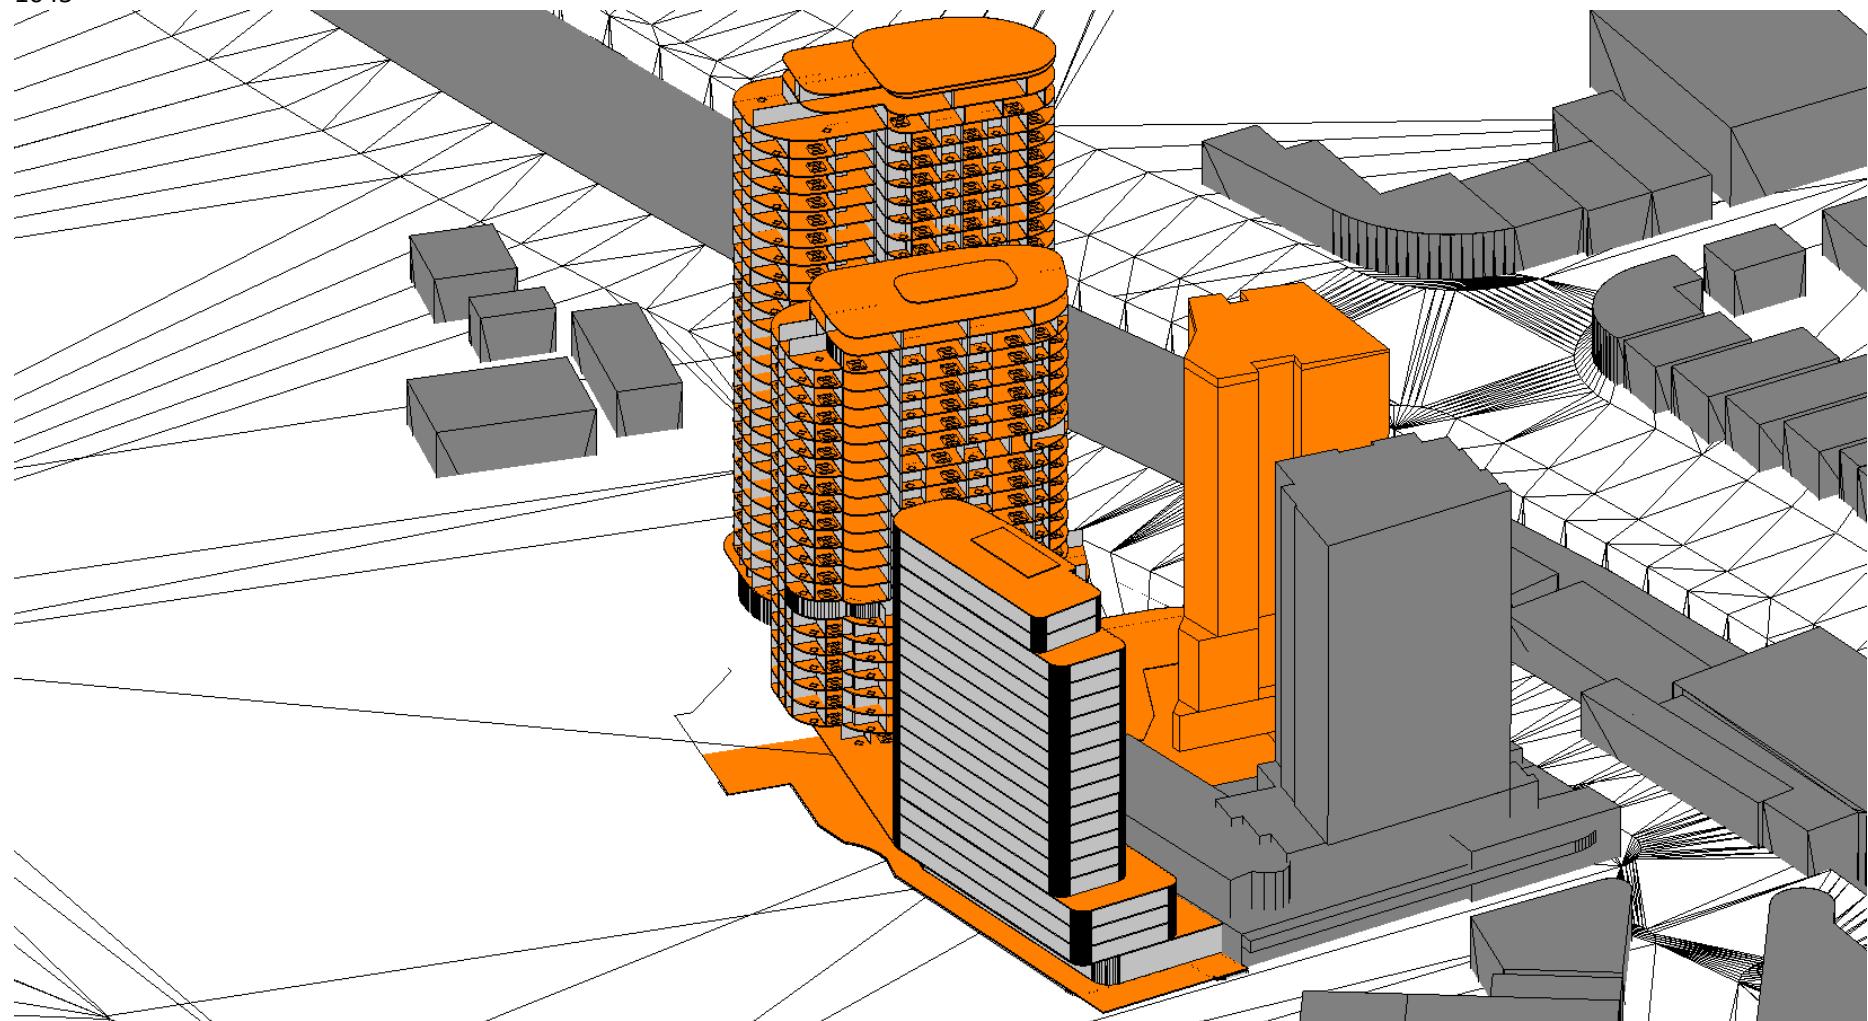


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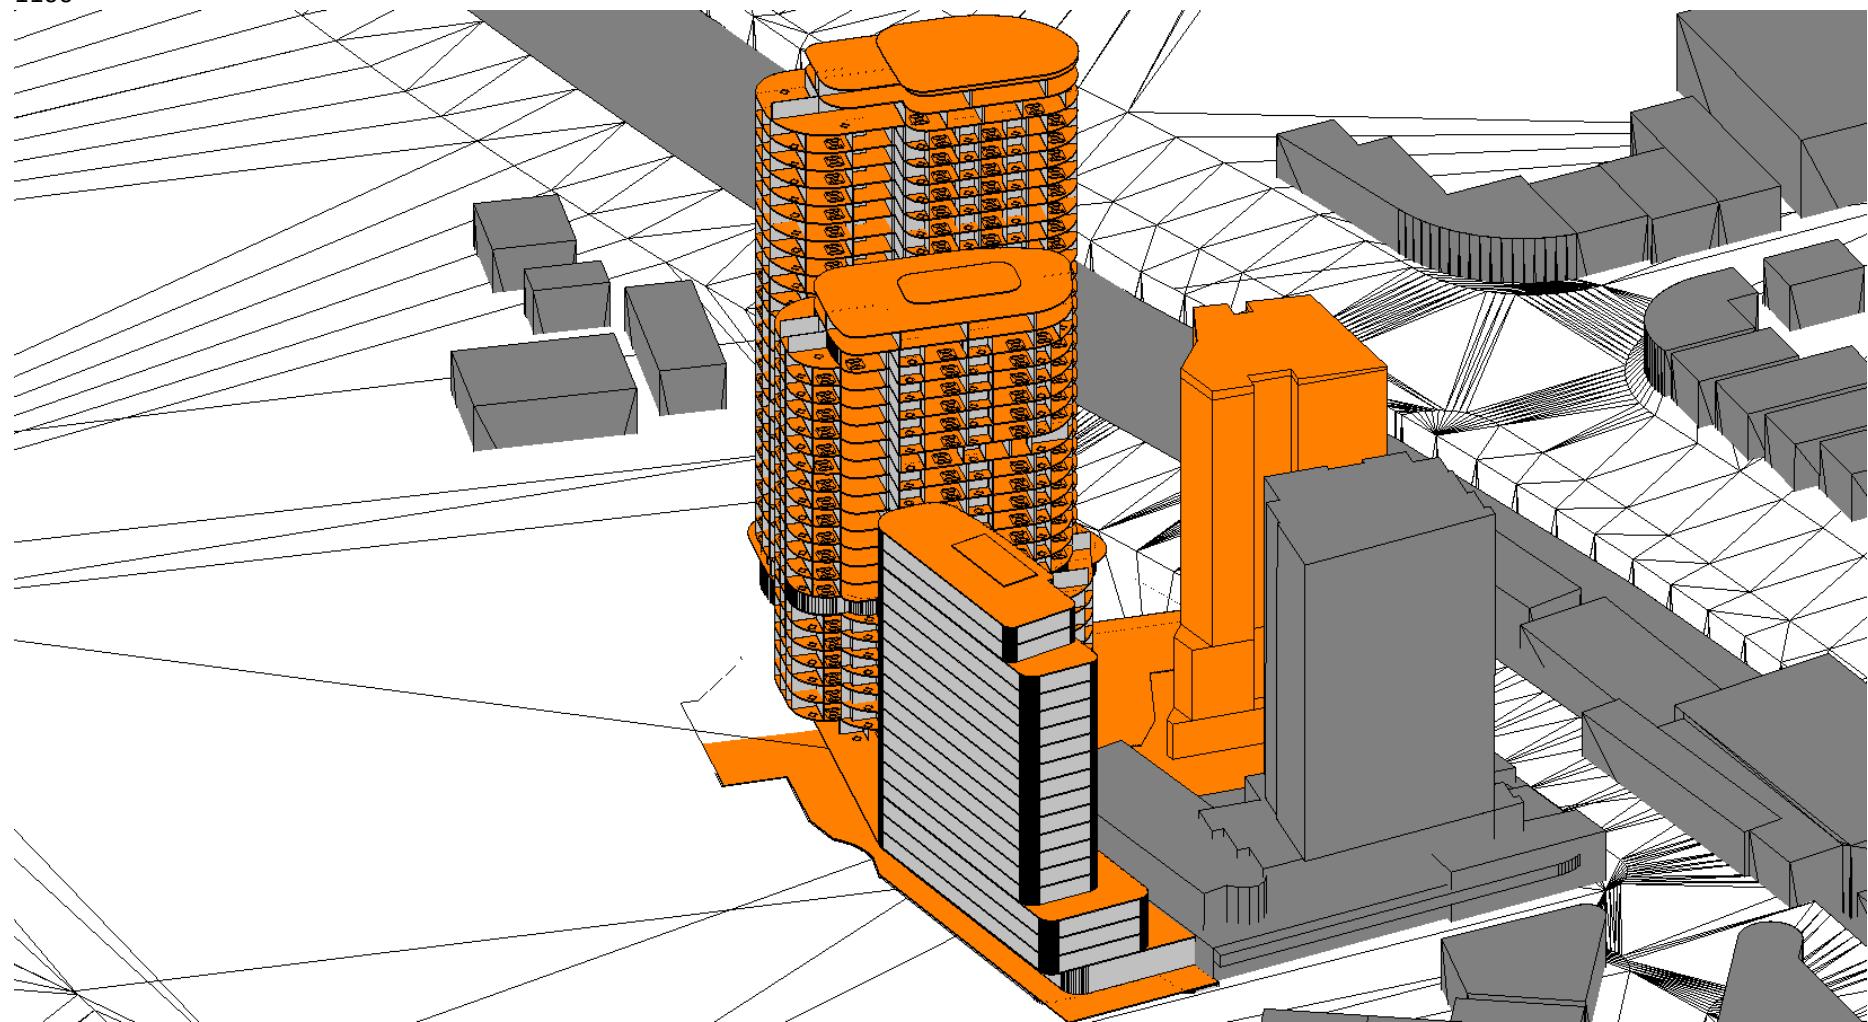




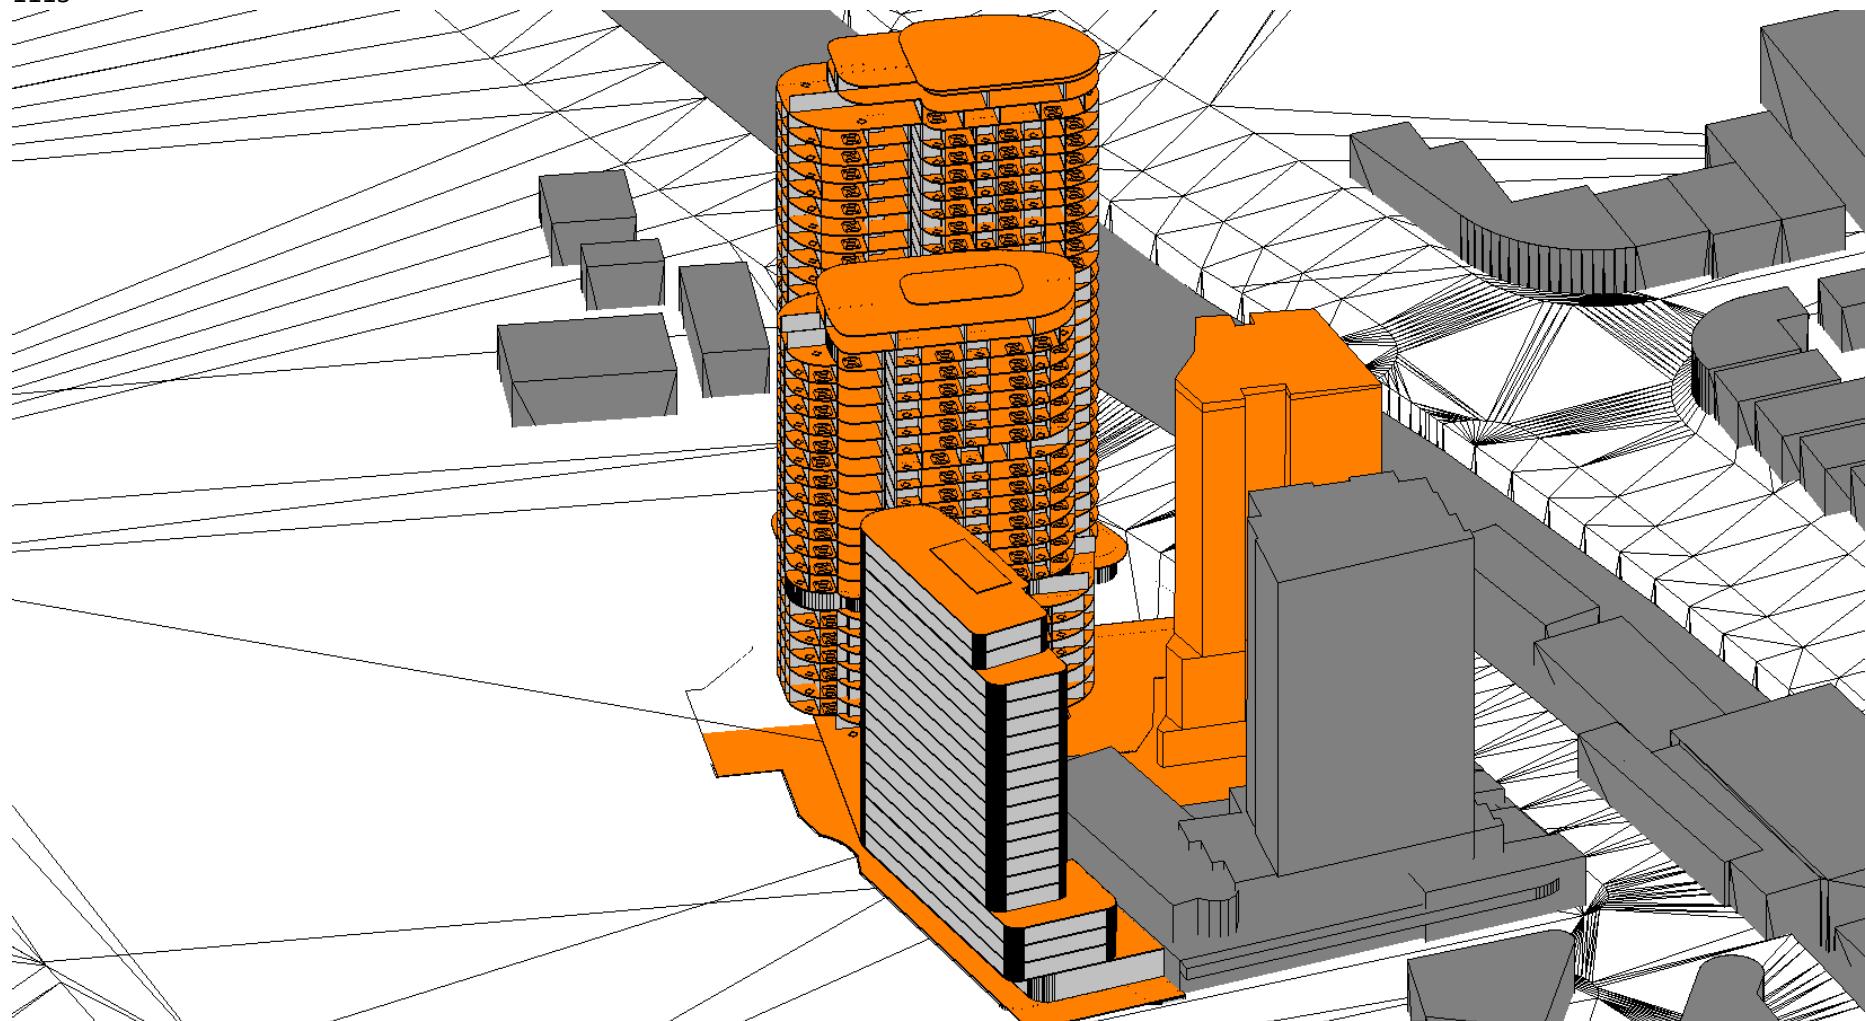
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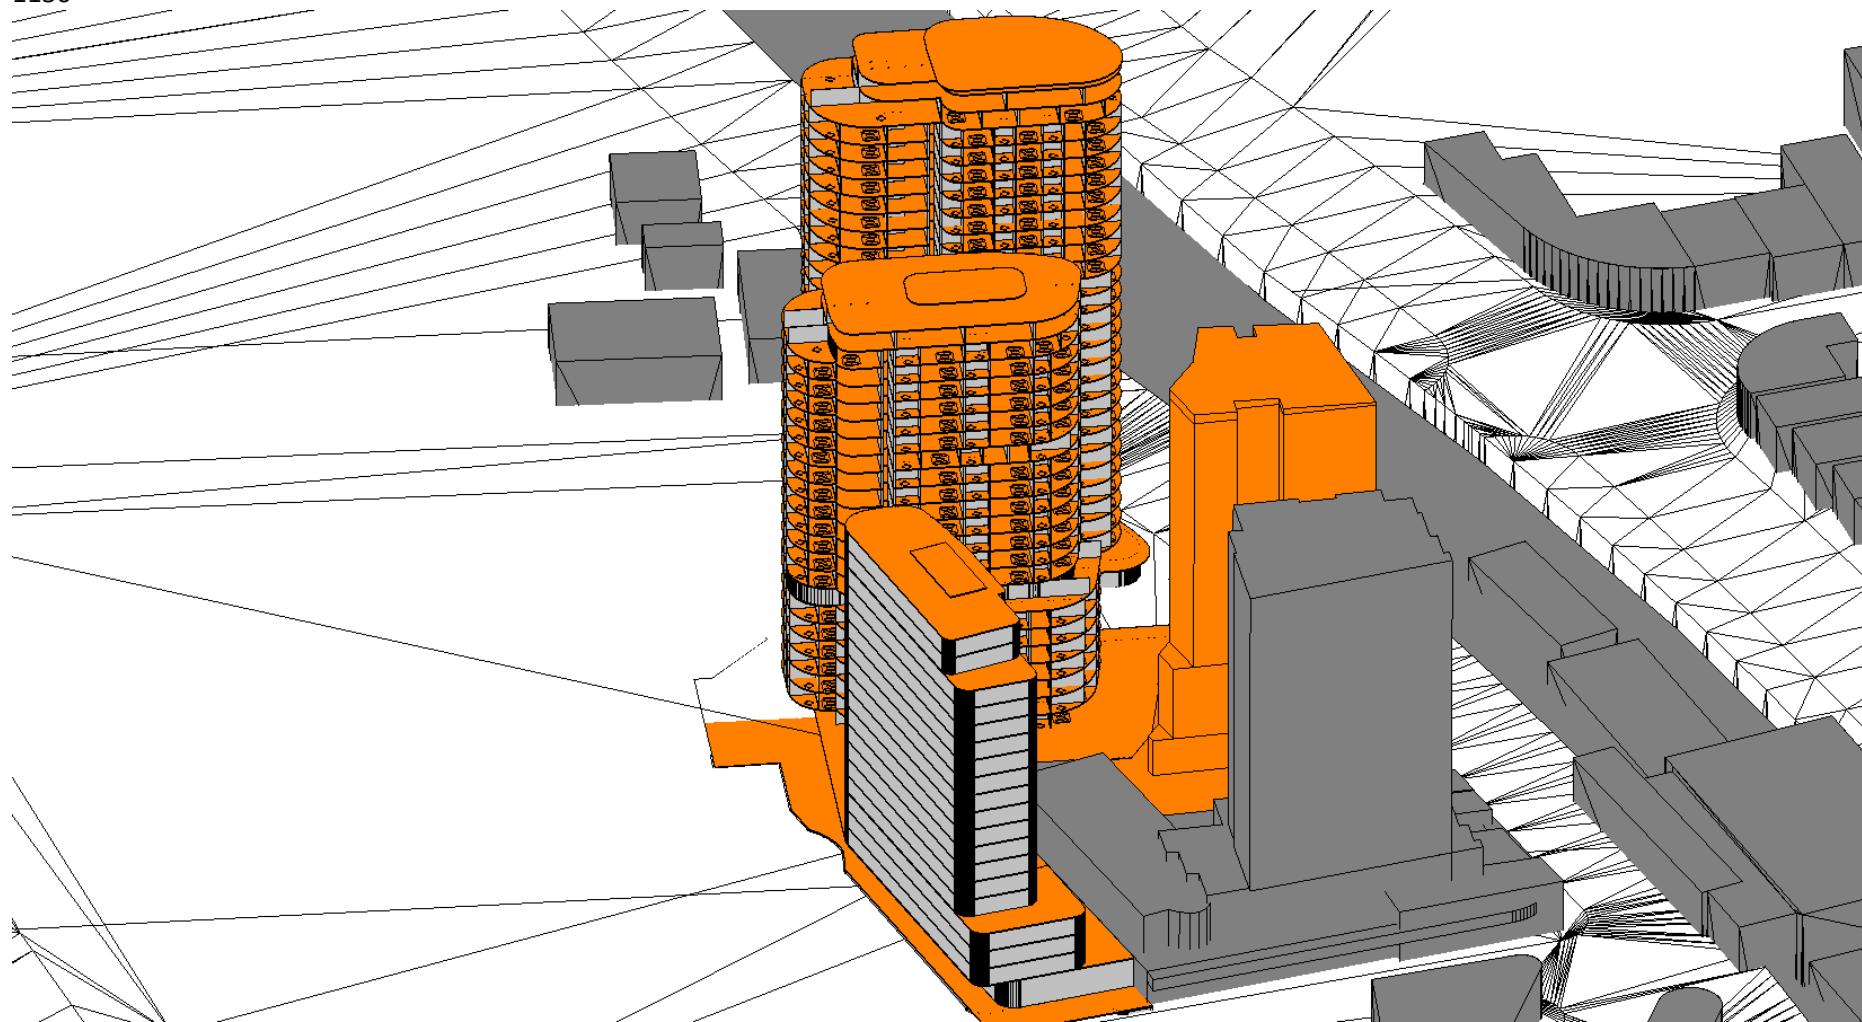
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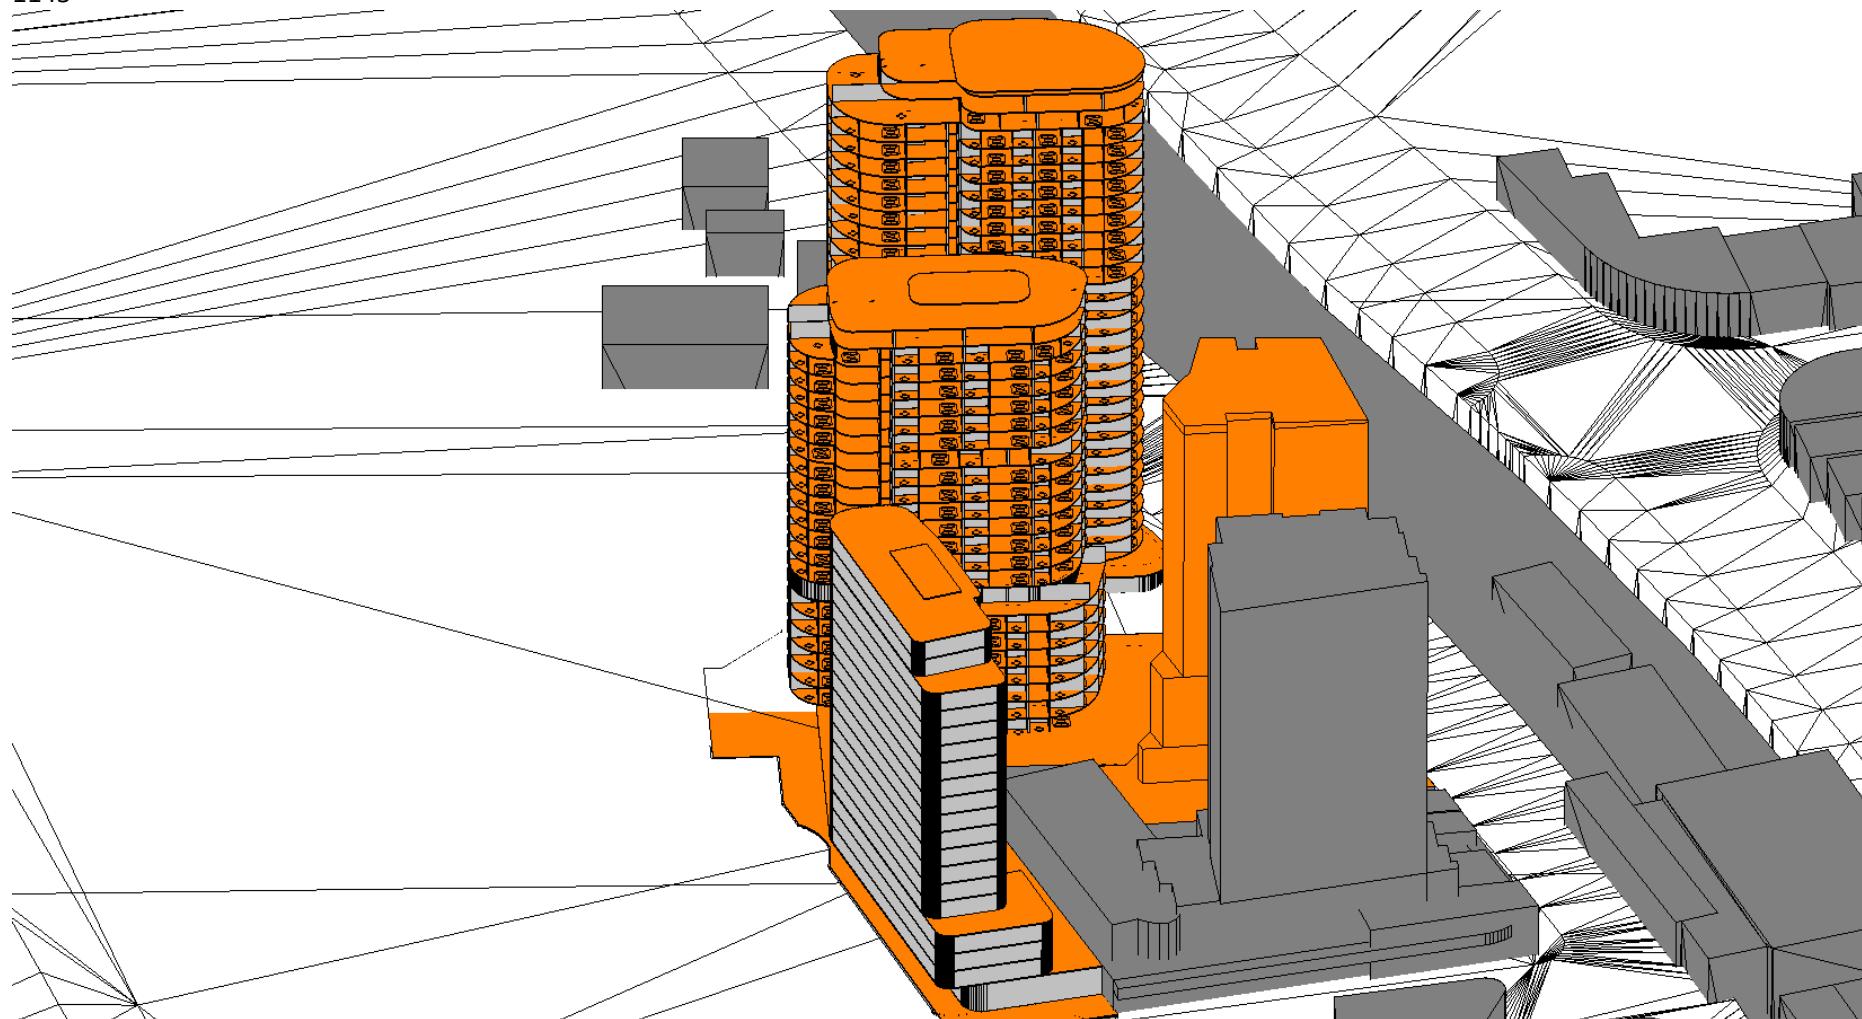
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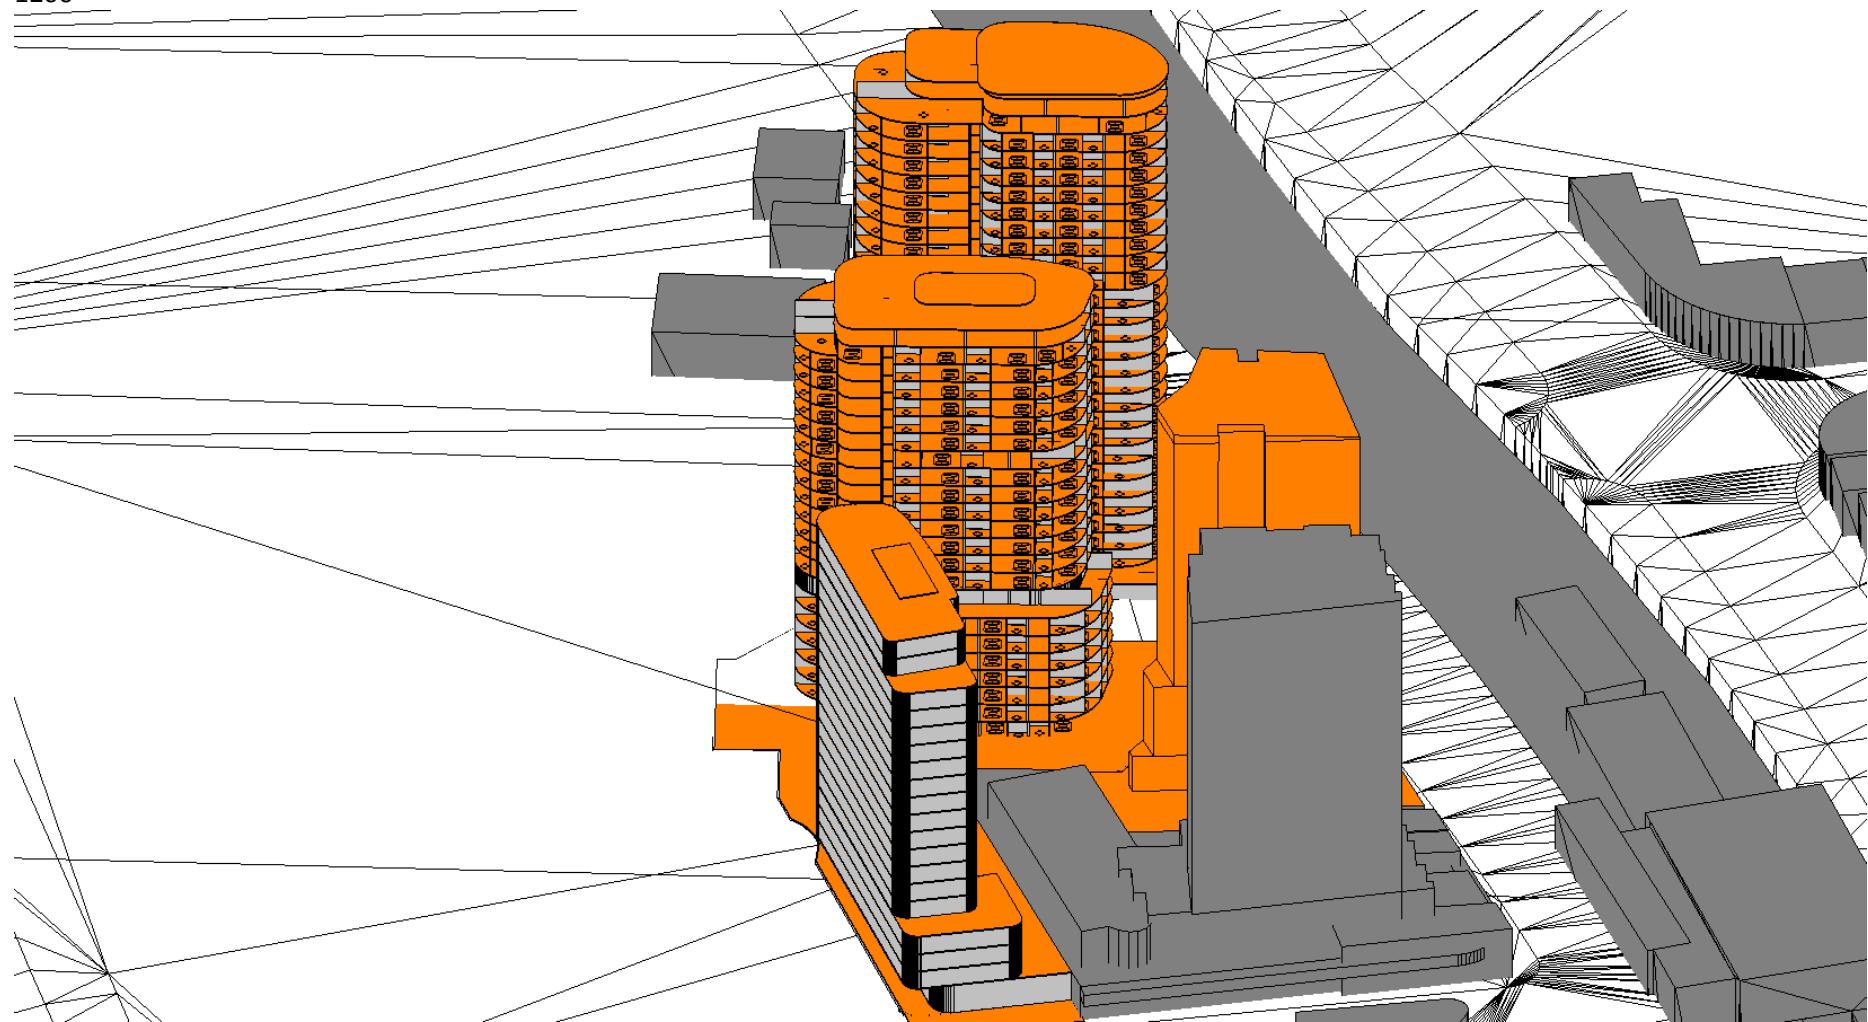
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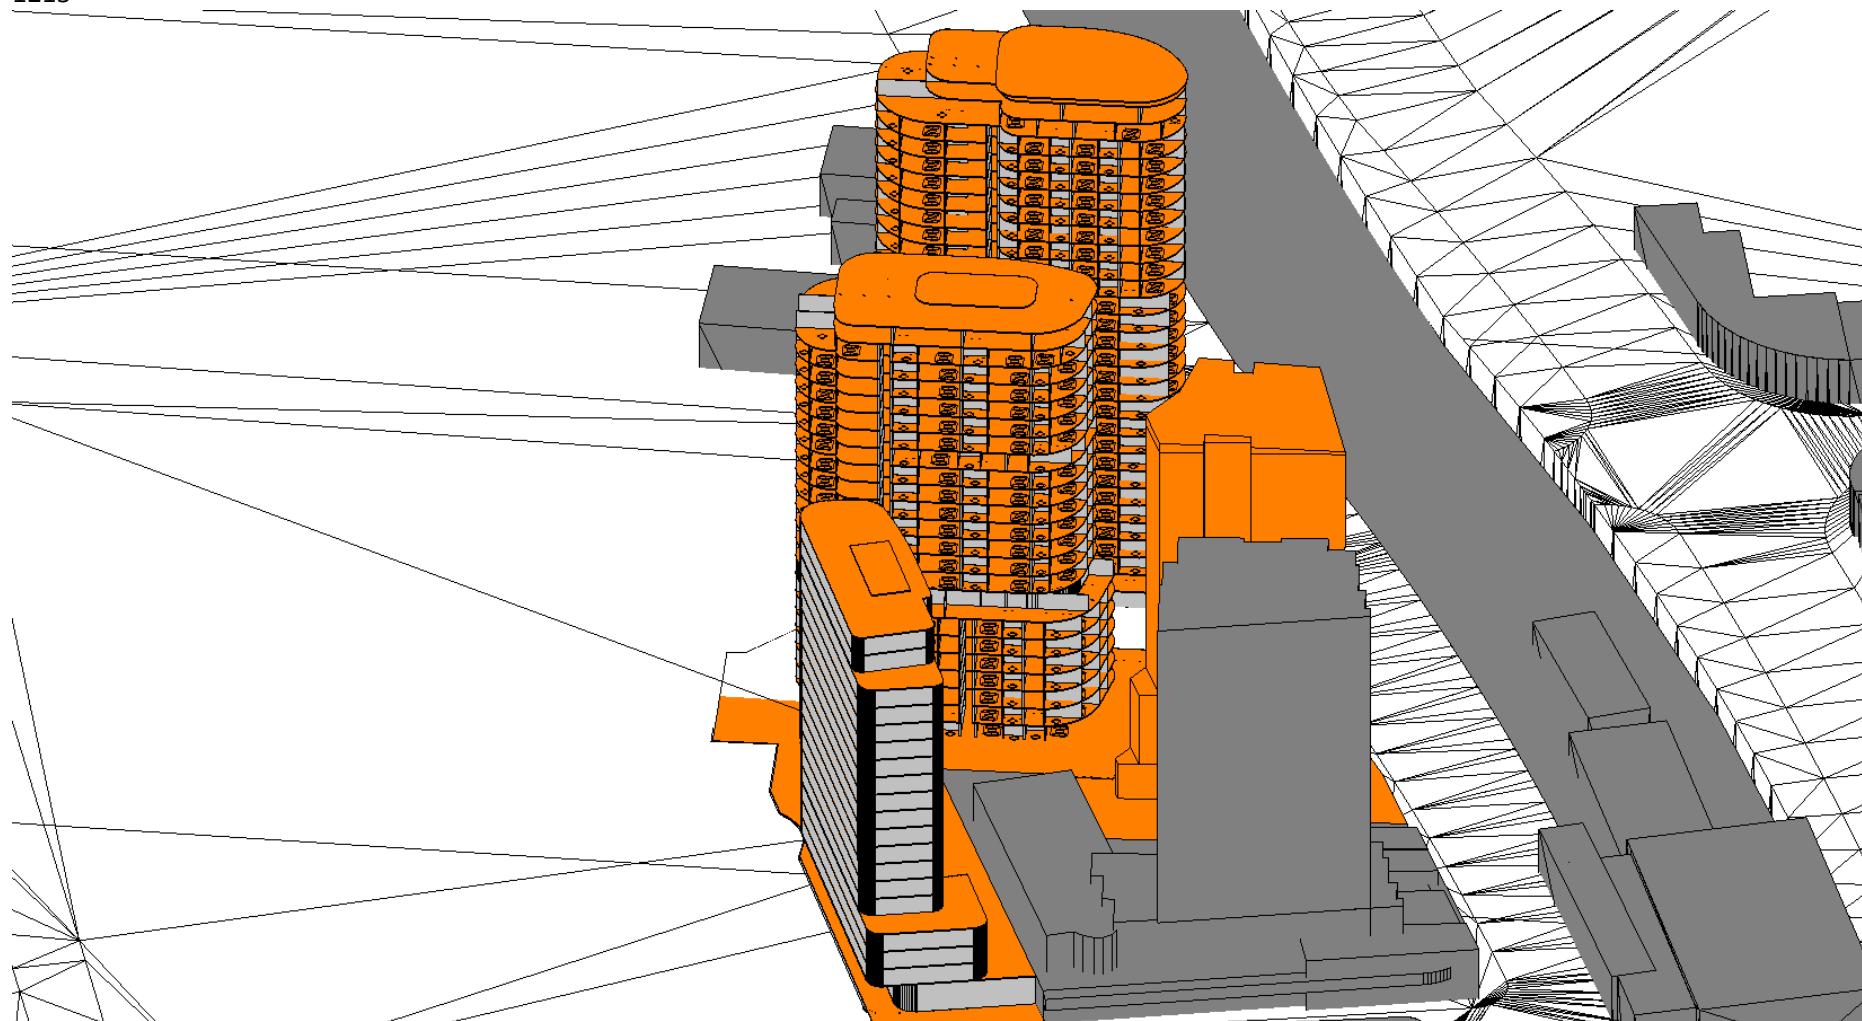
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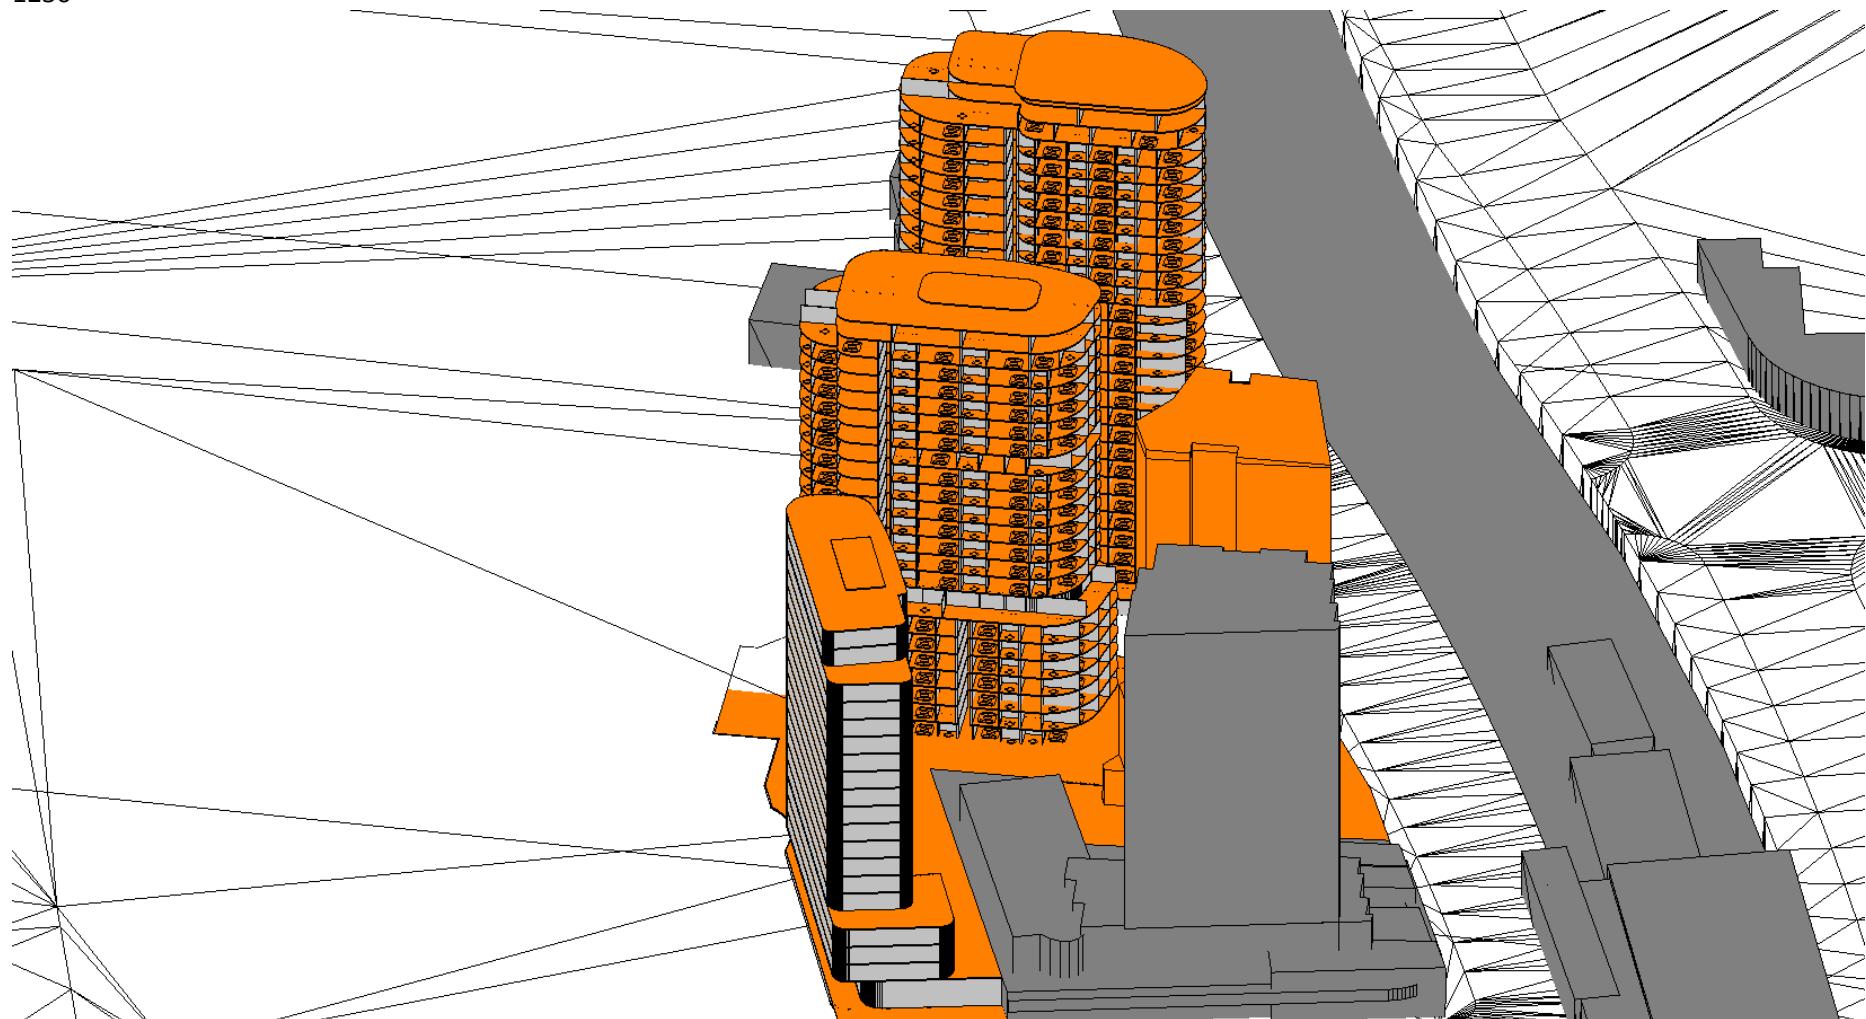
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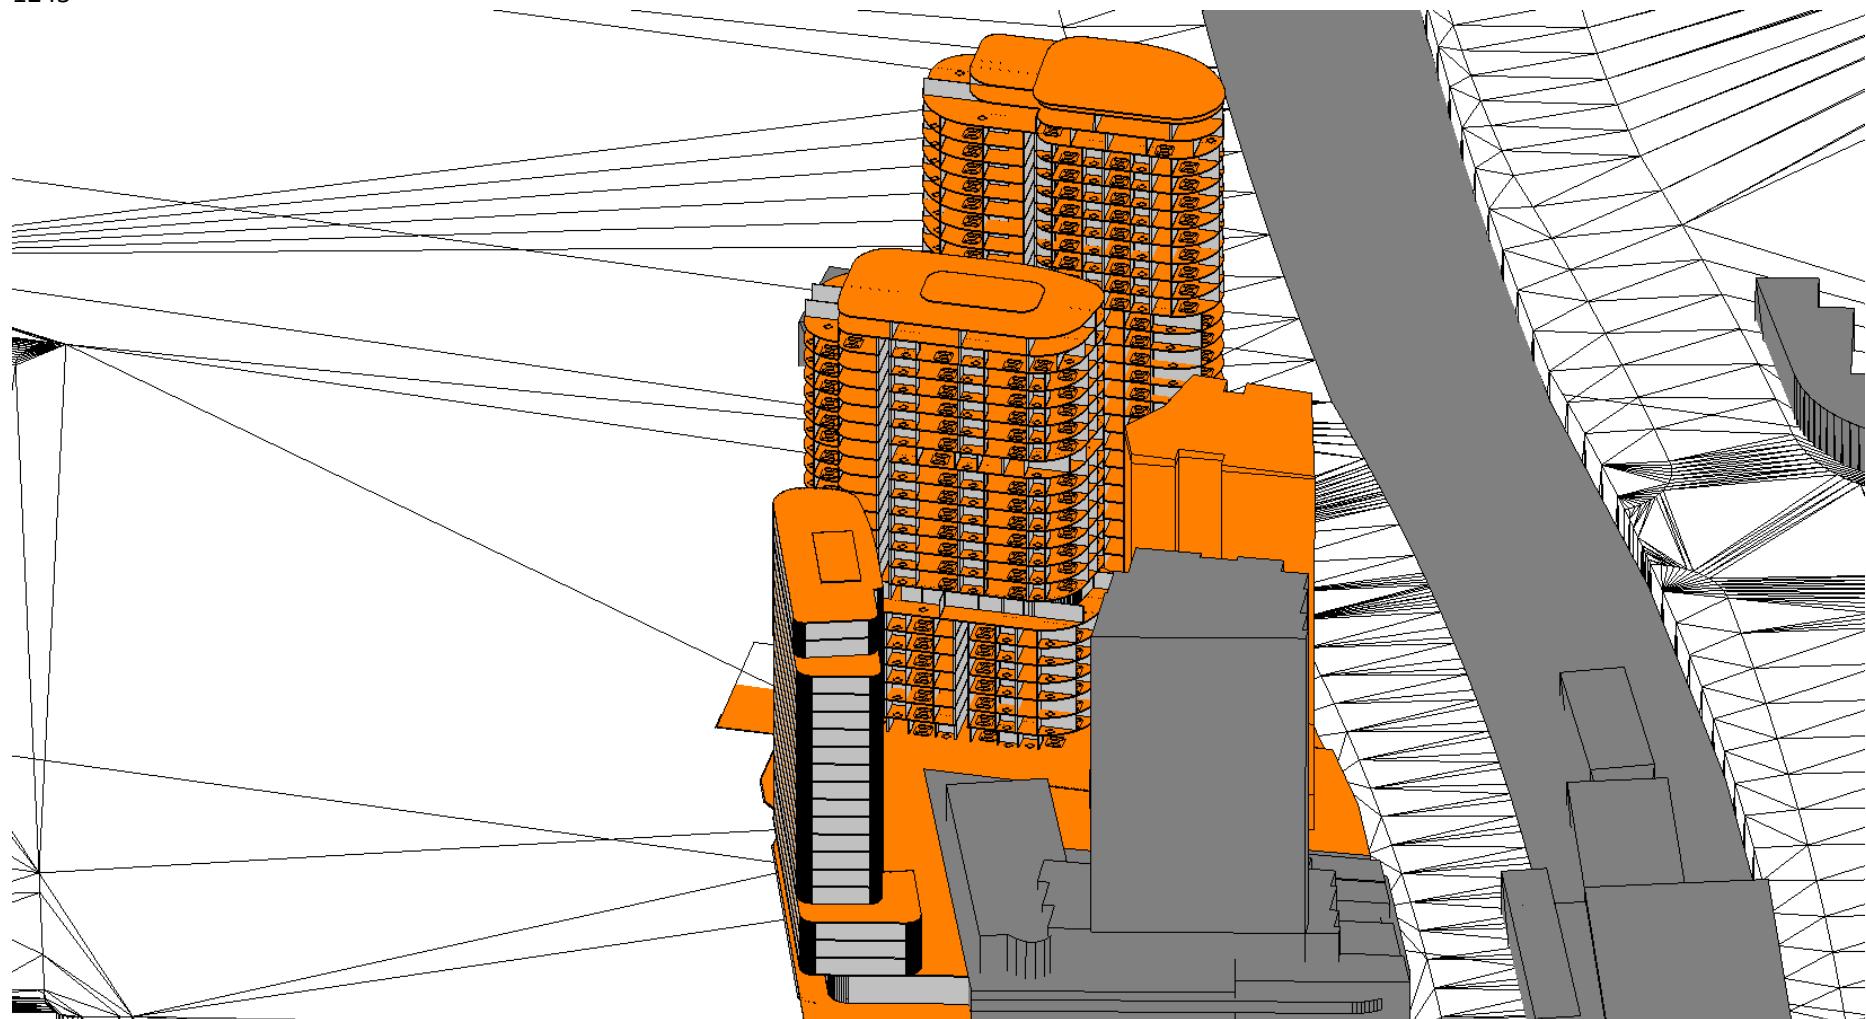
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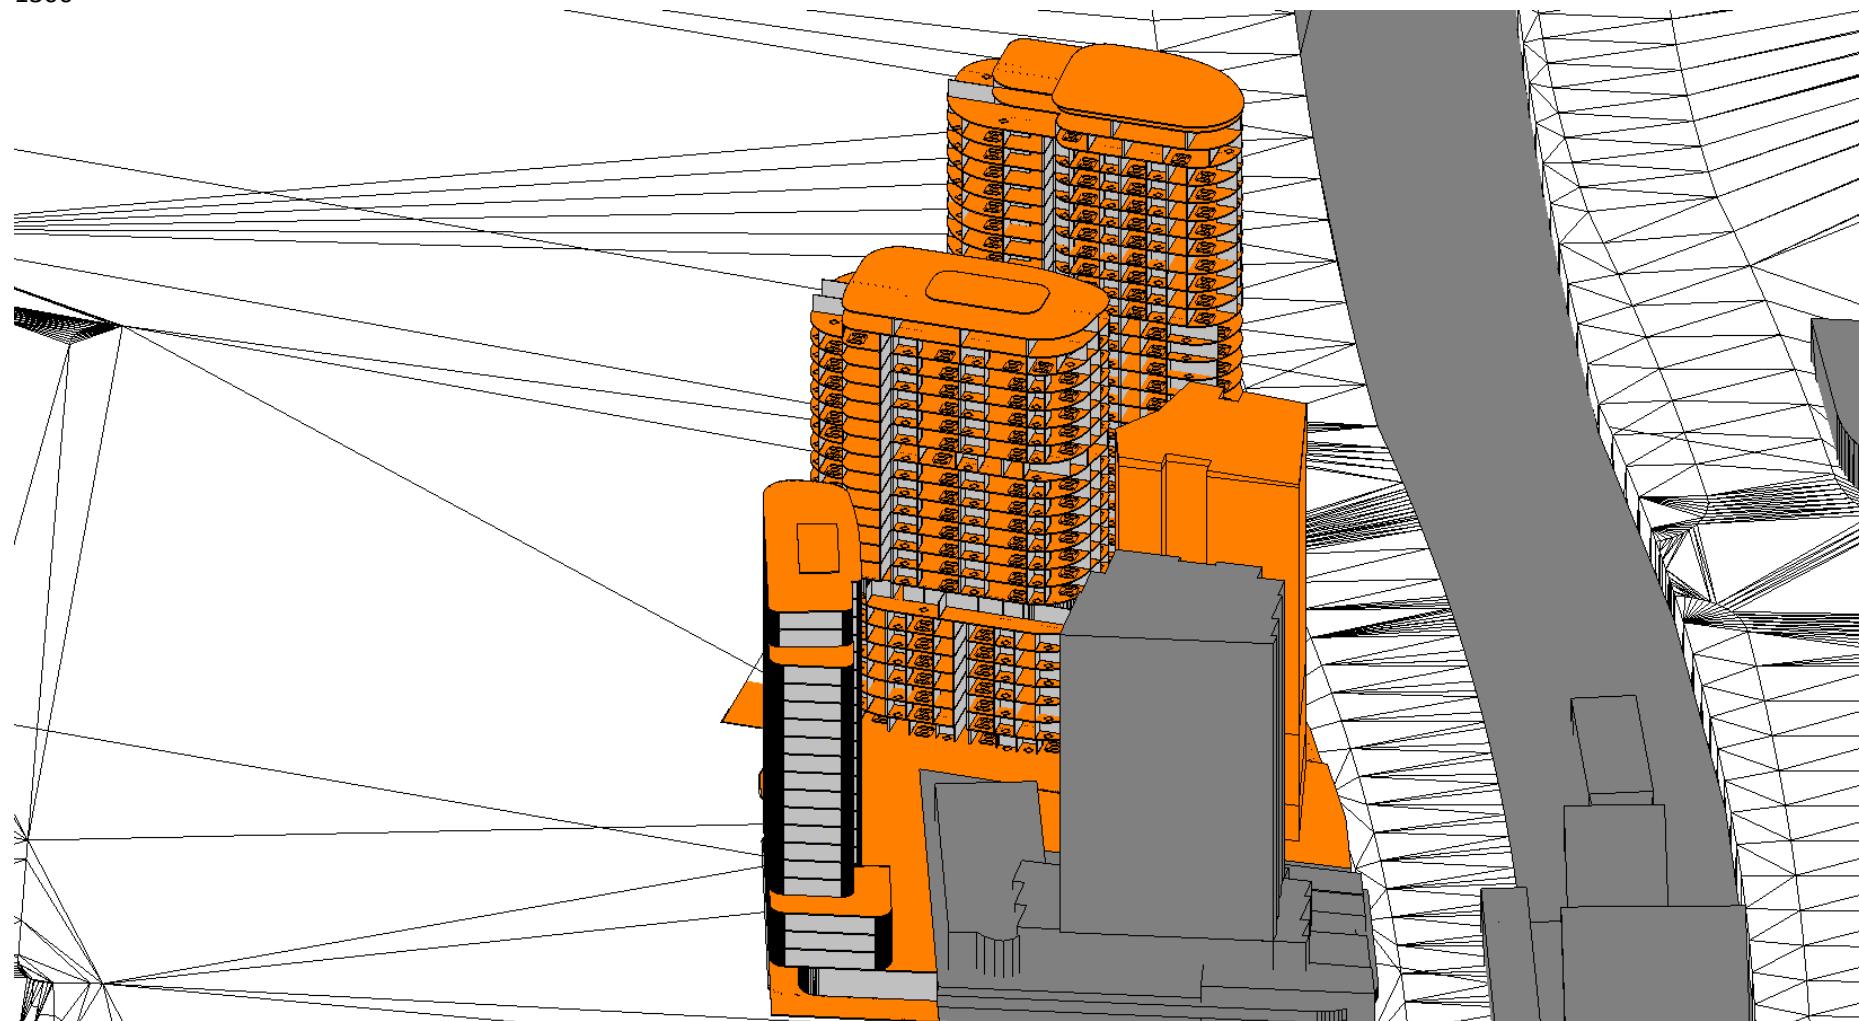
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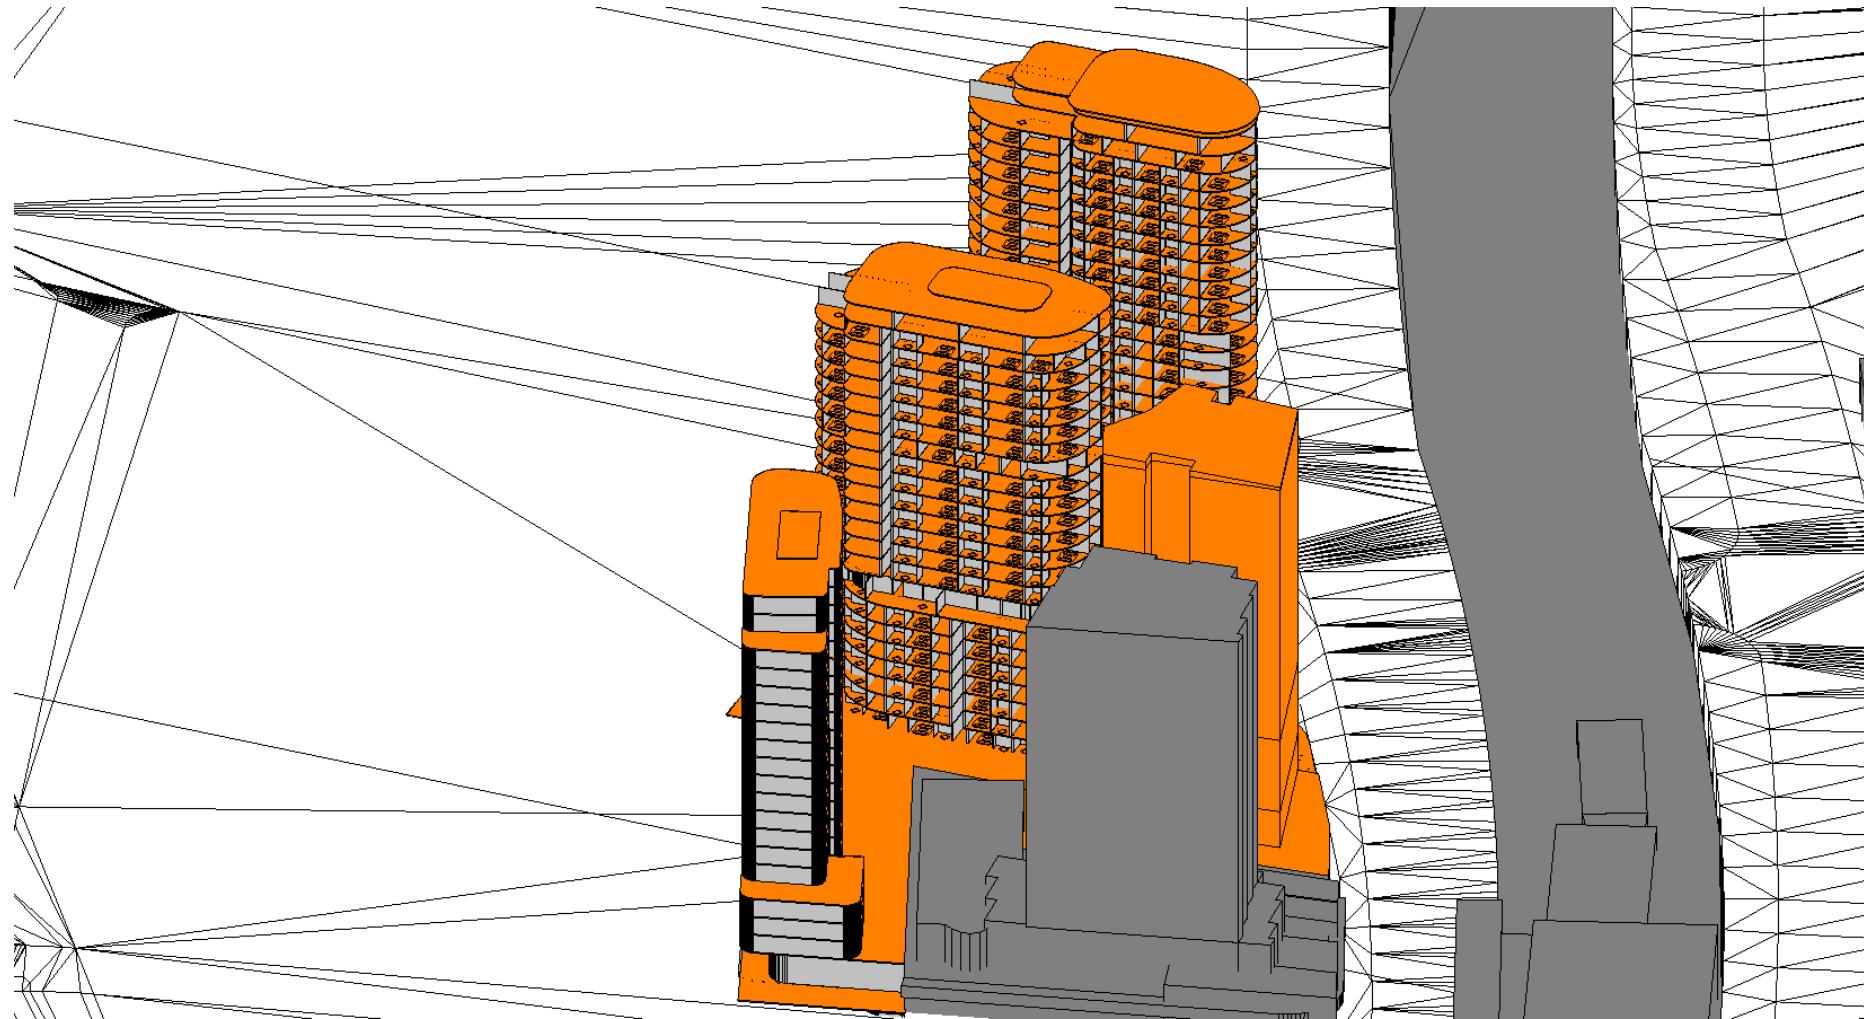
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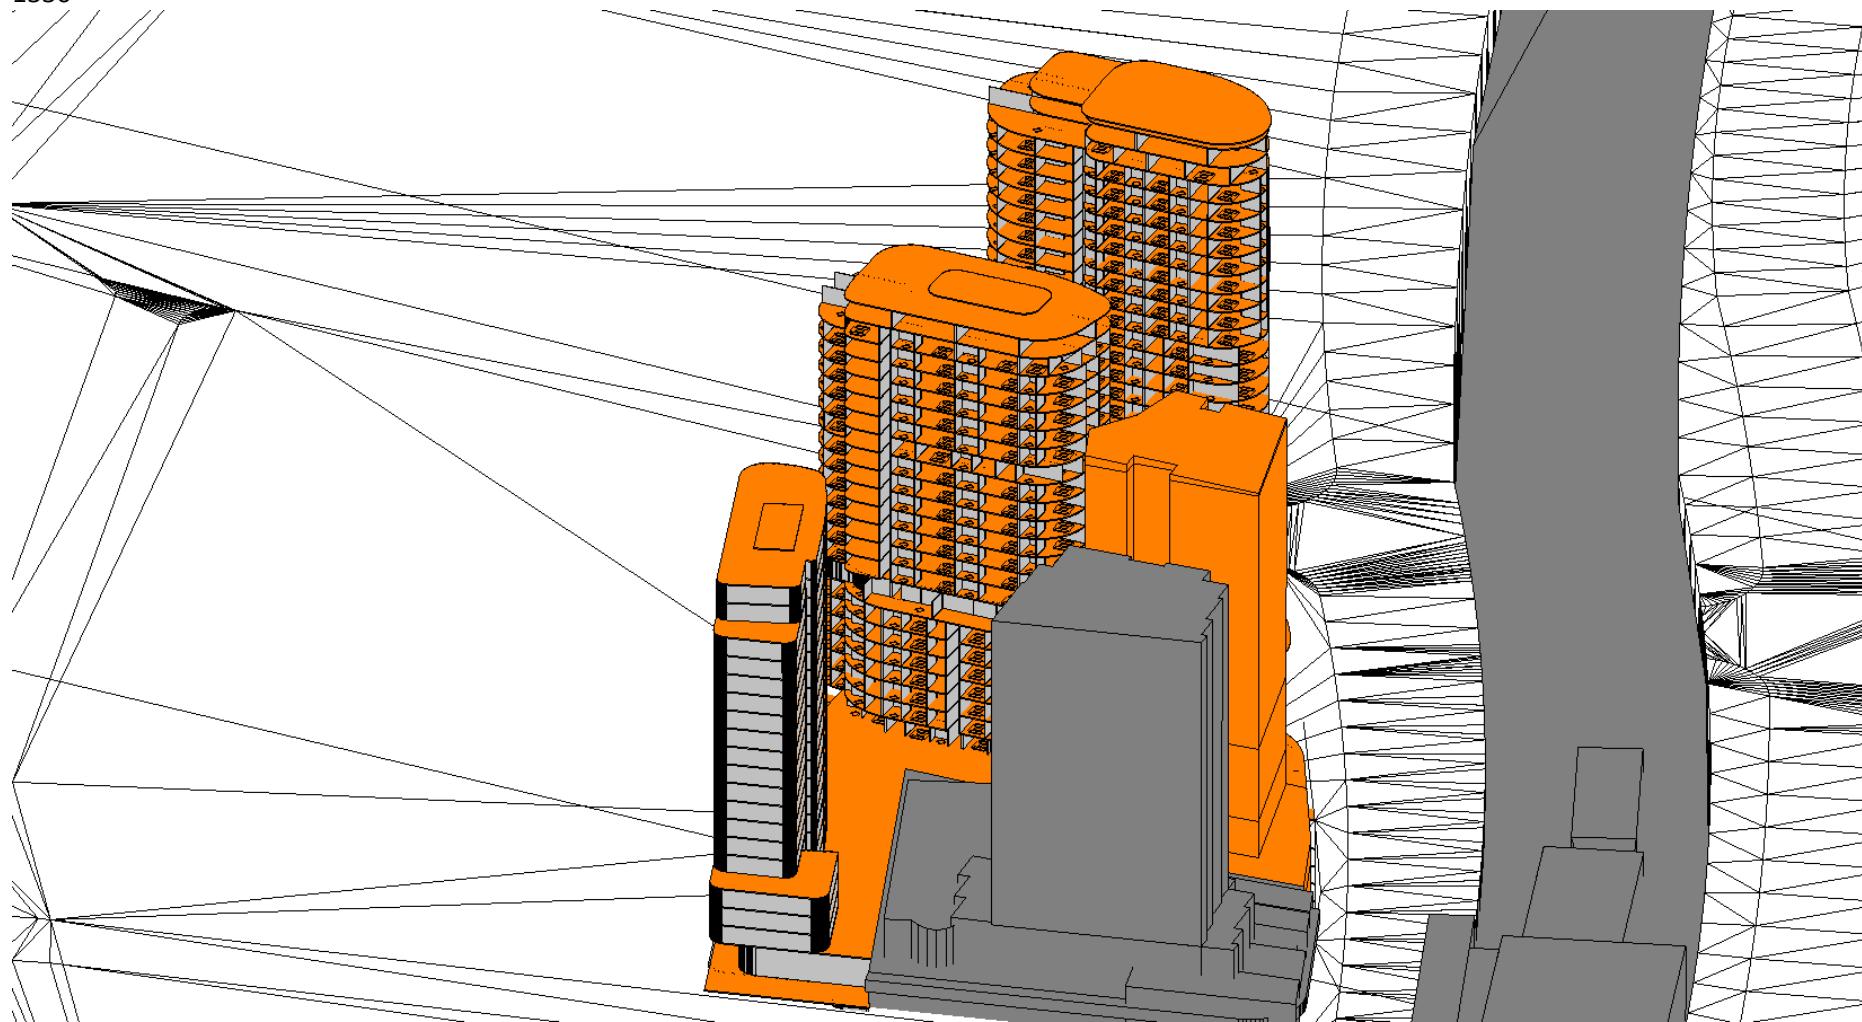
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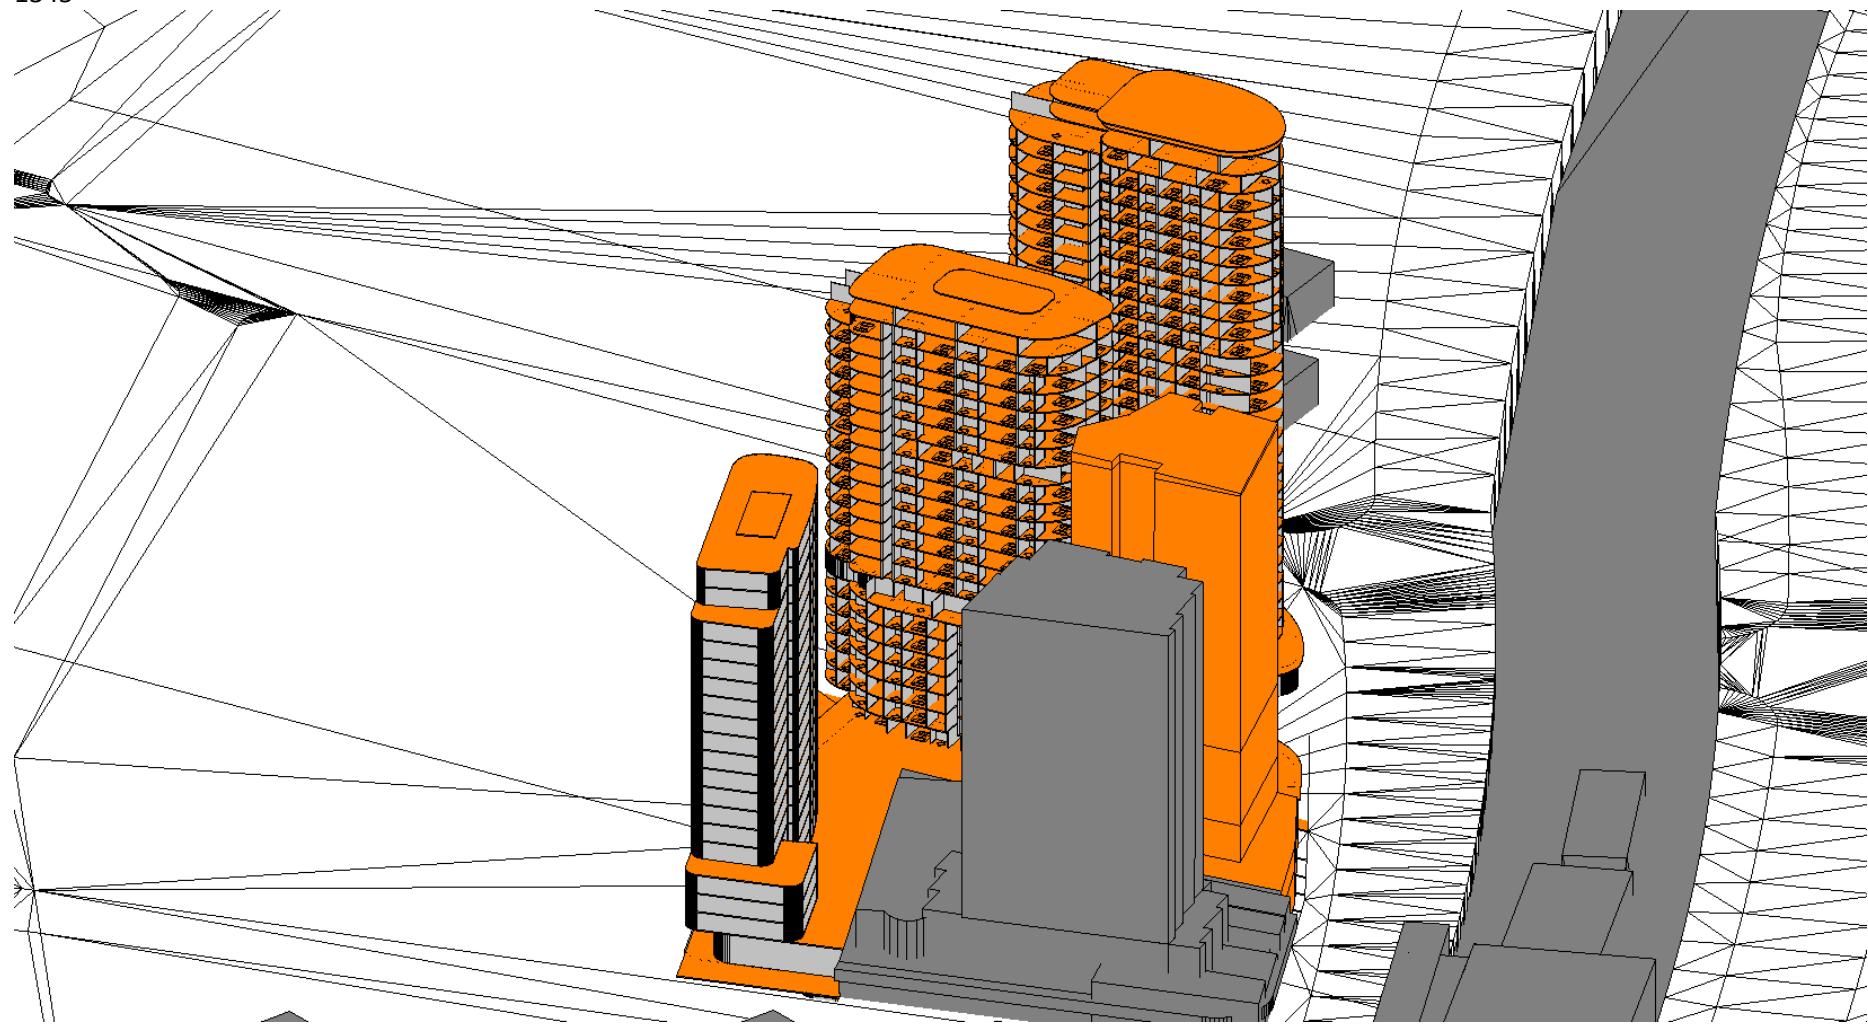
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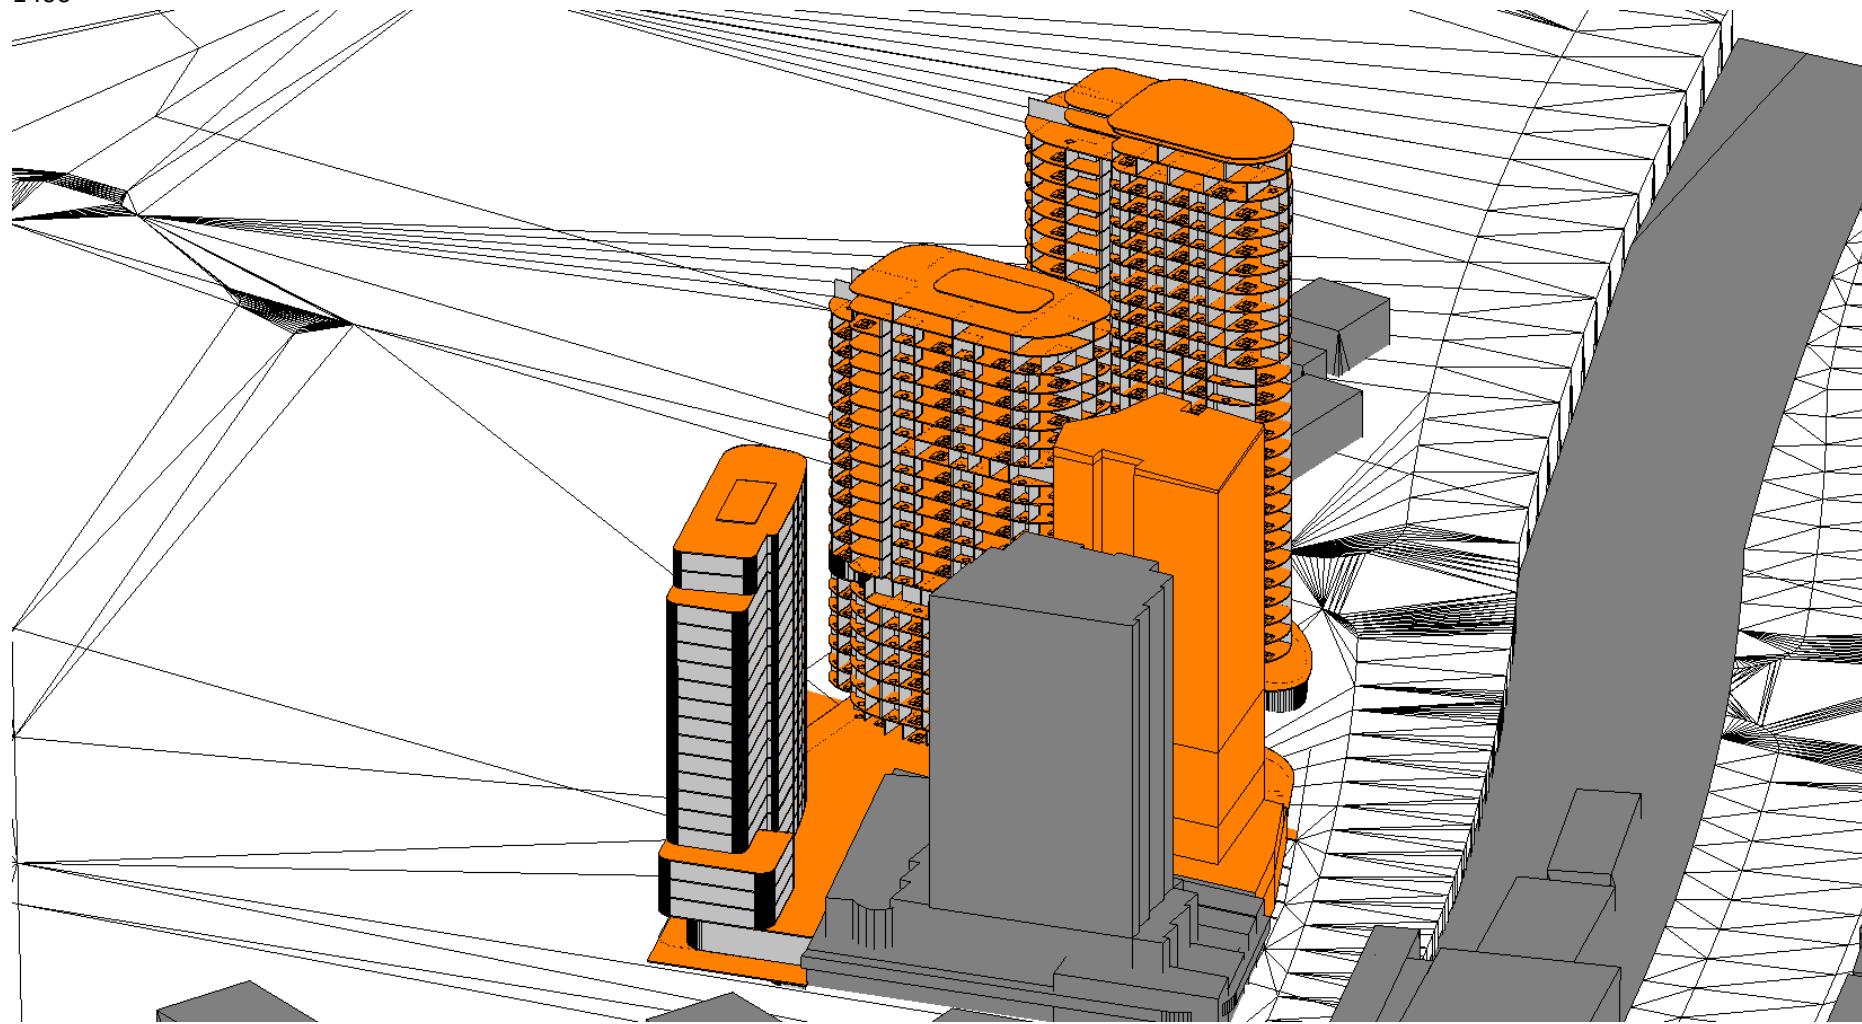
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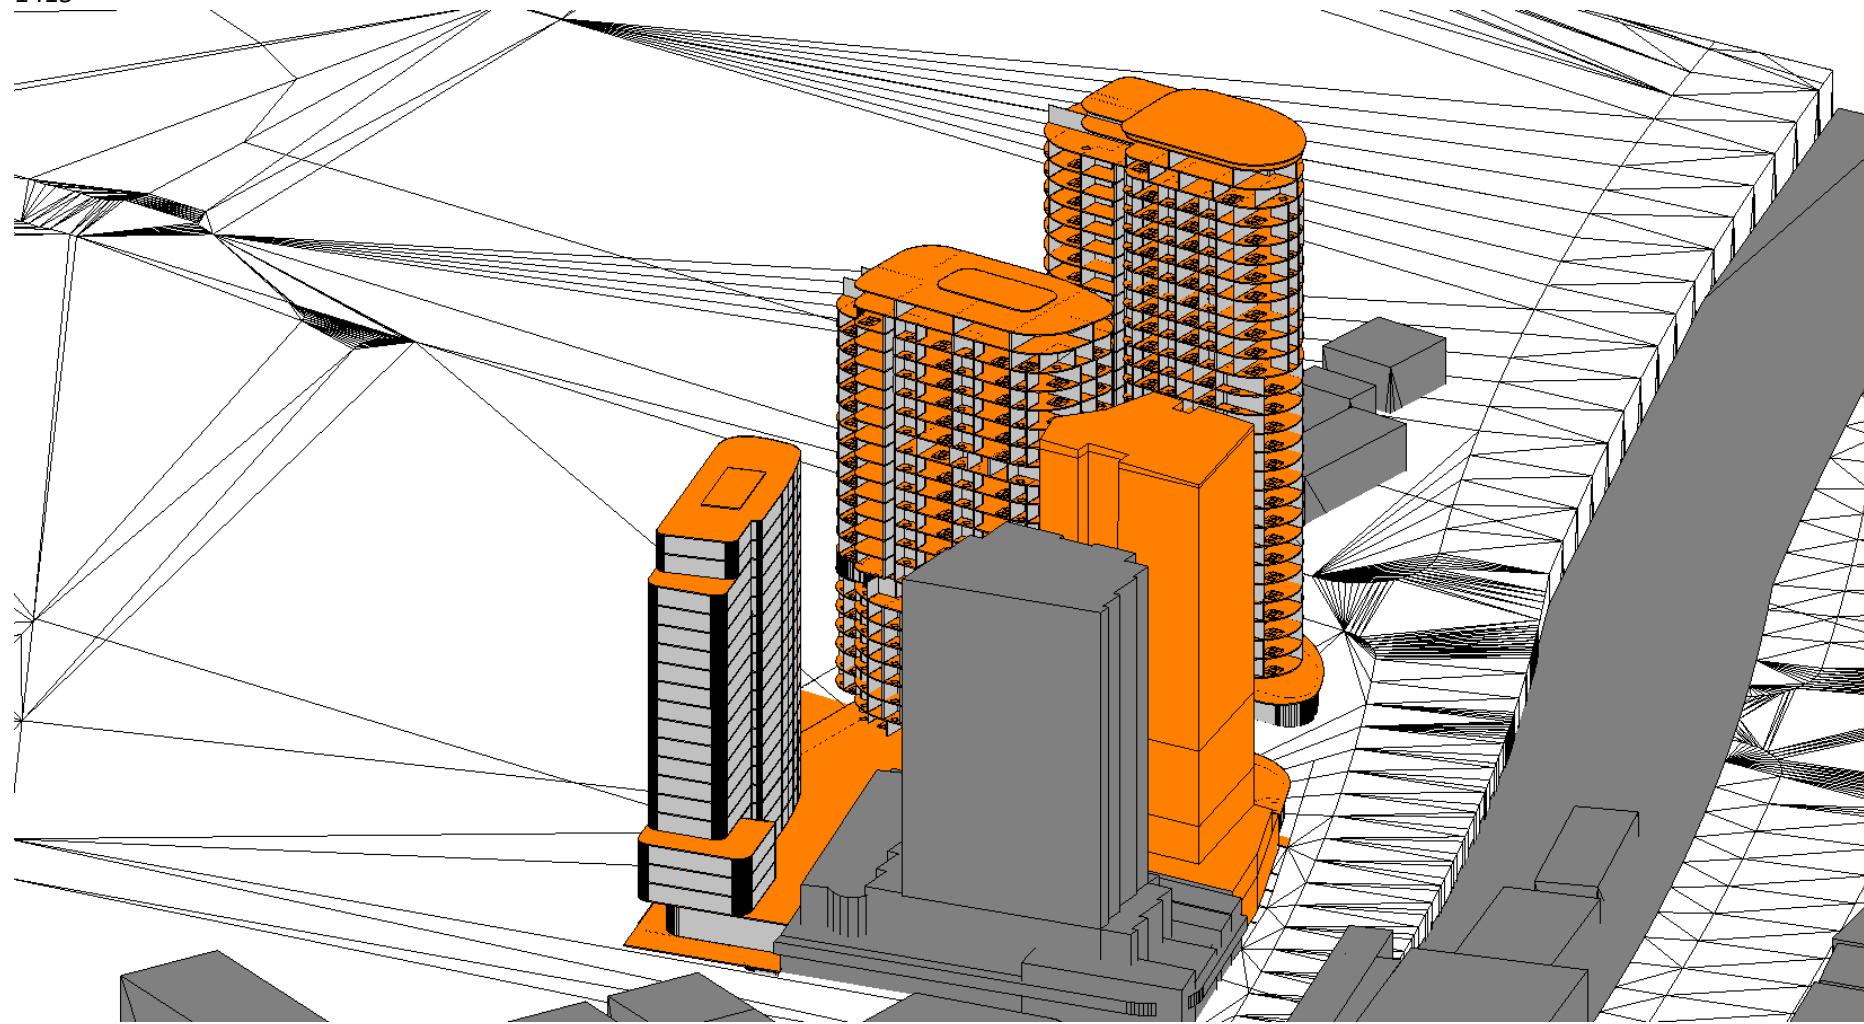
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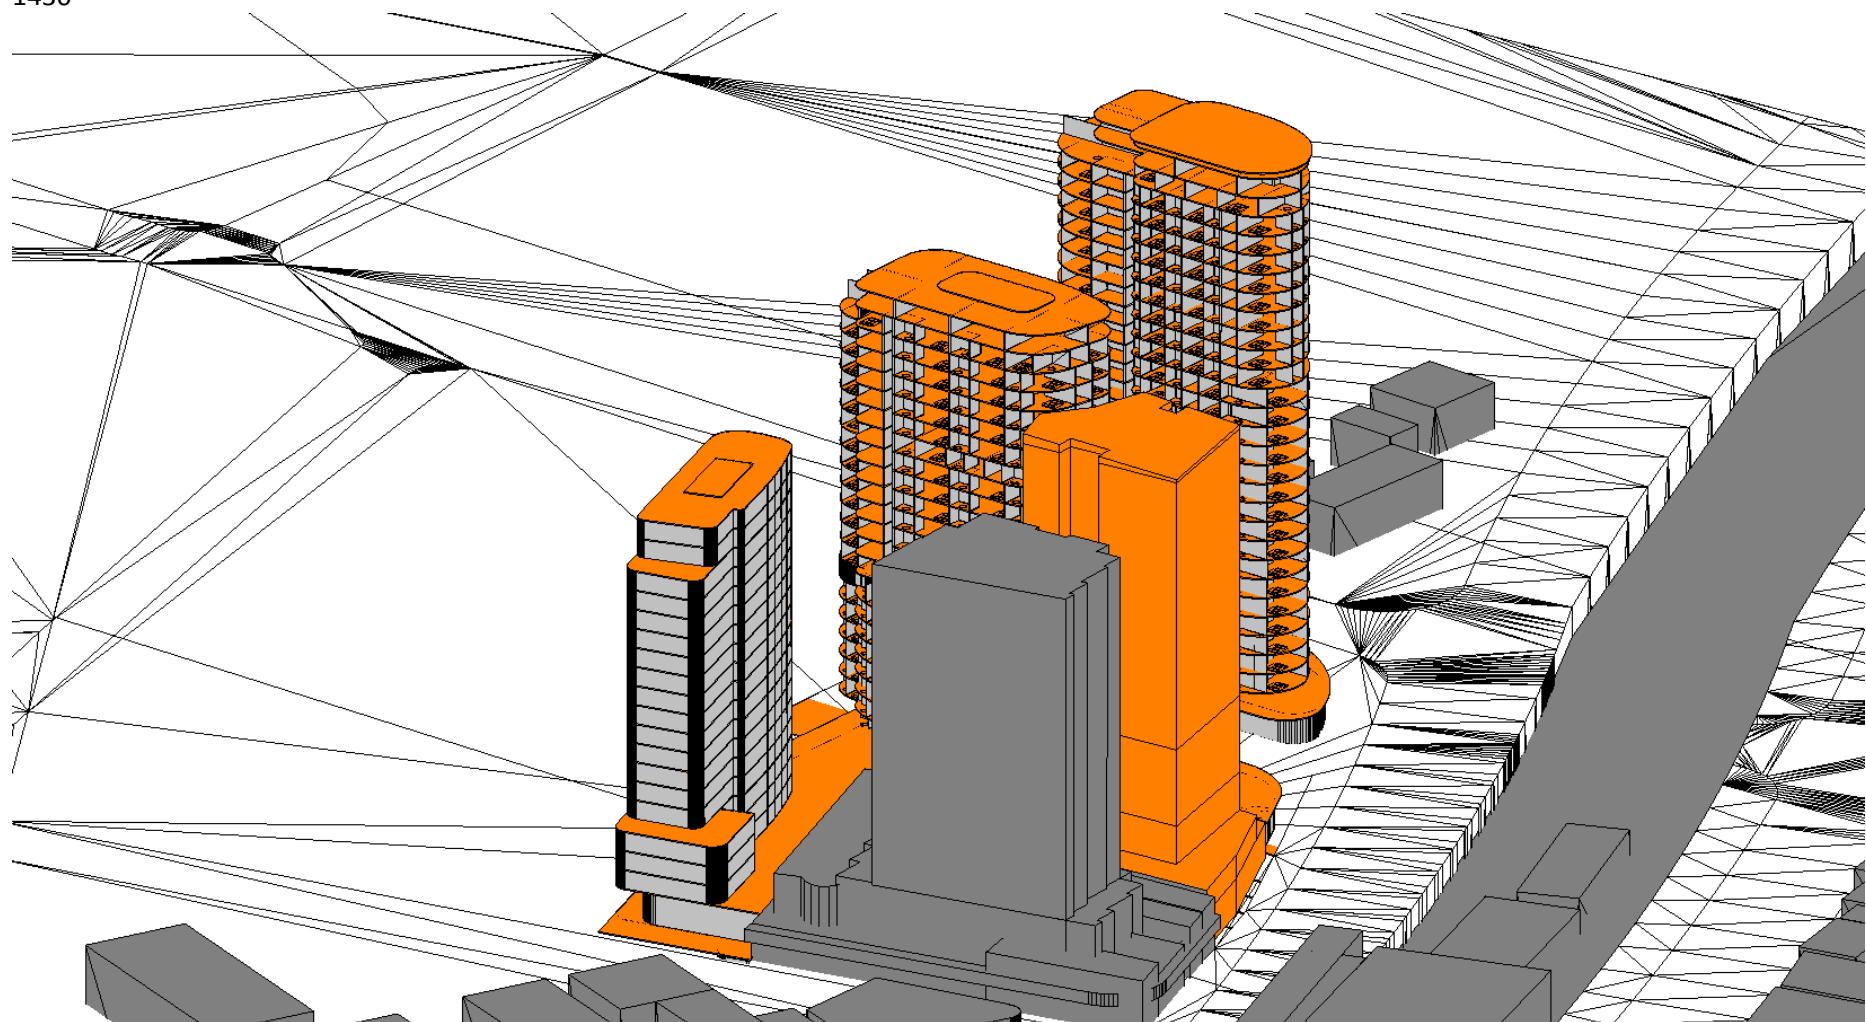
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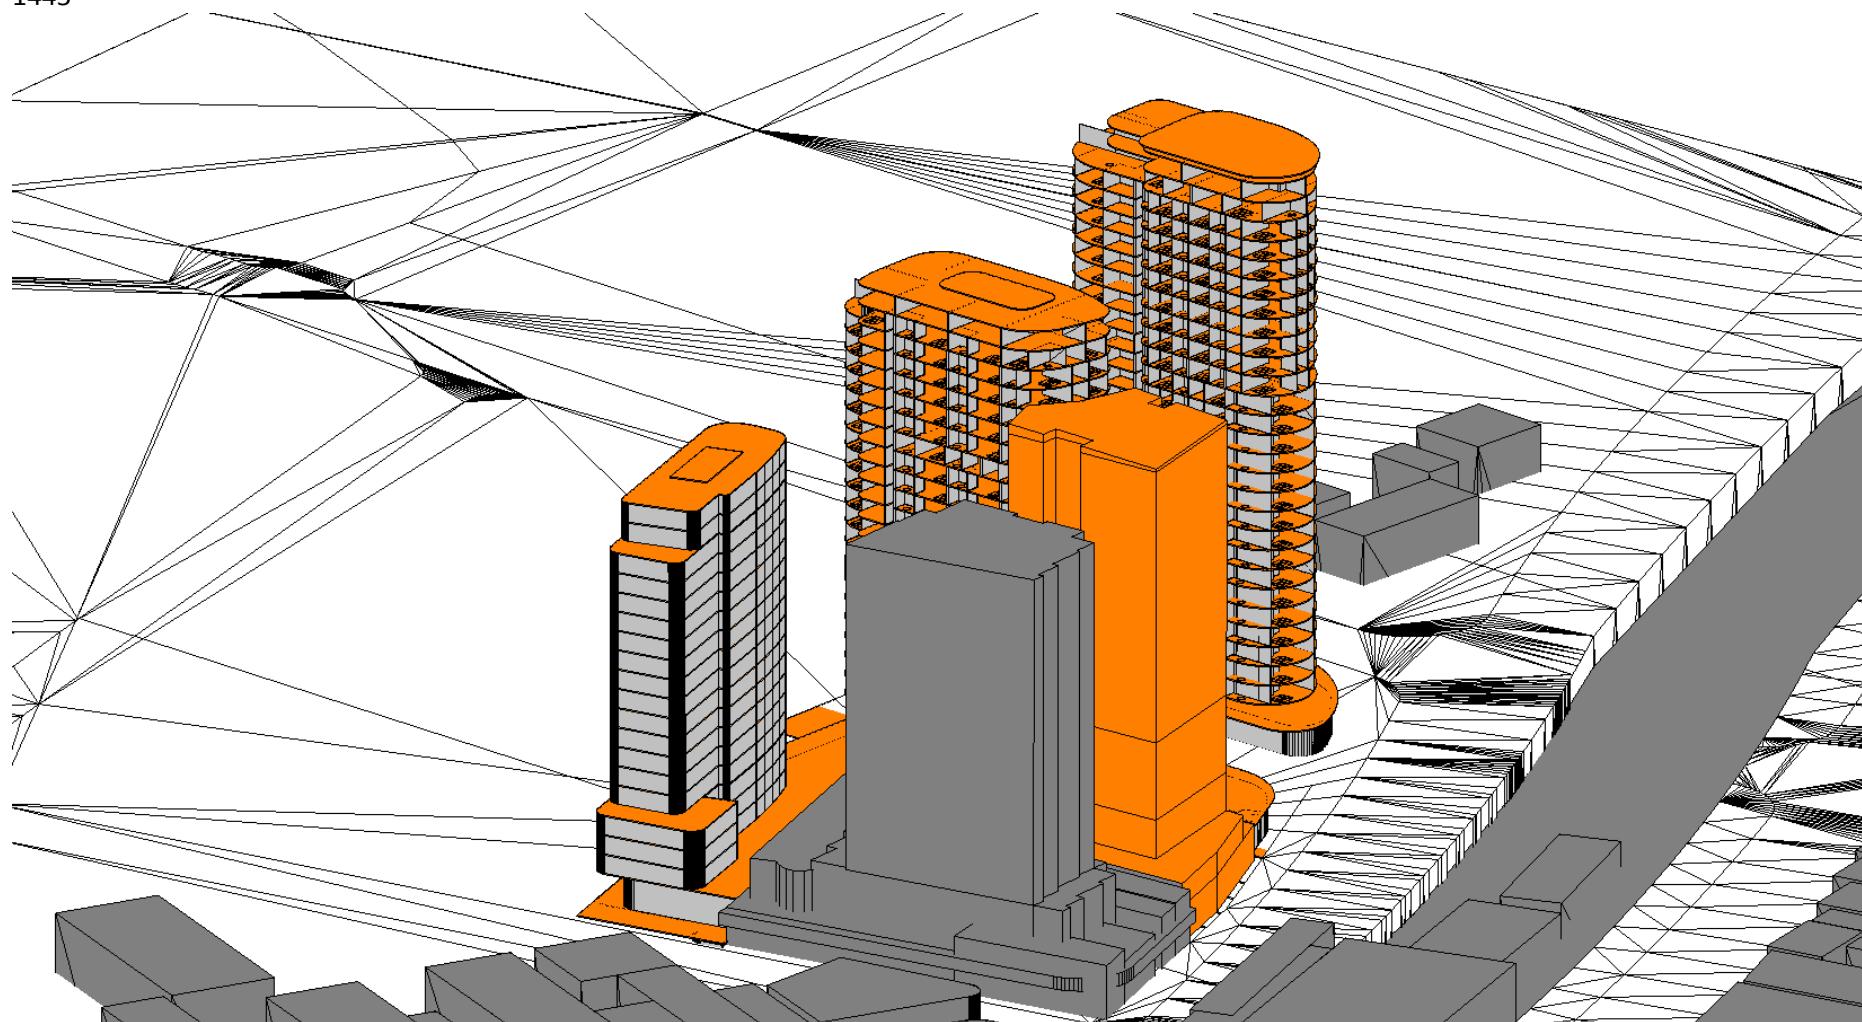
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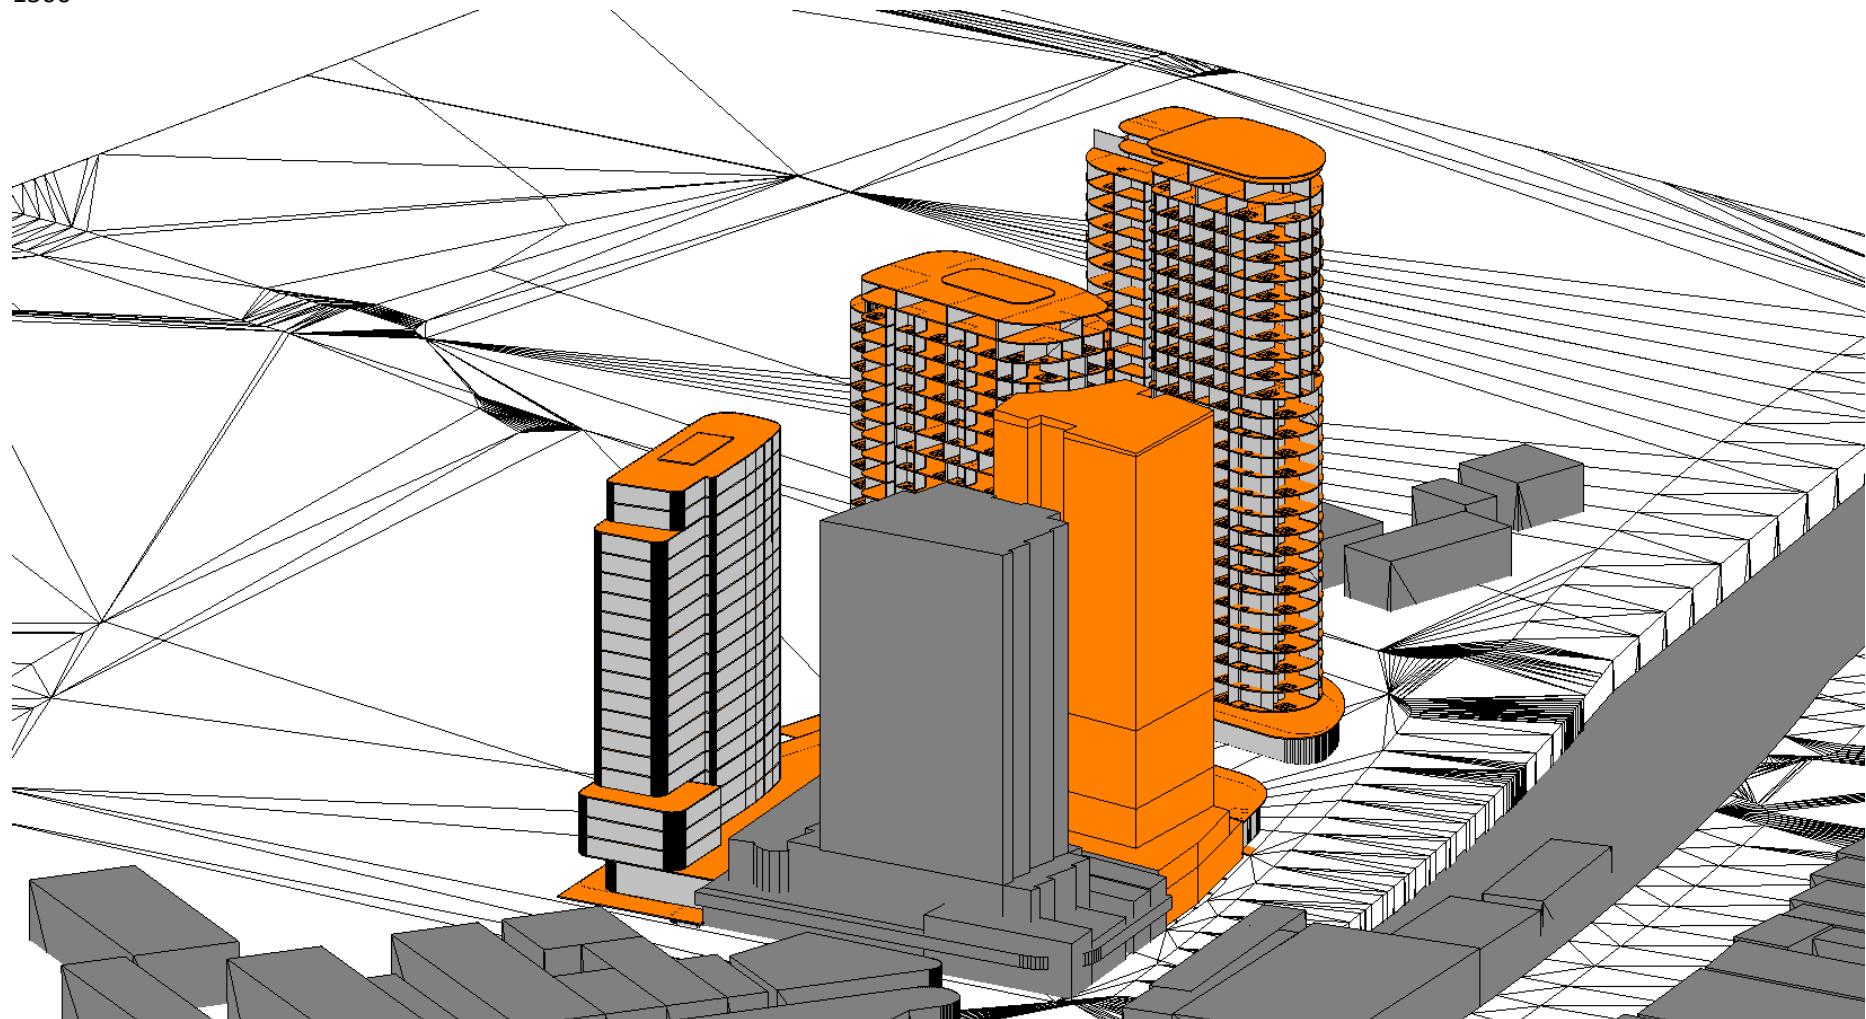
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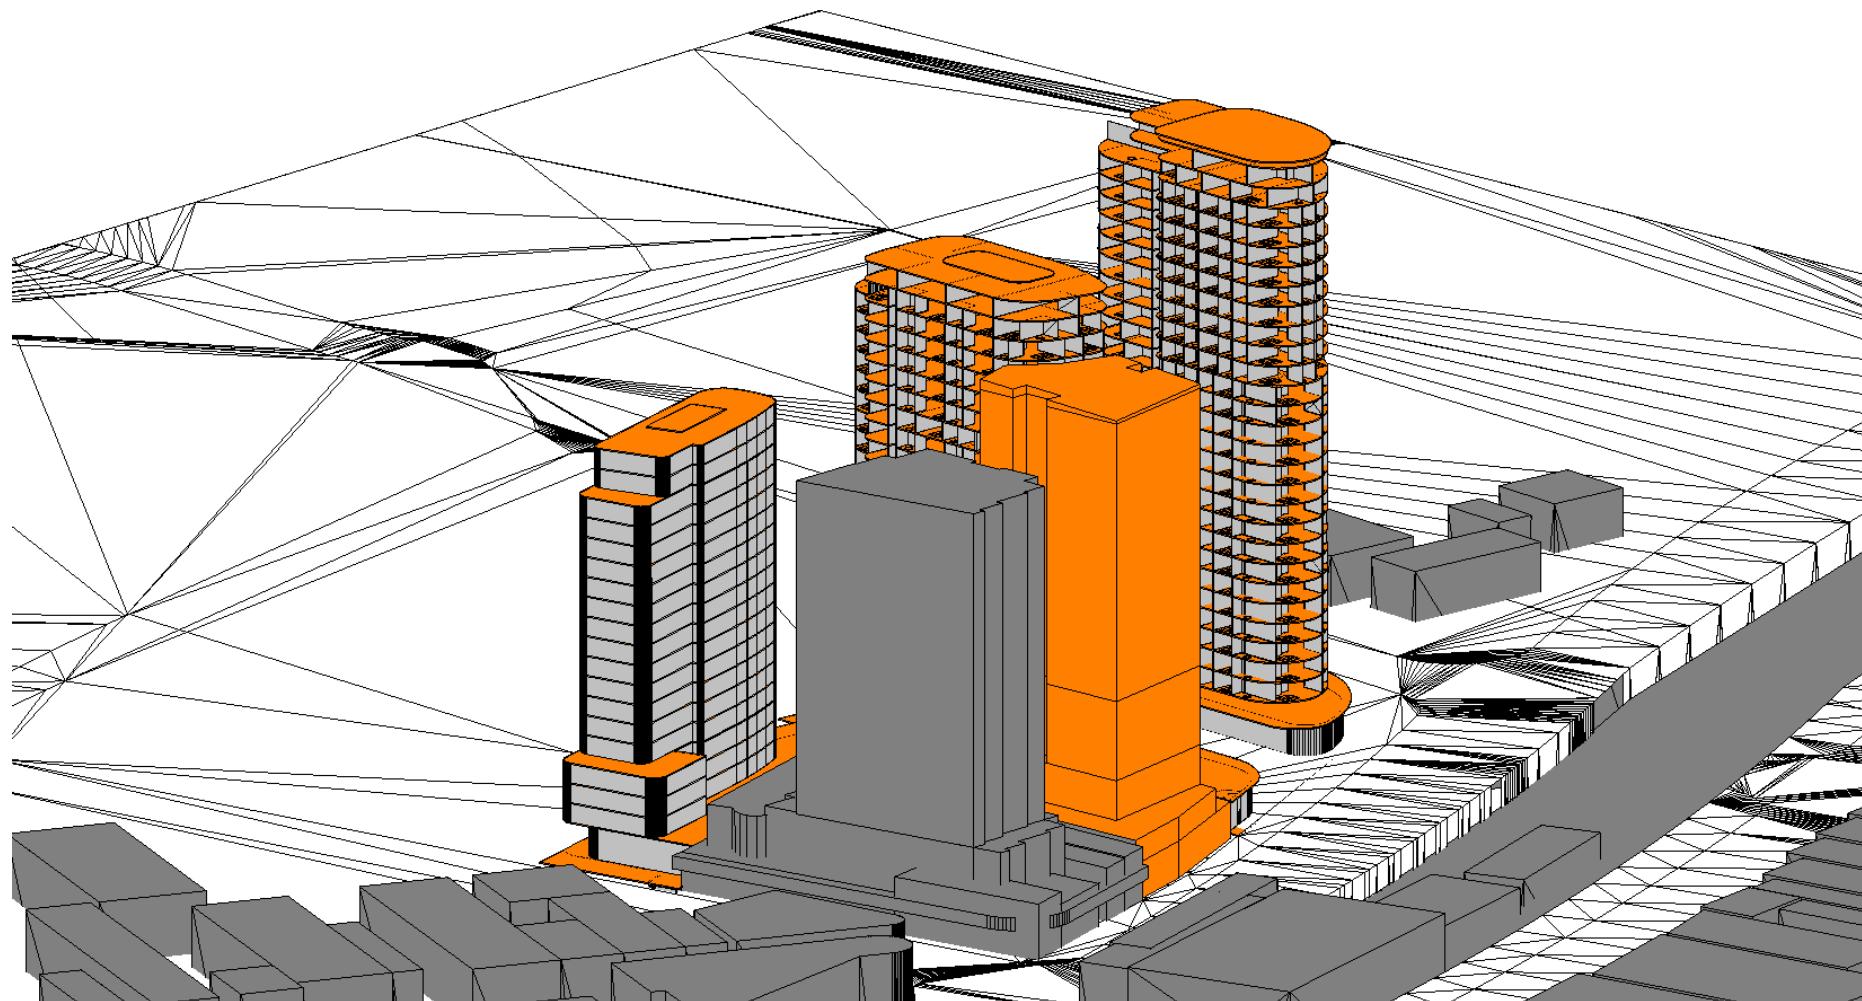


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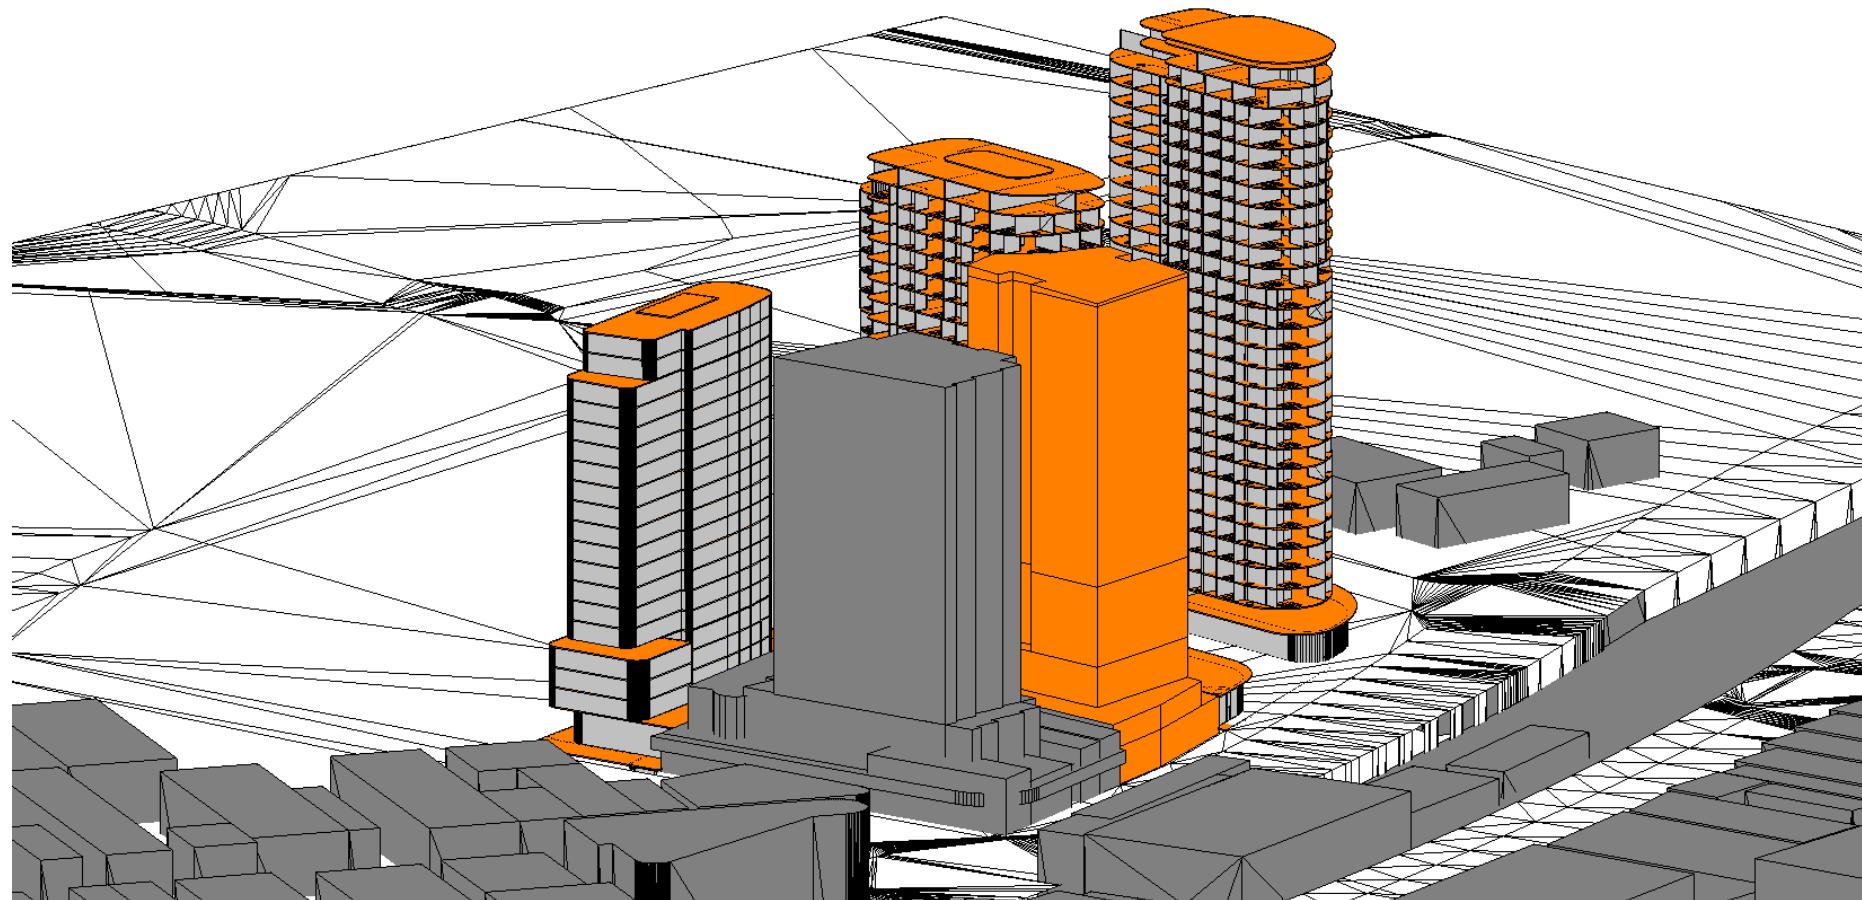


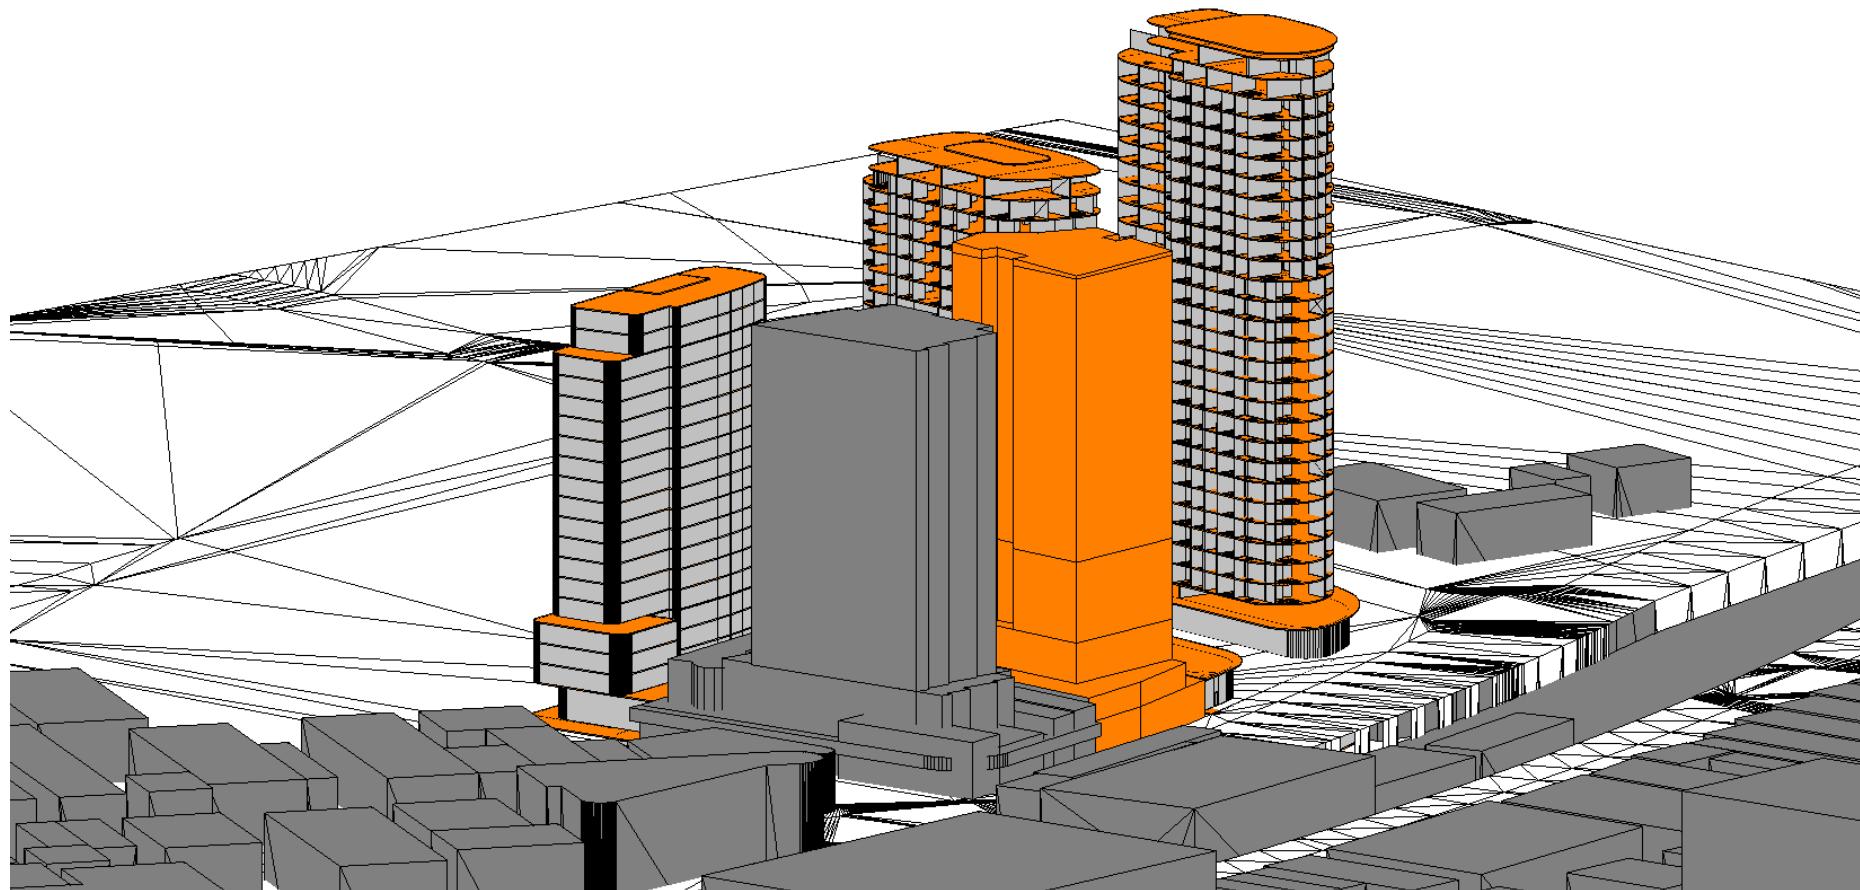
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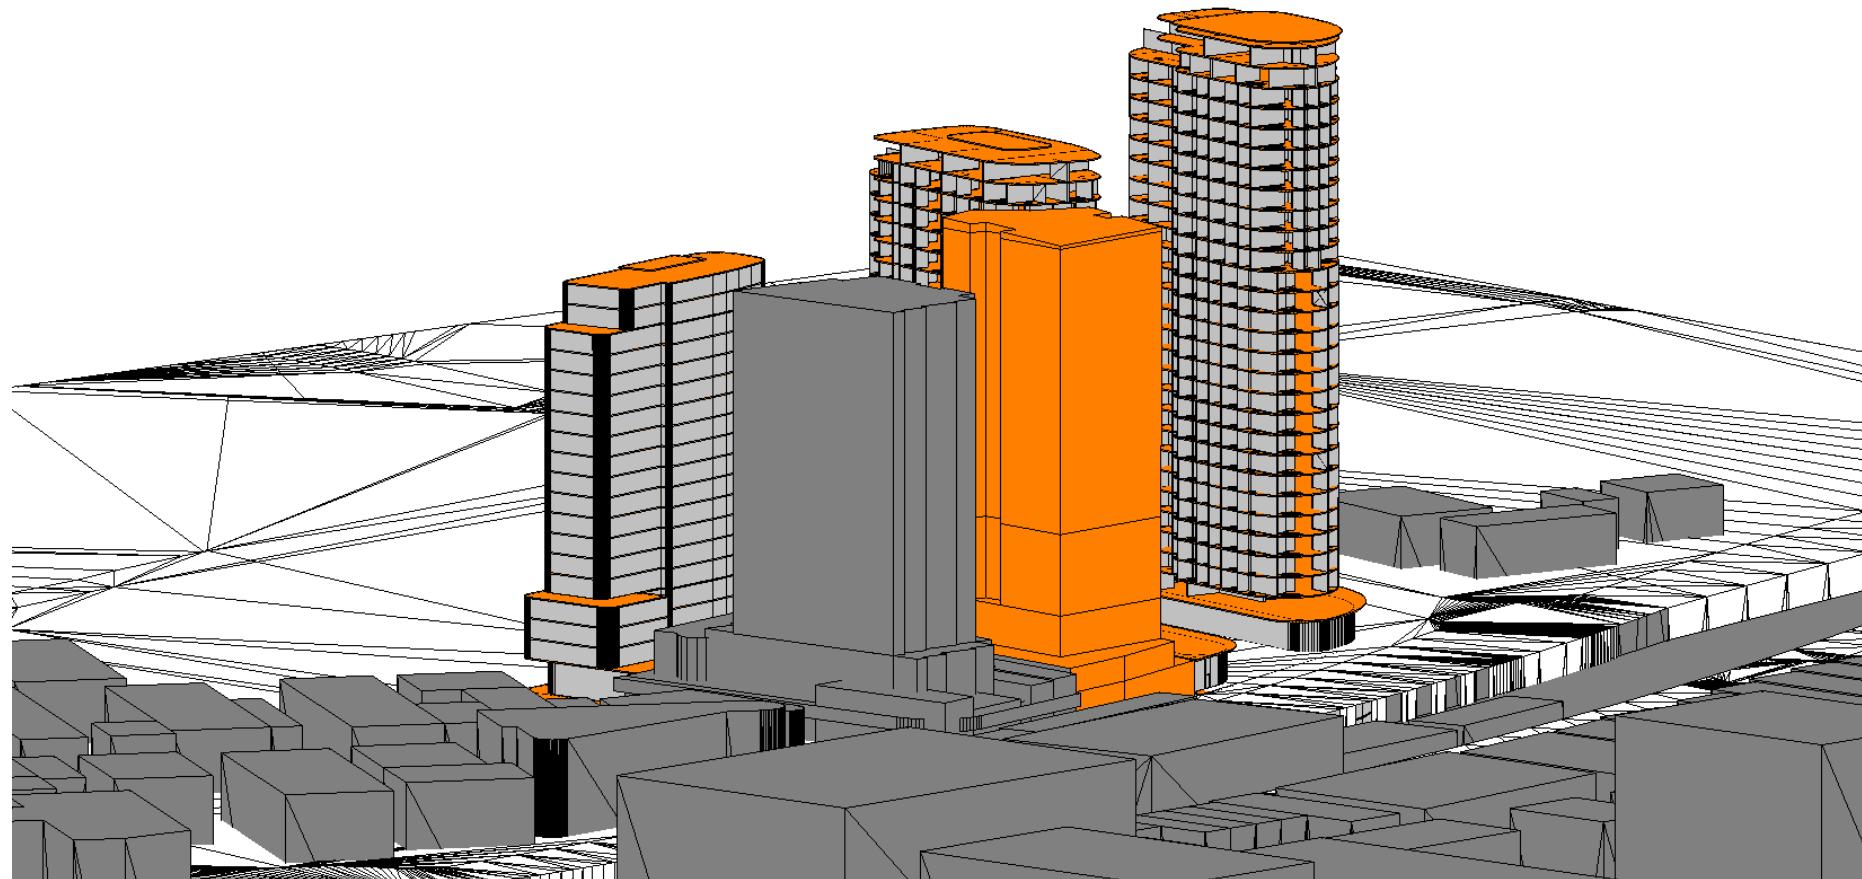


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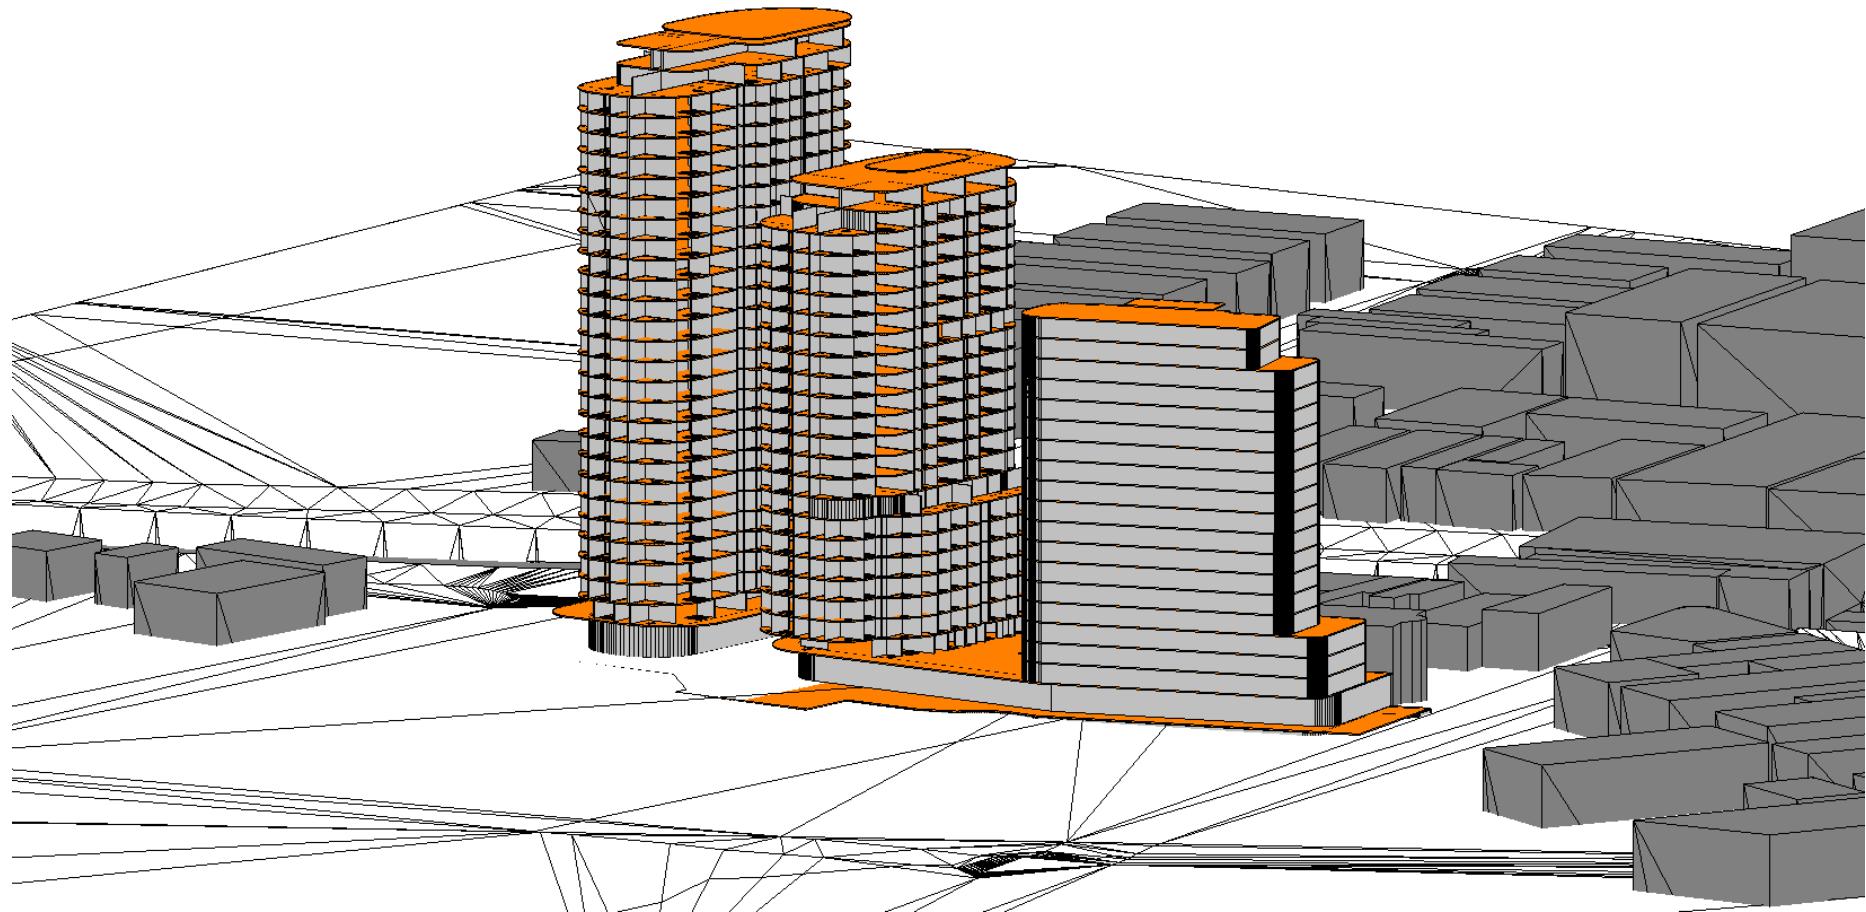
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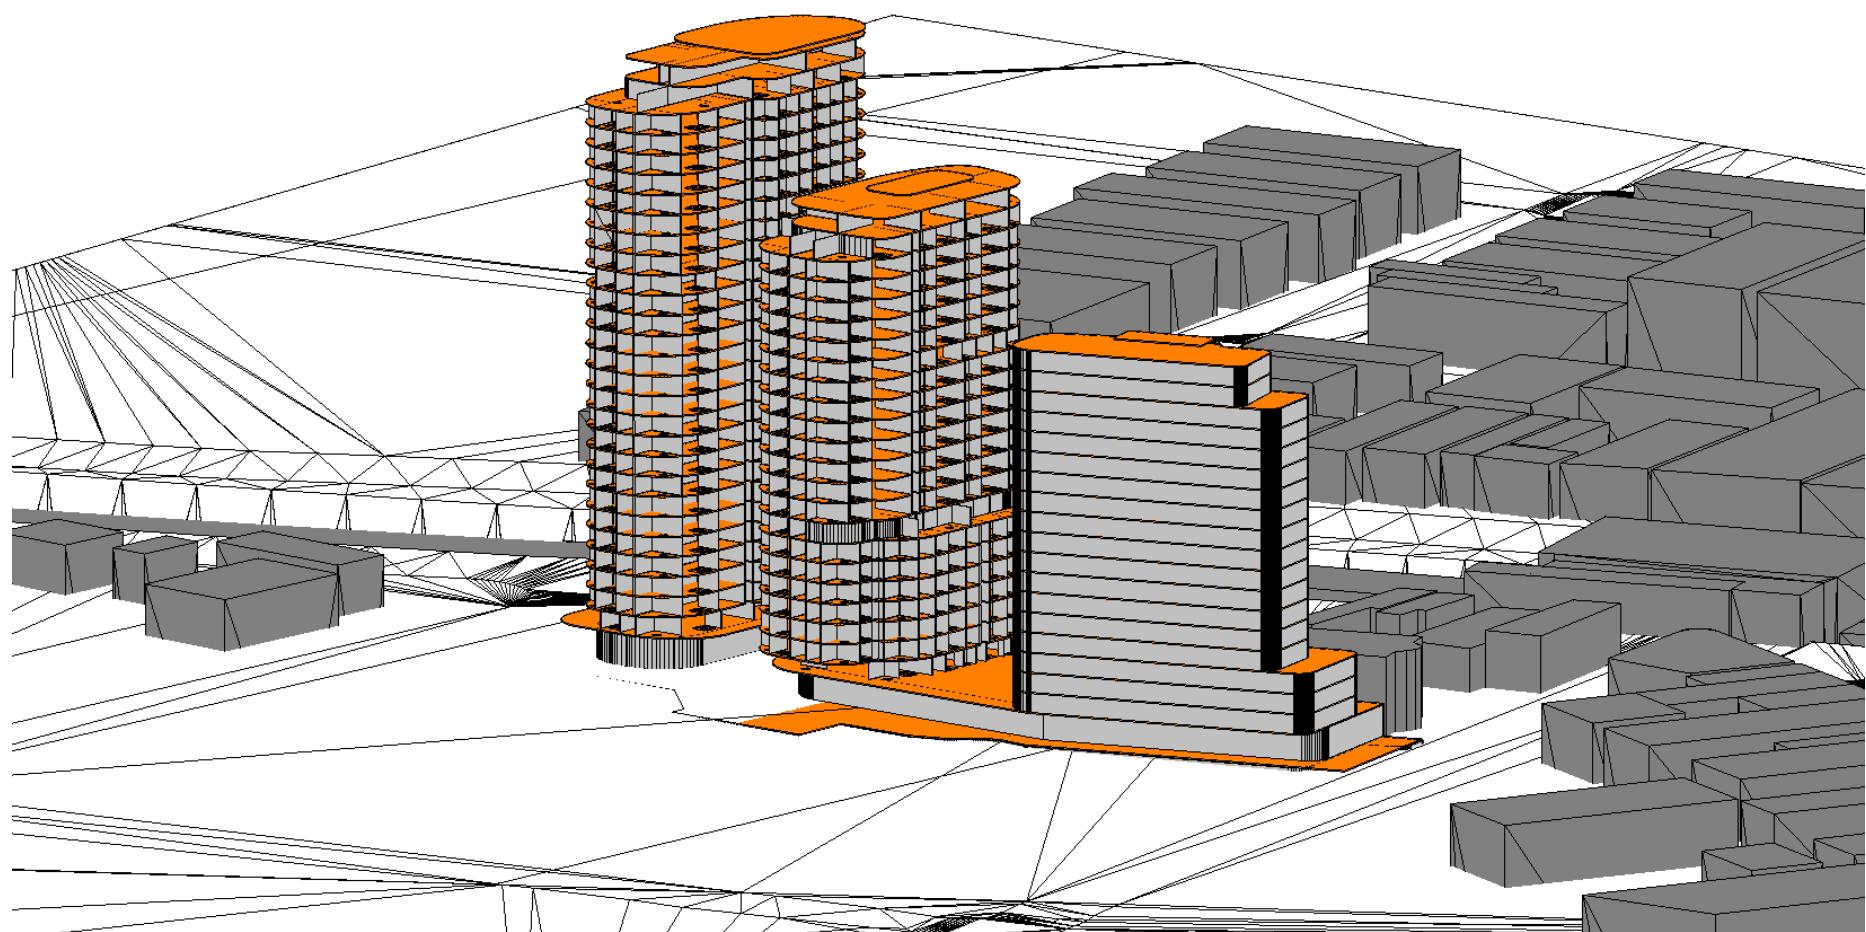
## APPENDIX F

Sun Eye Views CBUS Development with no other Proposed Development

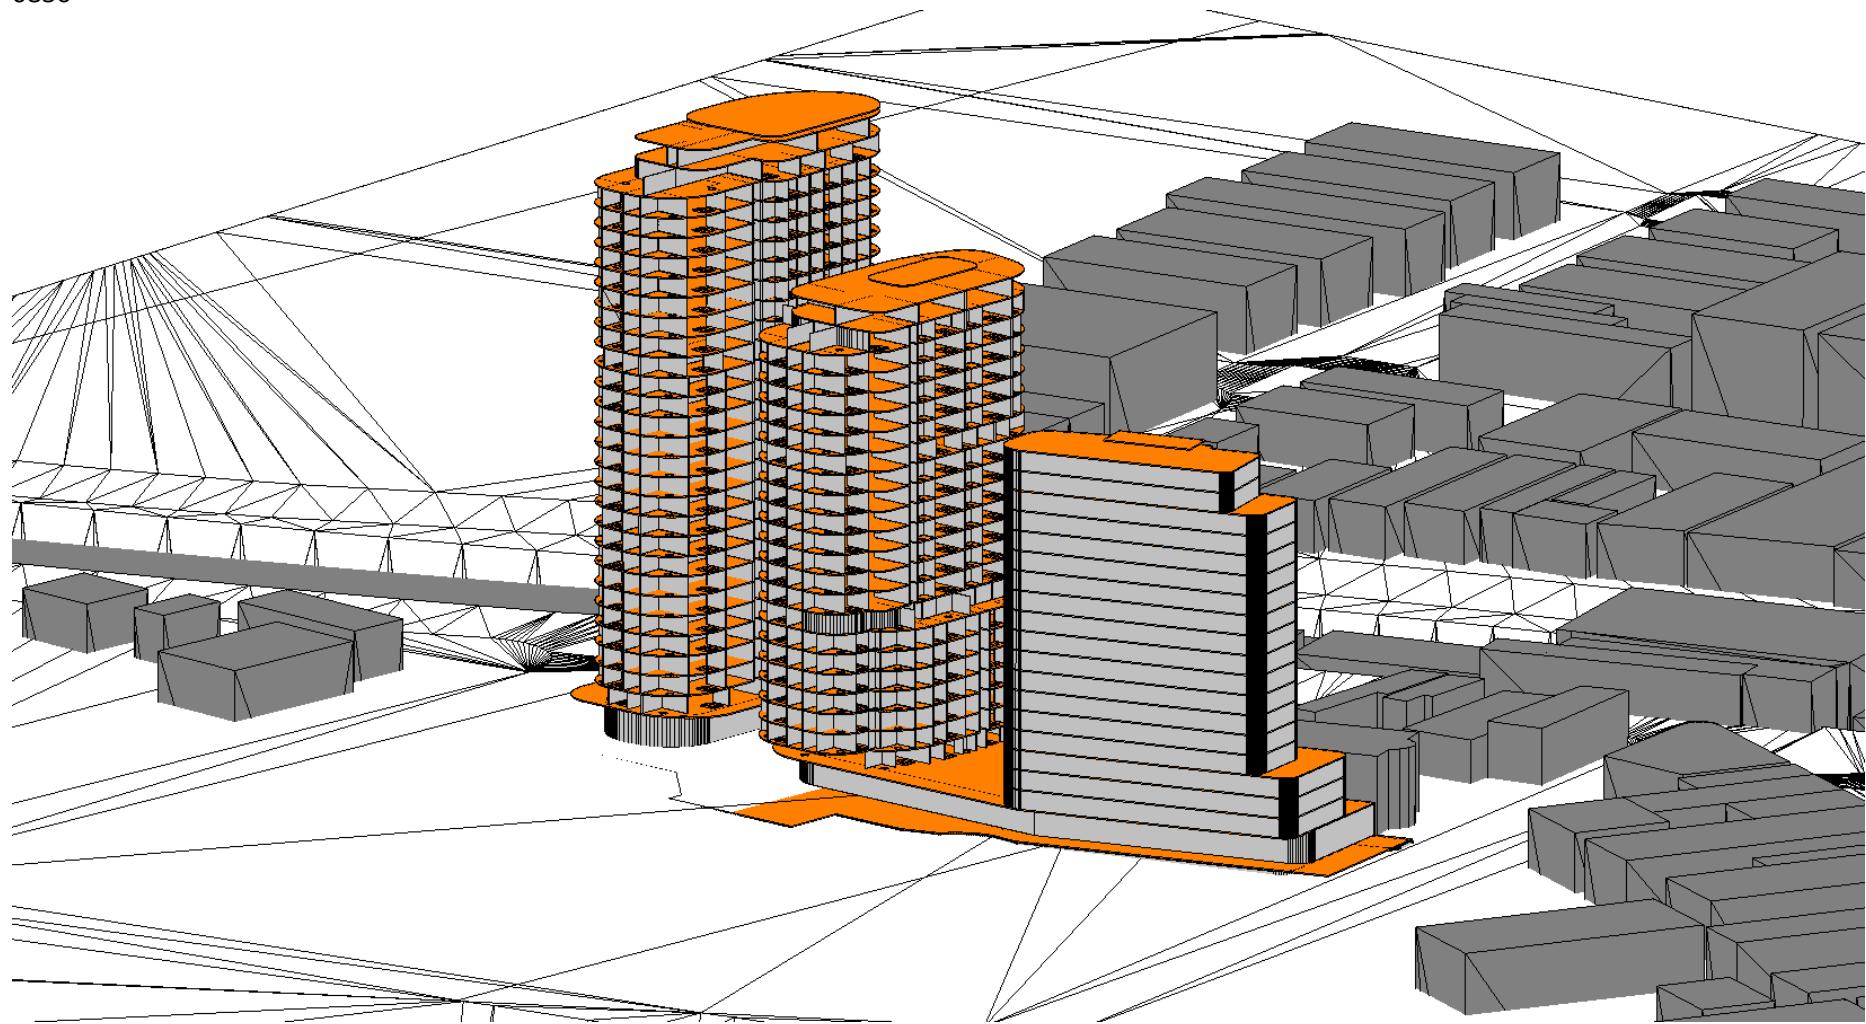
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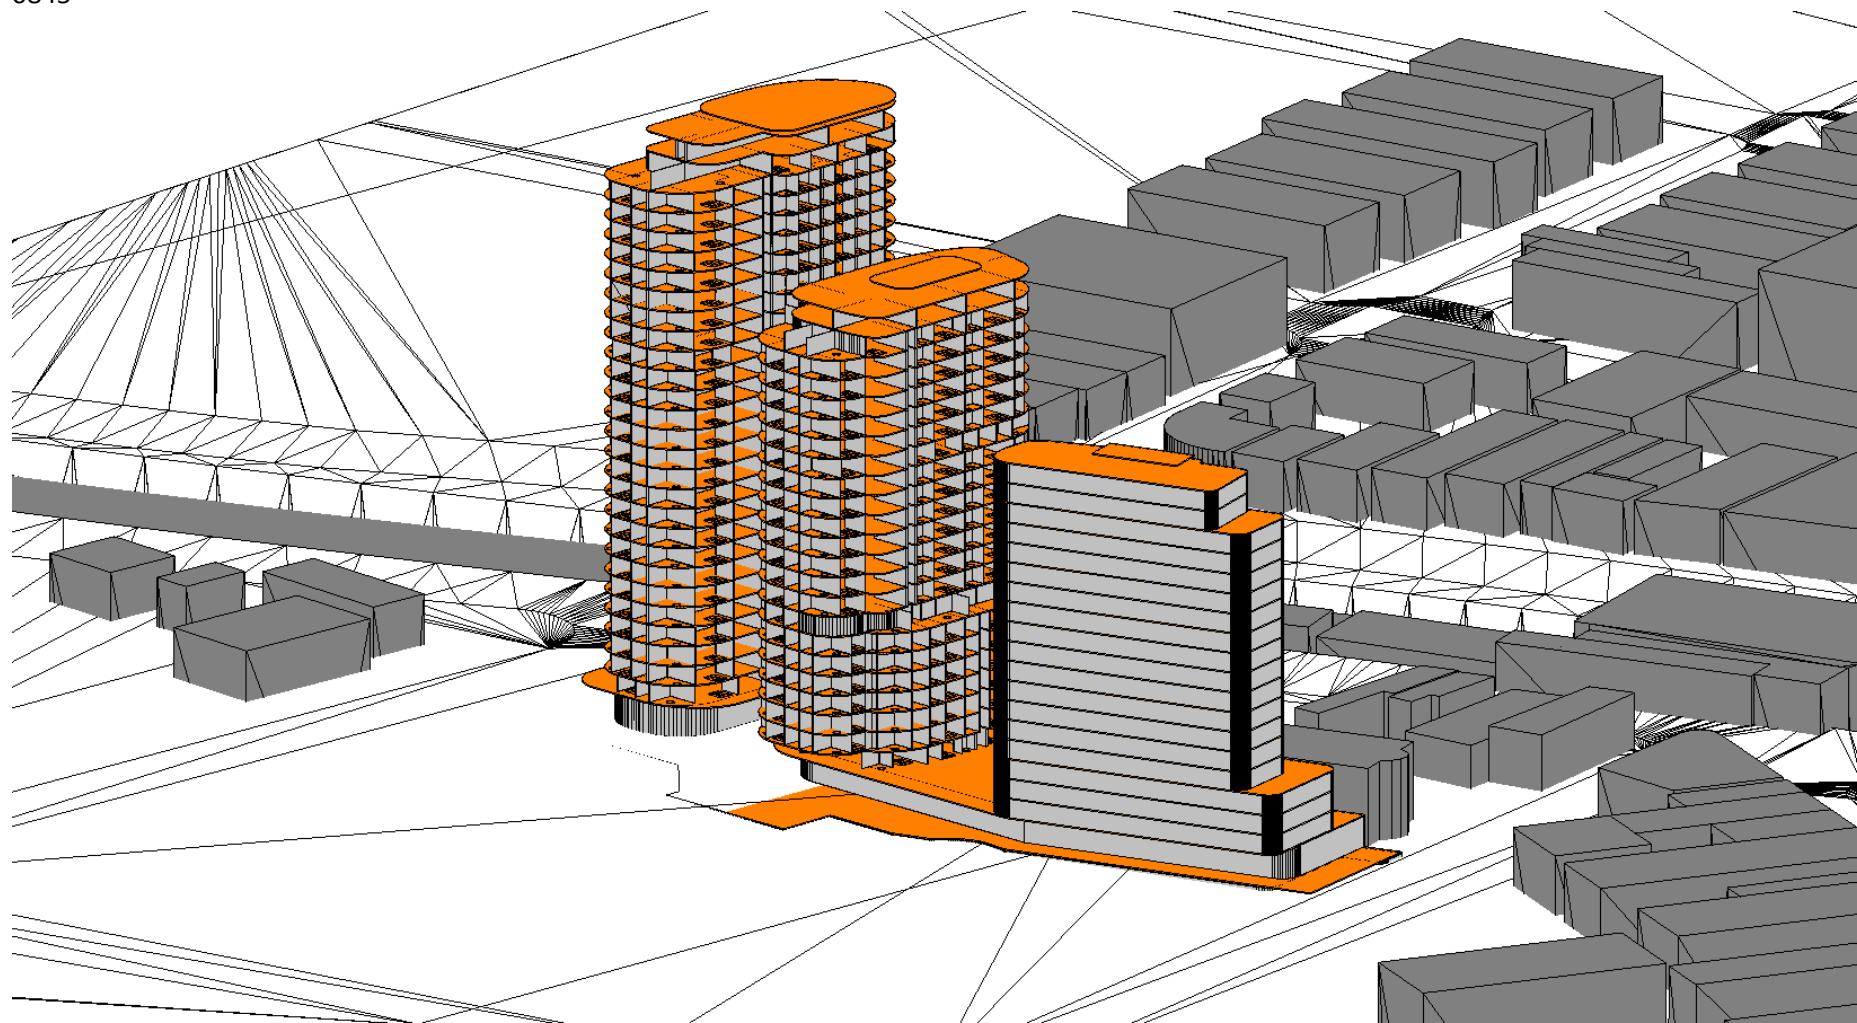
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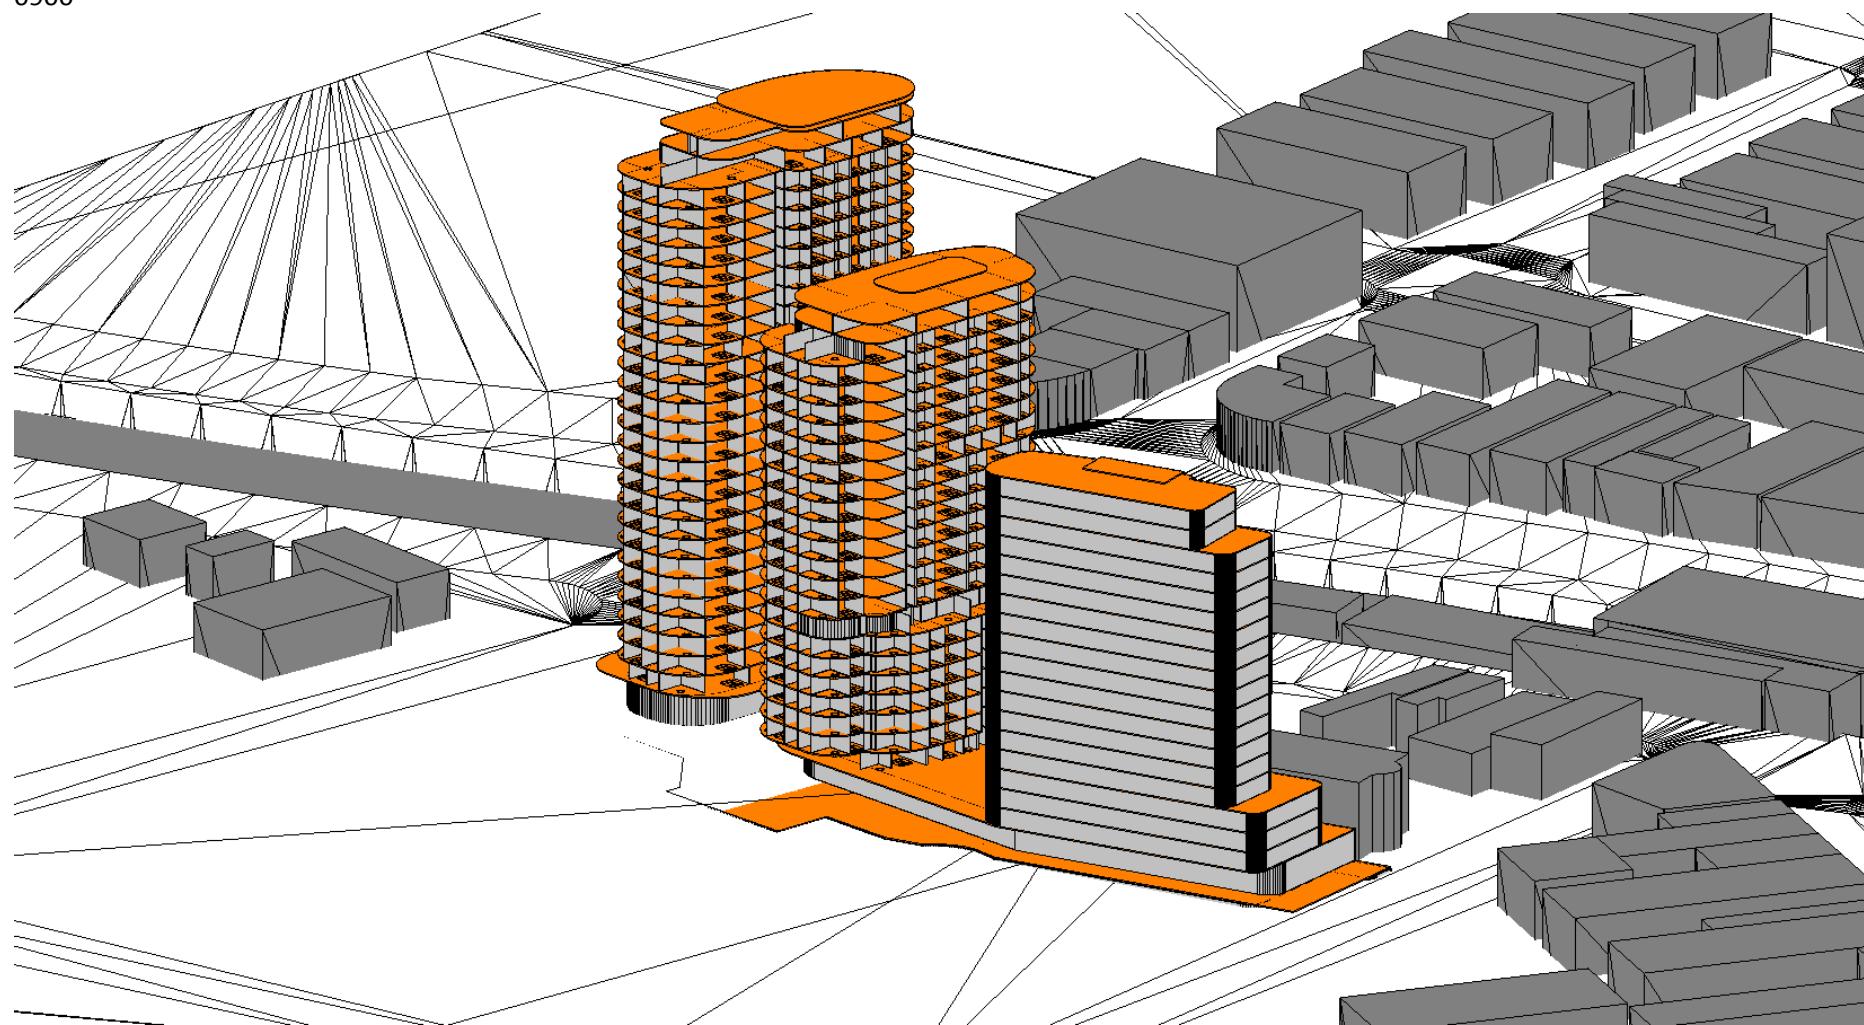
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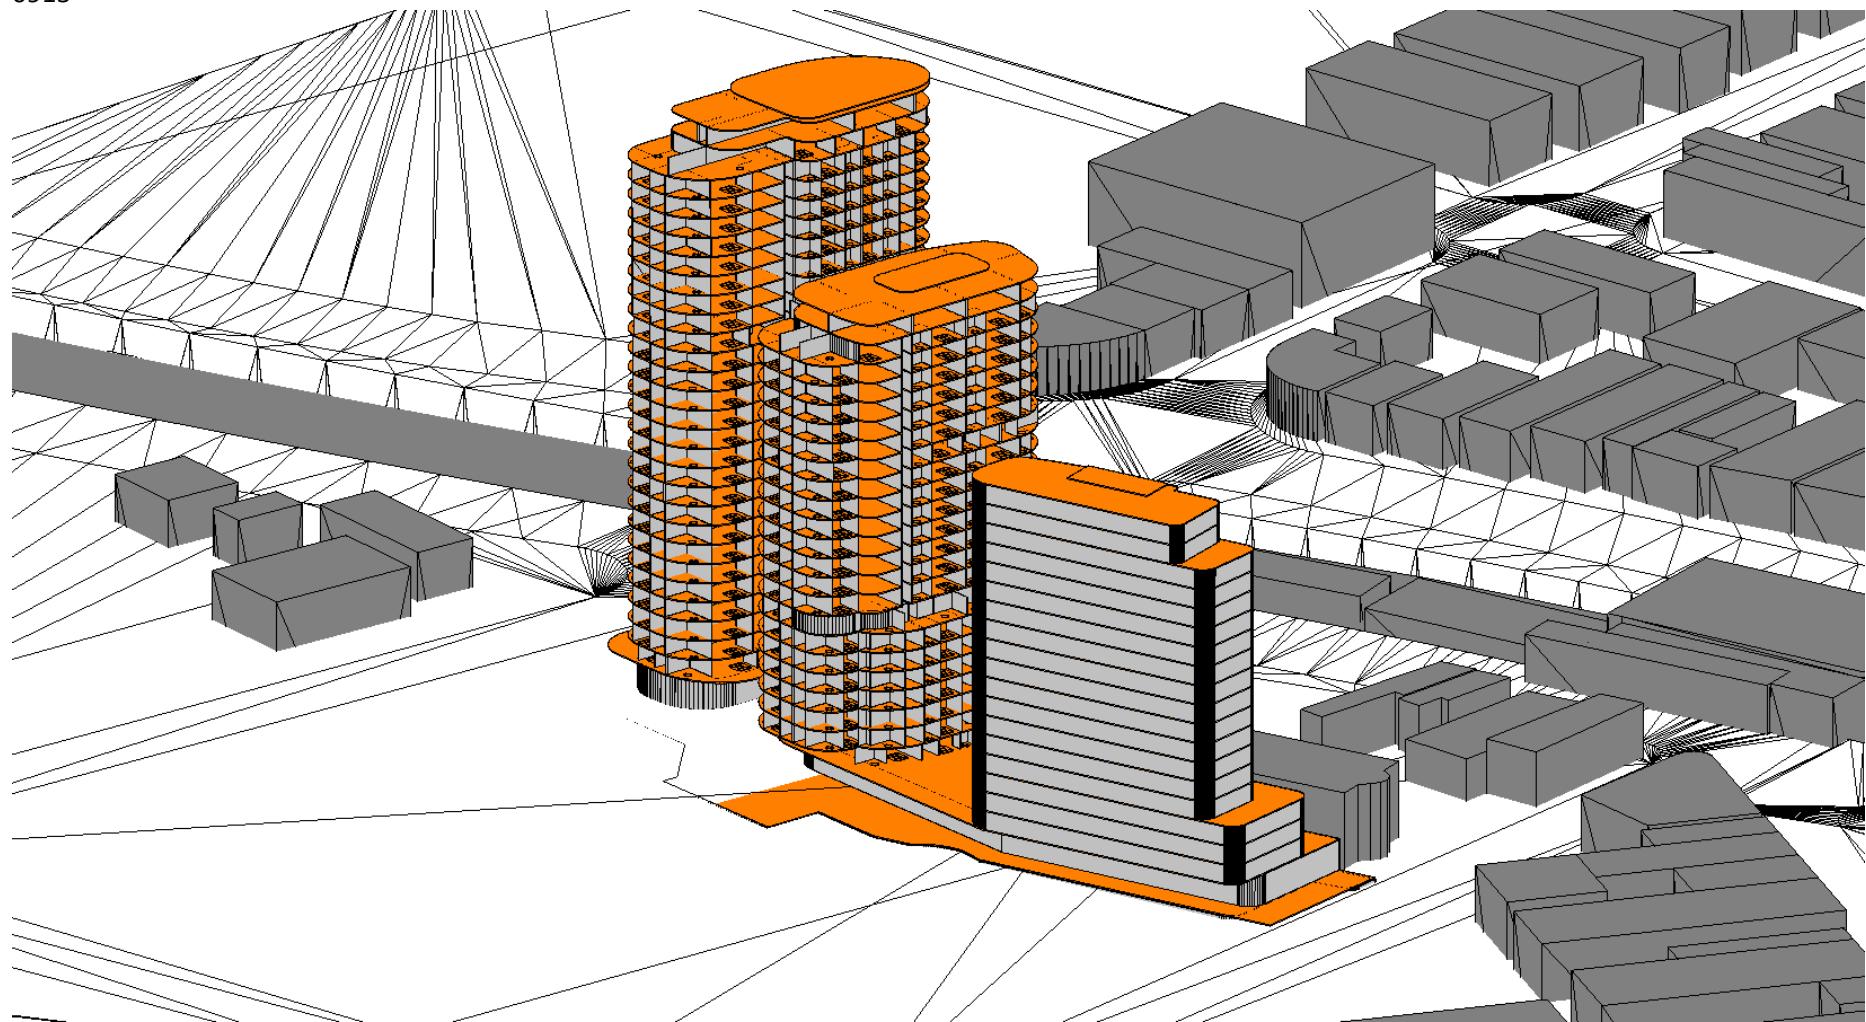
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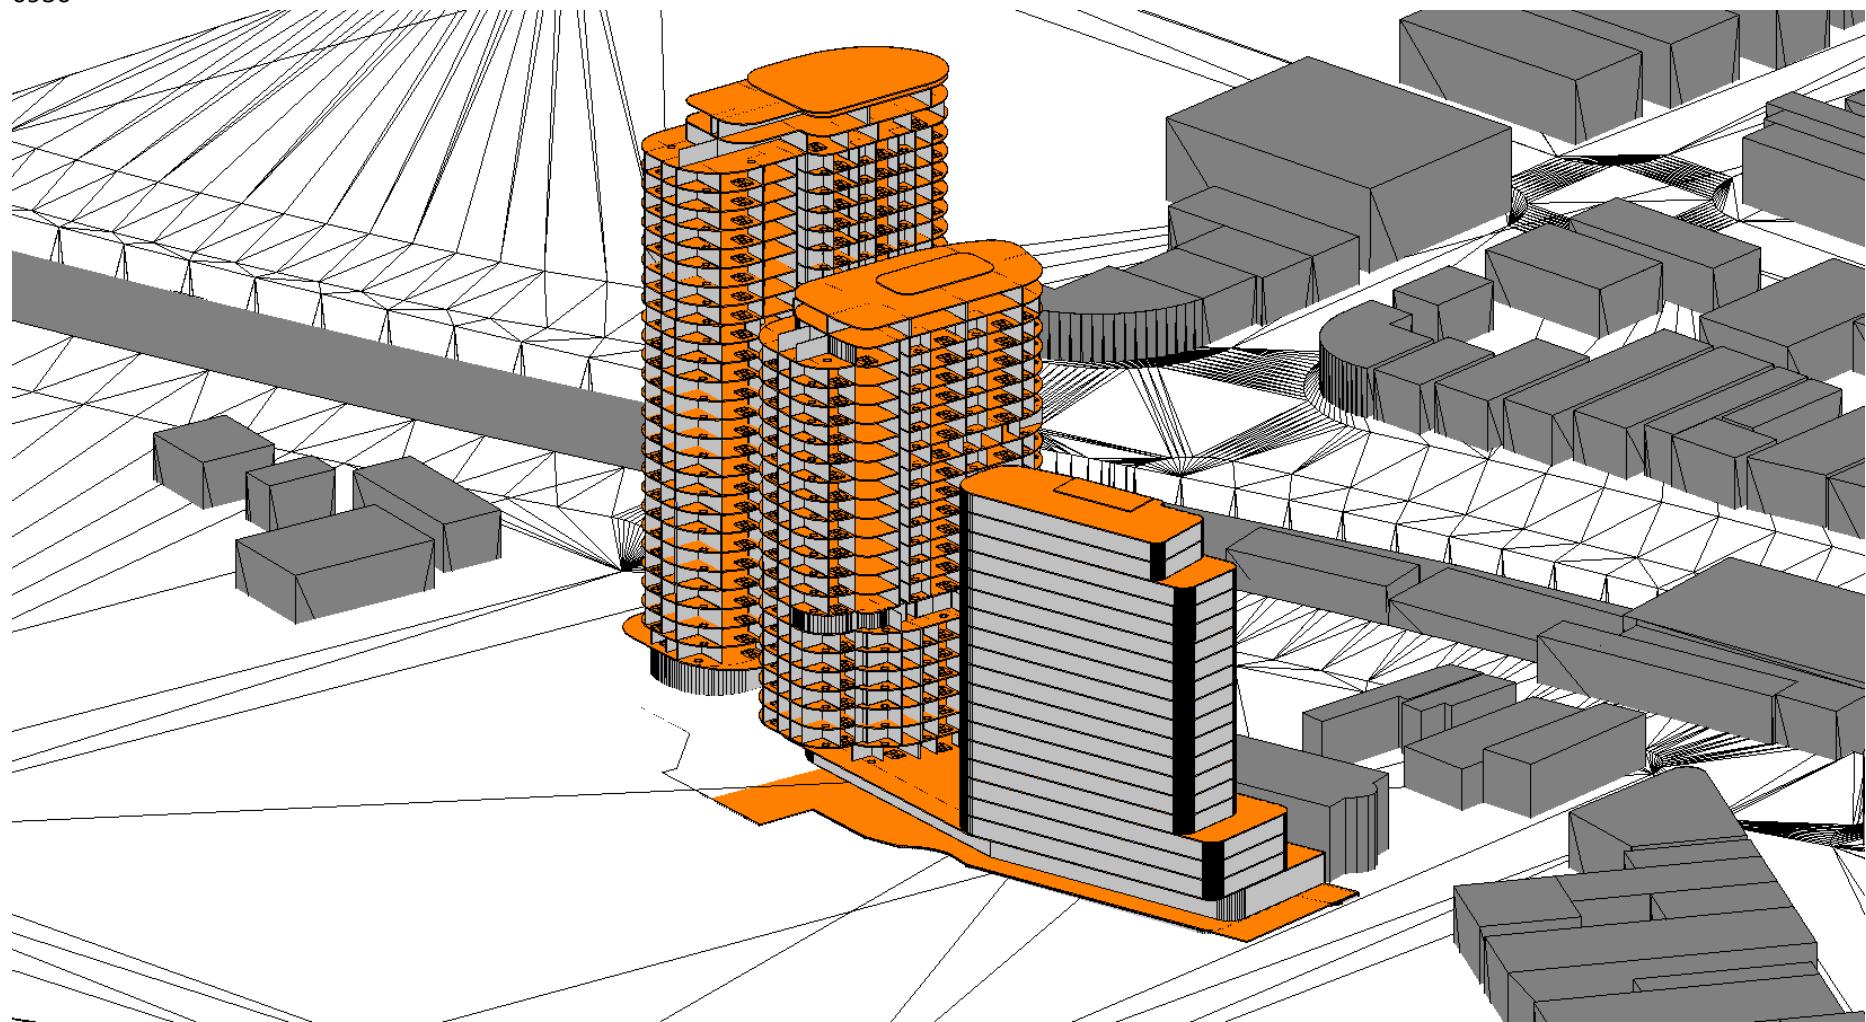
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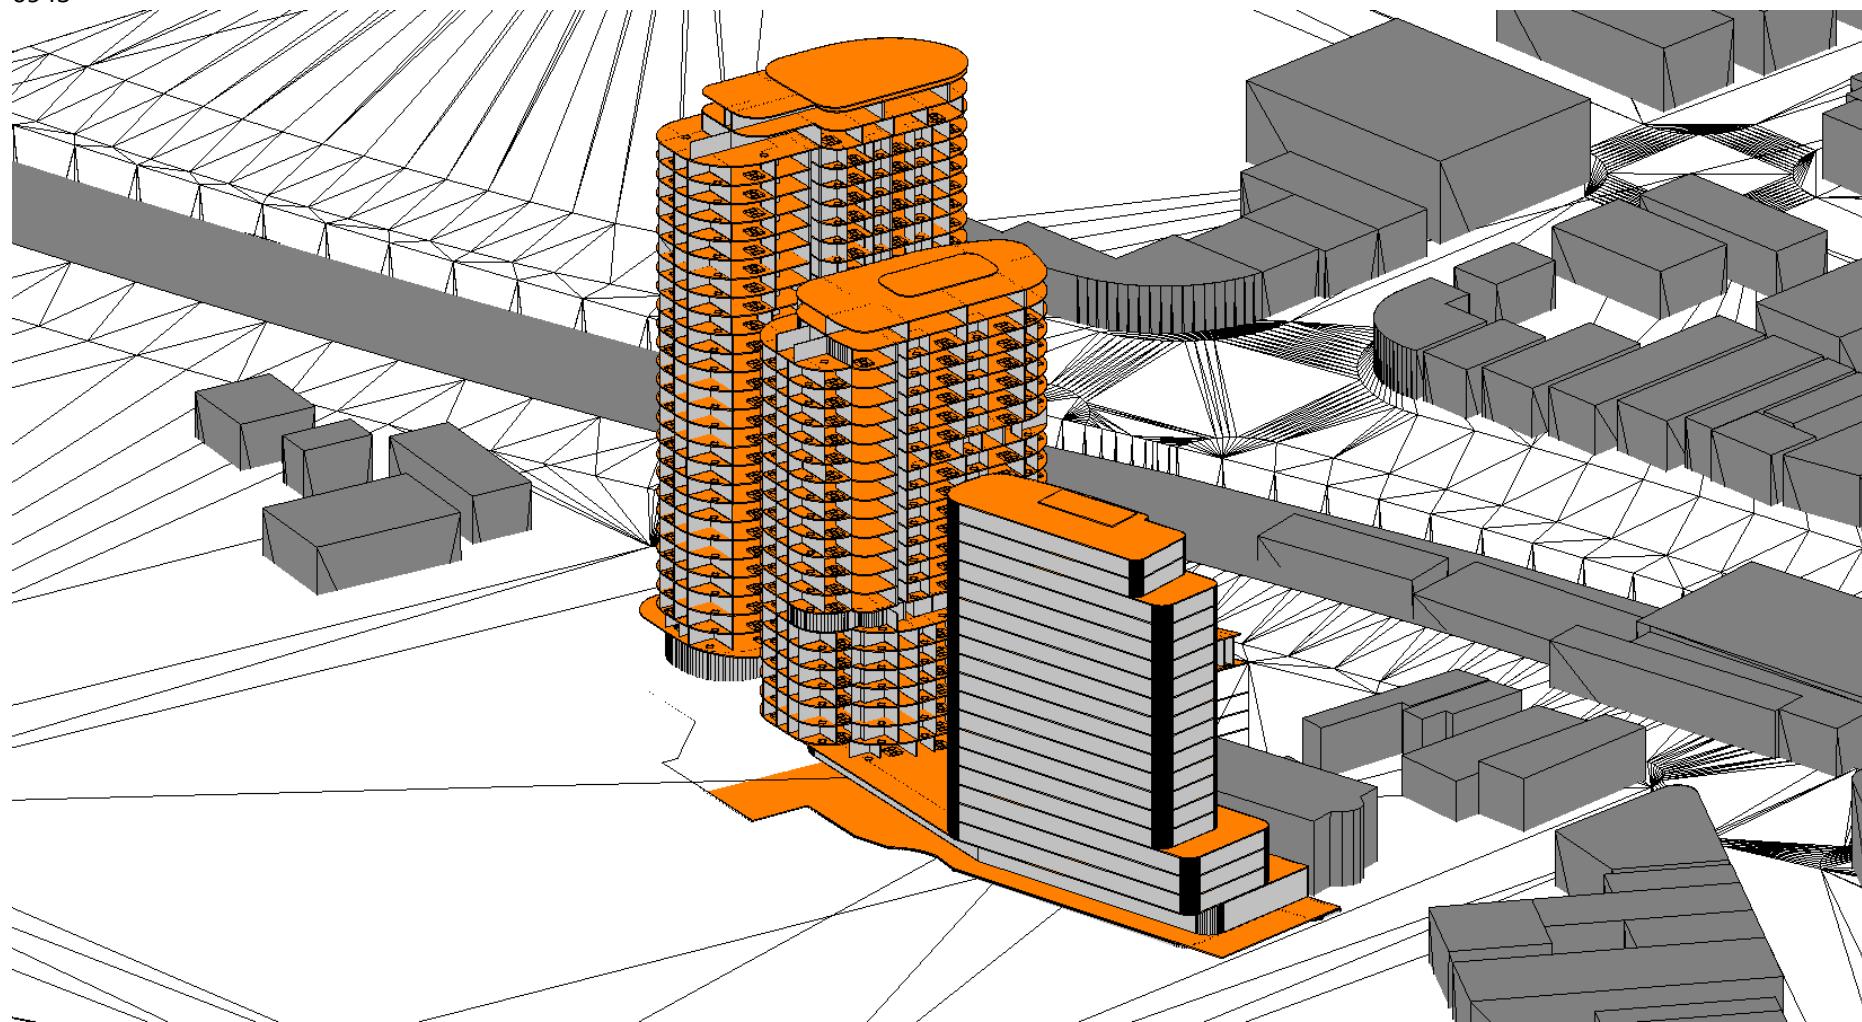
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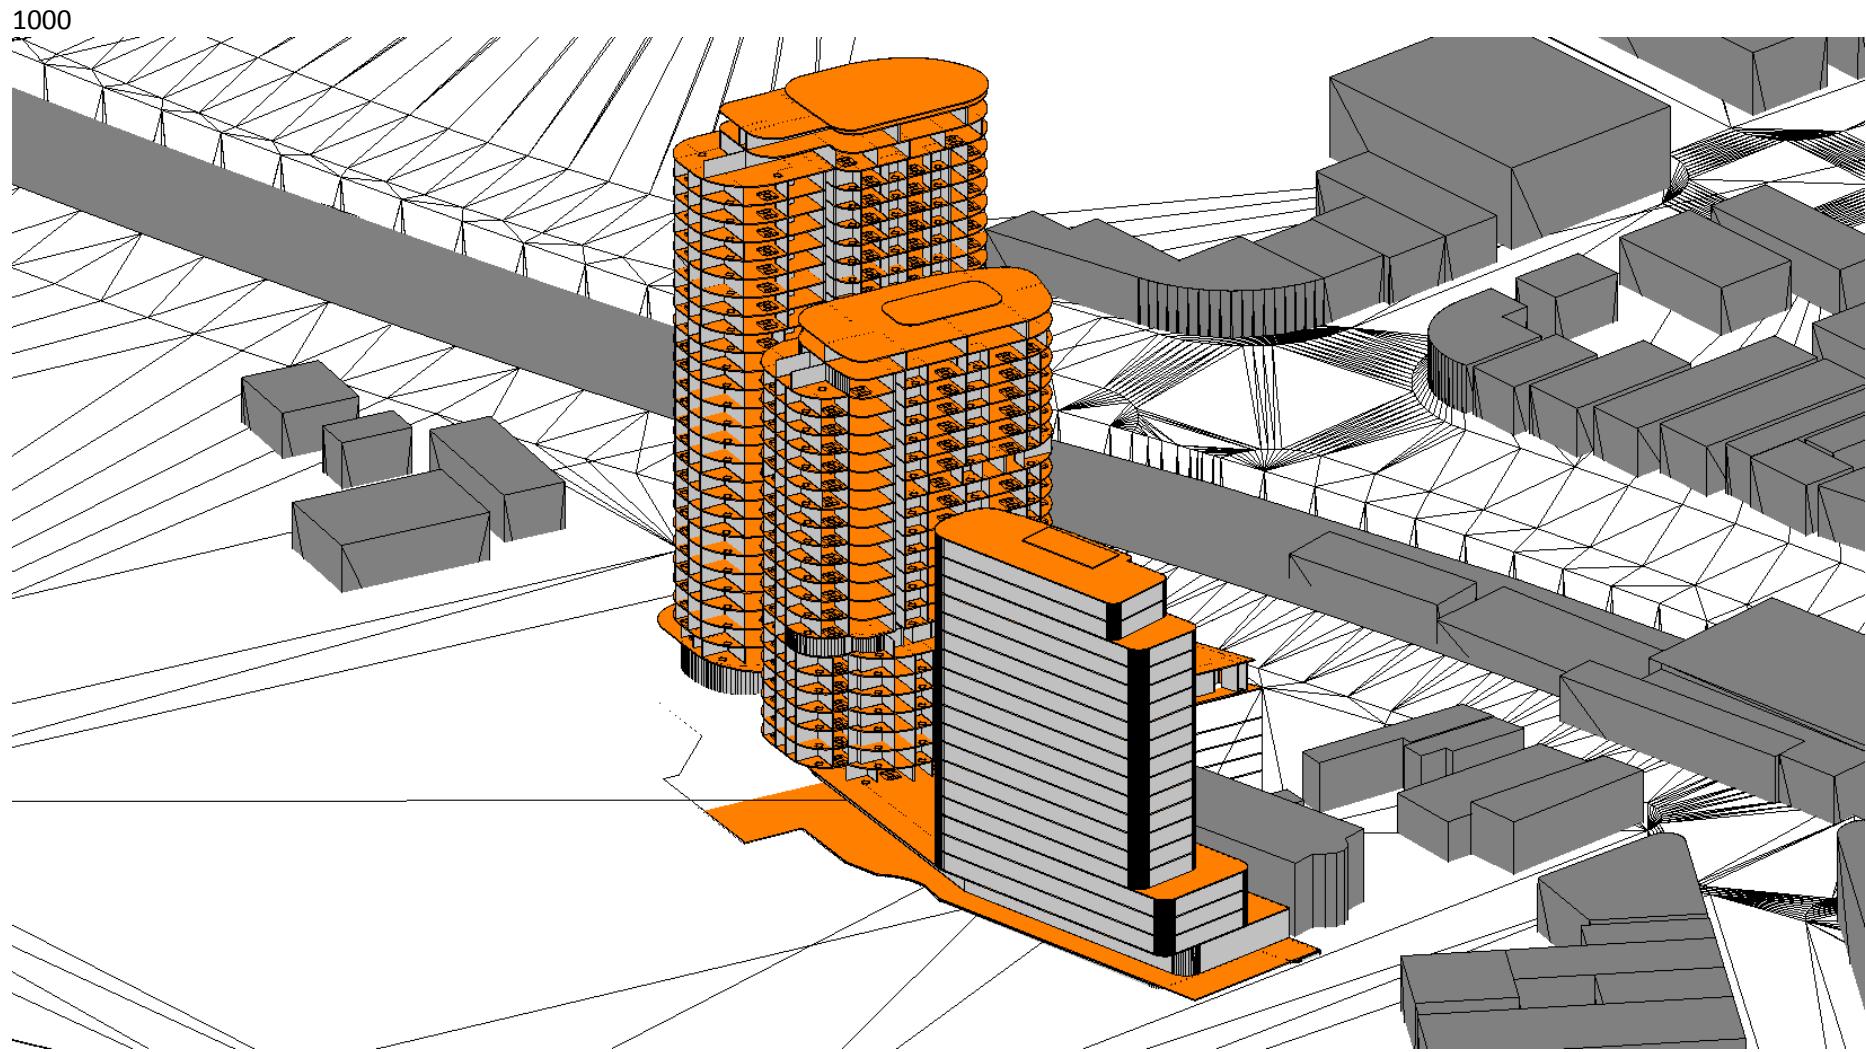


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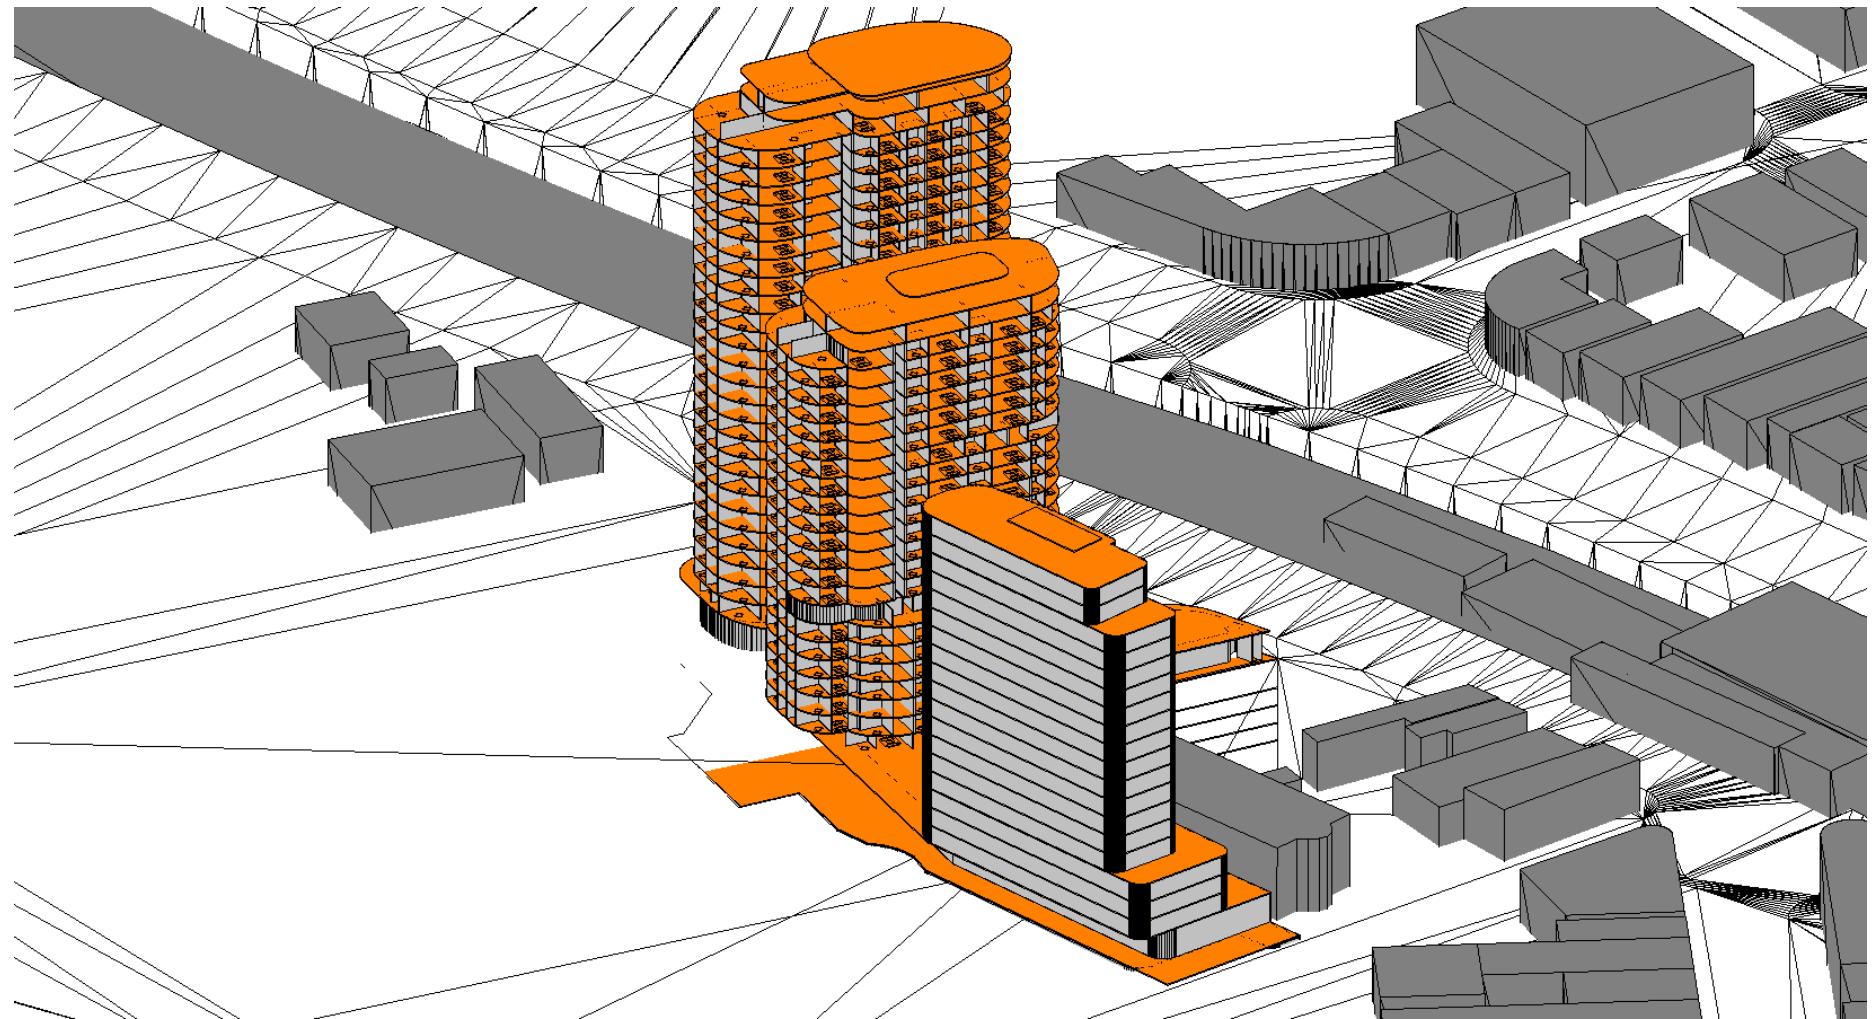


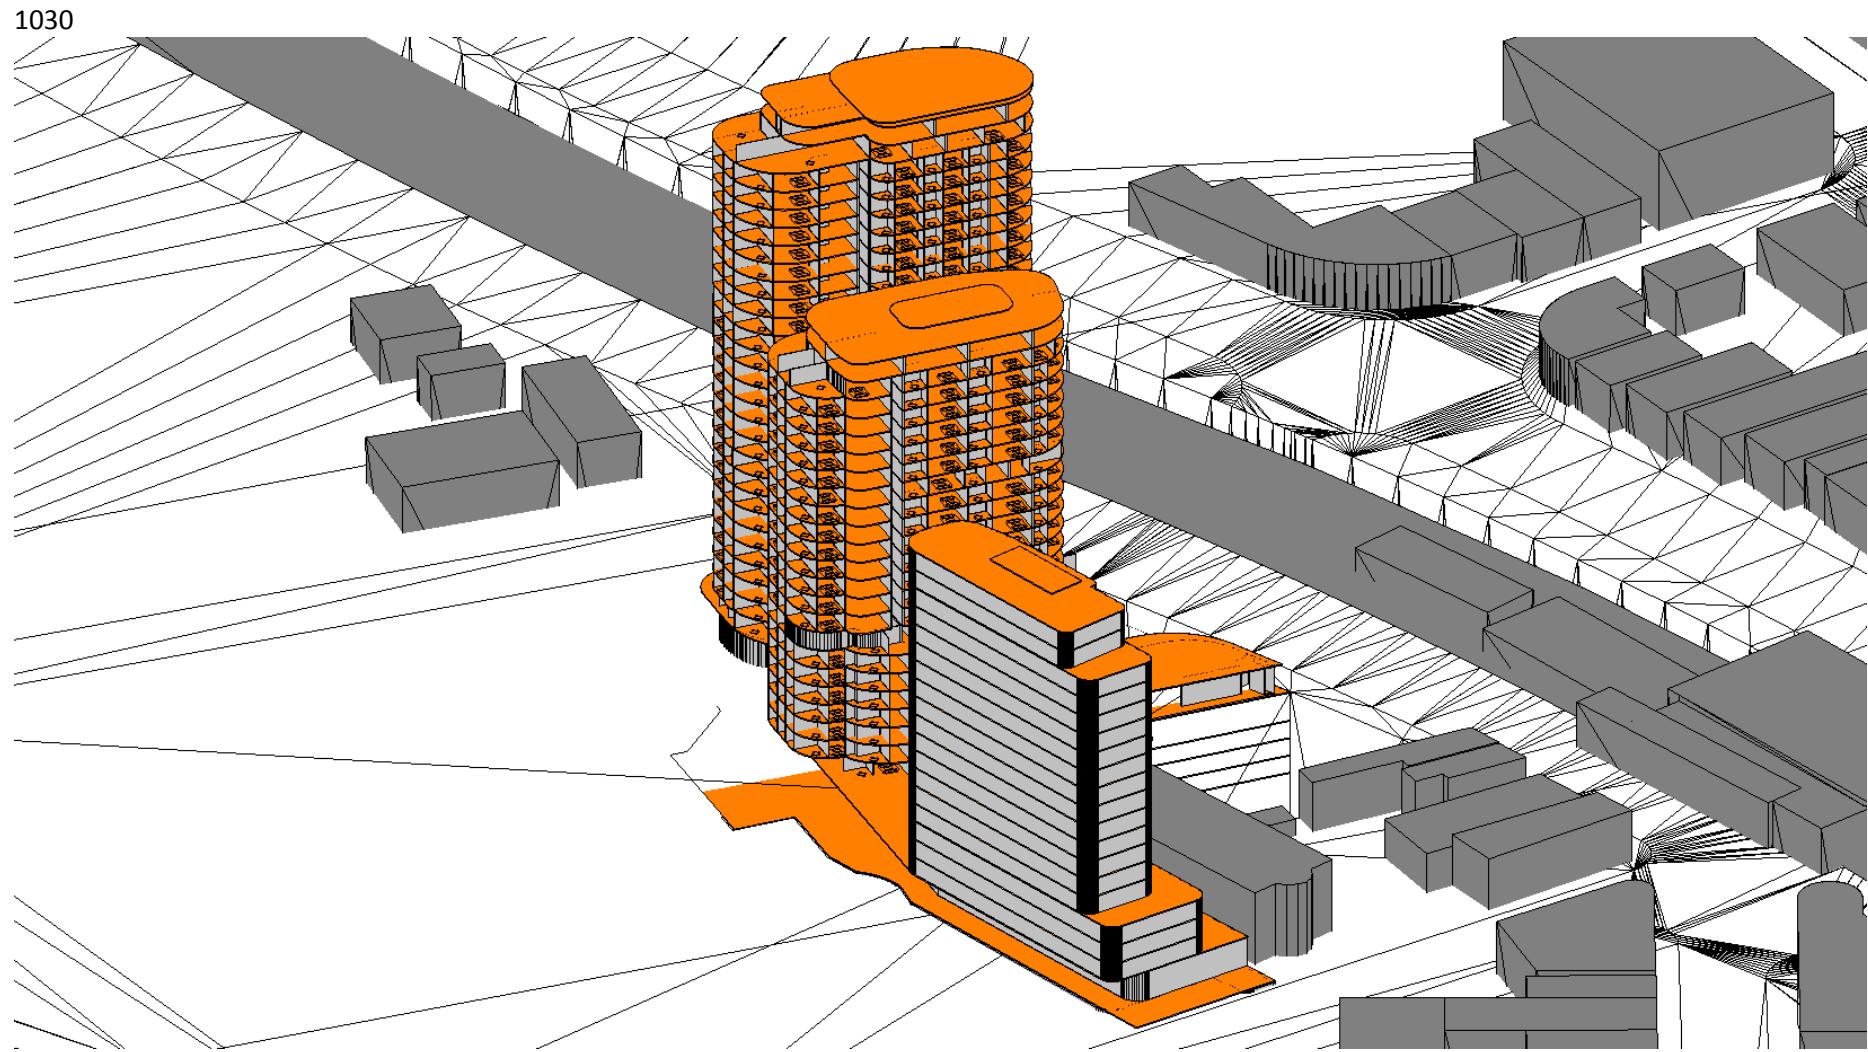
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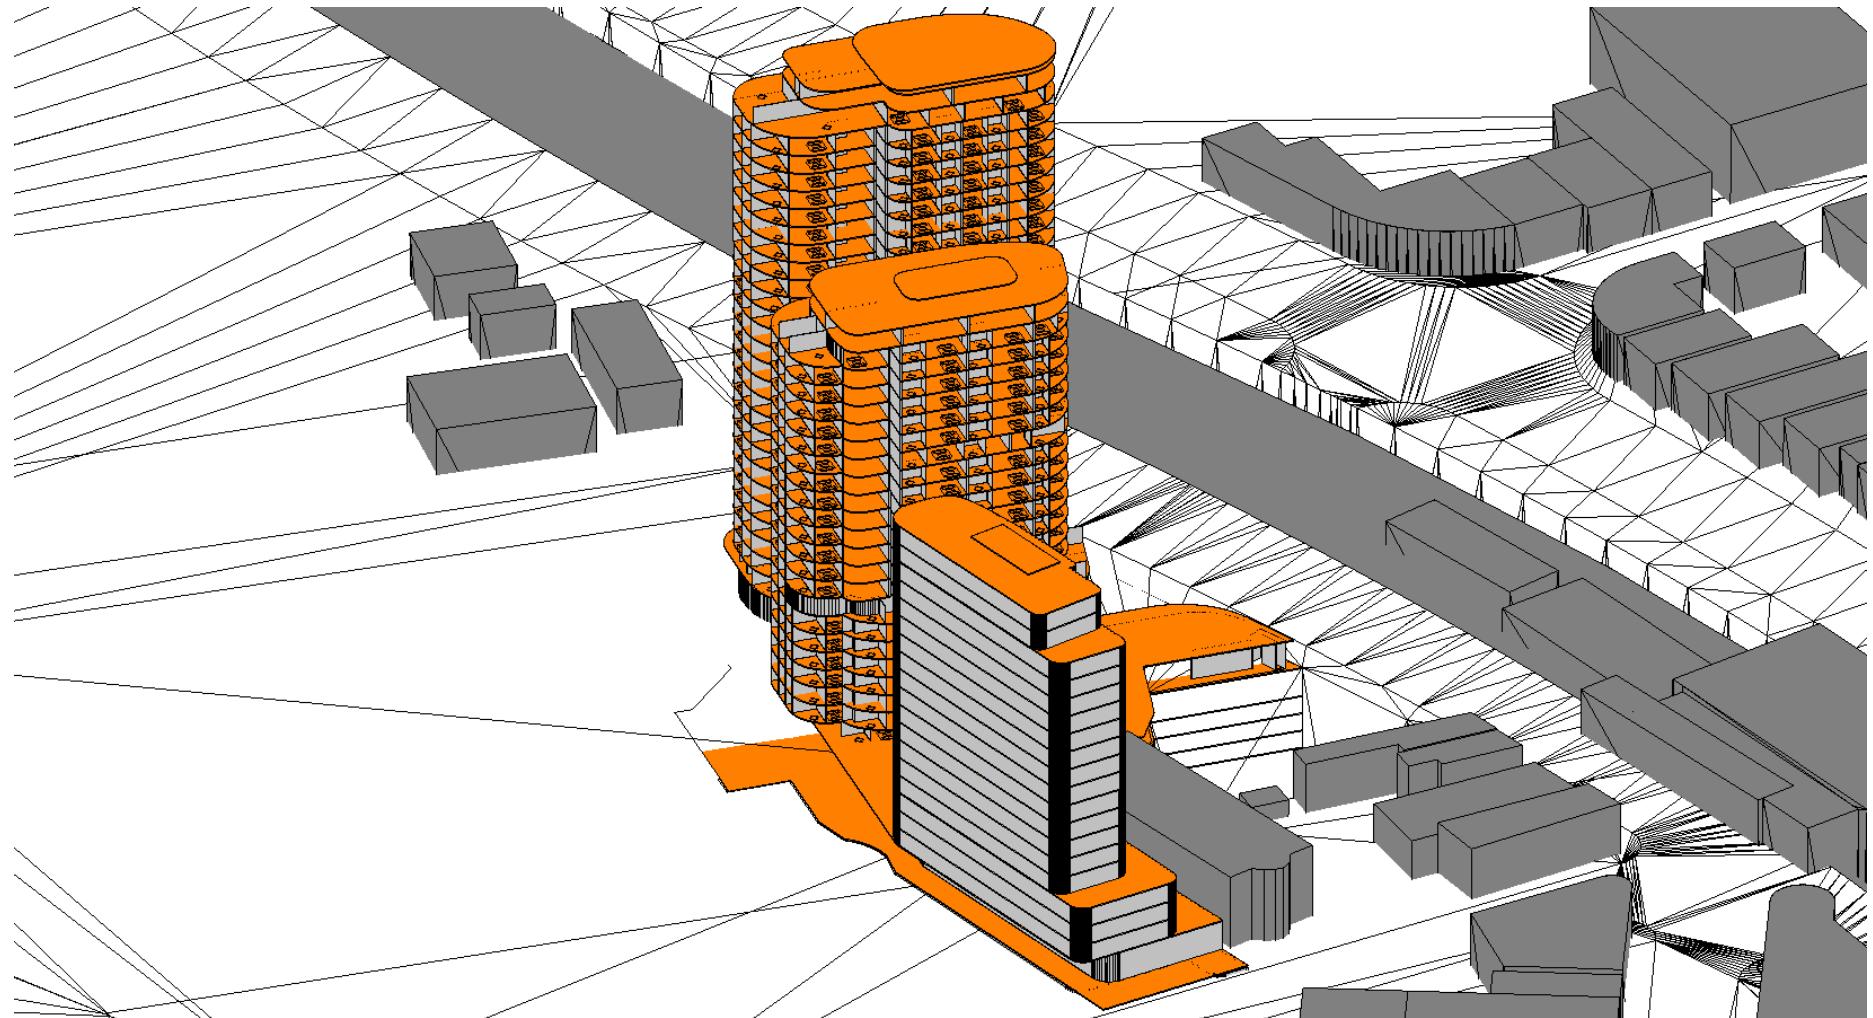


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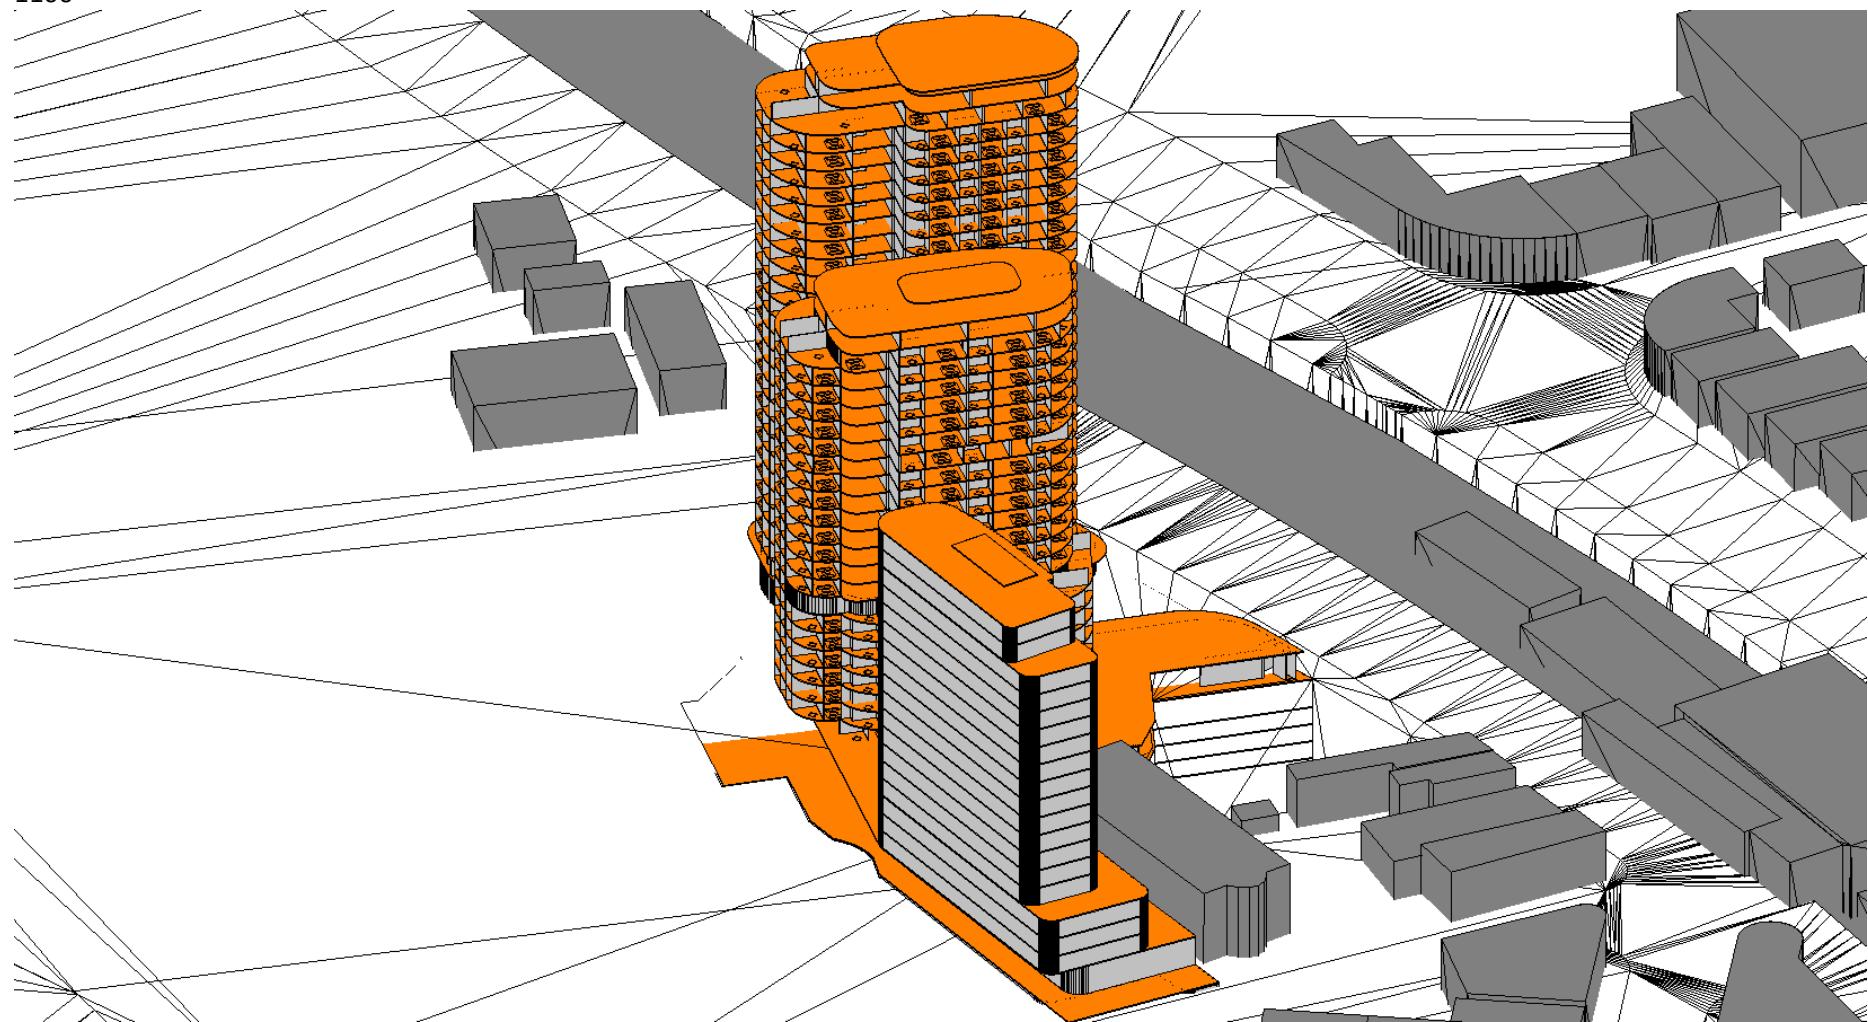




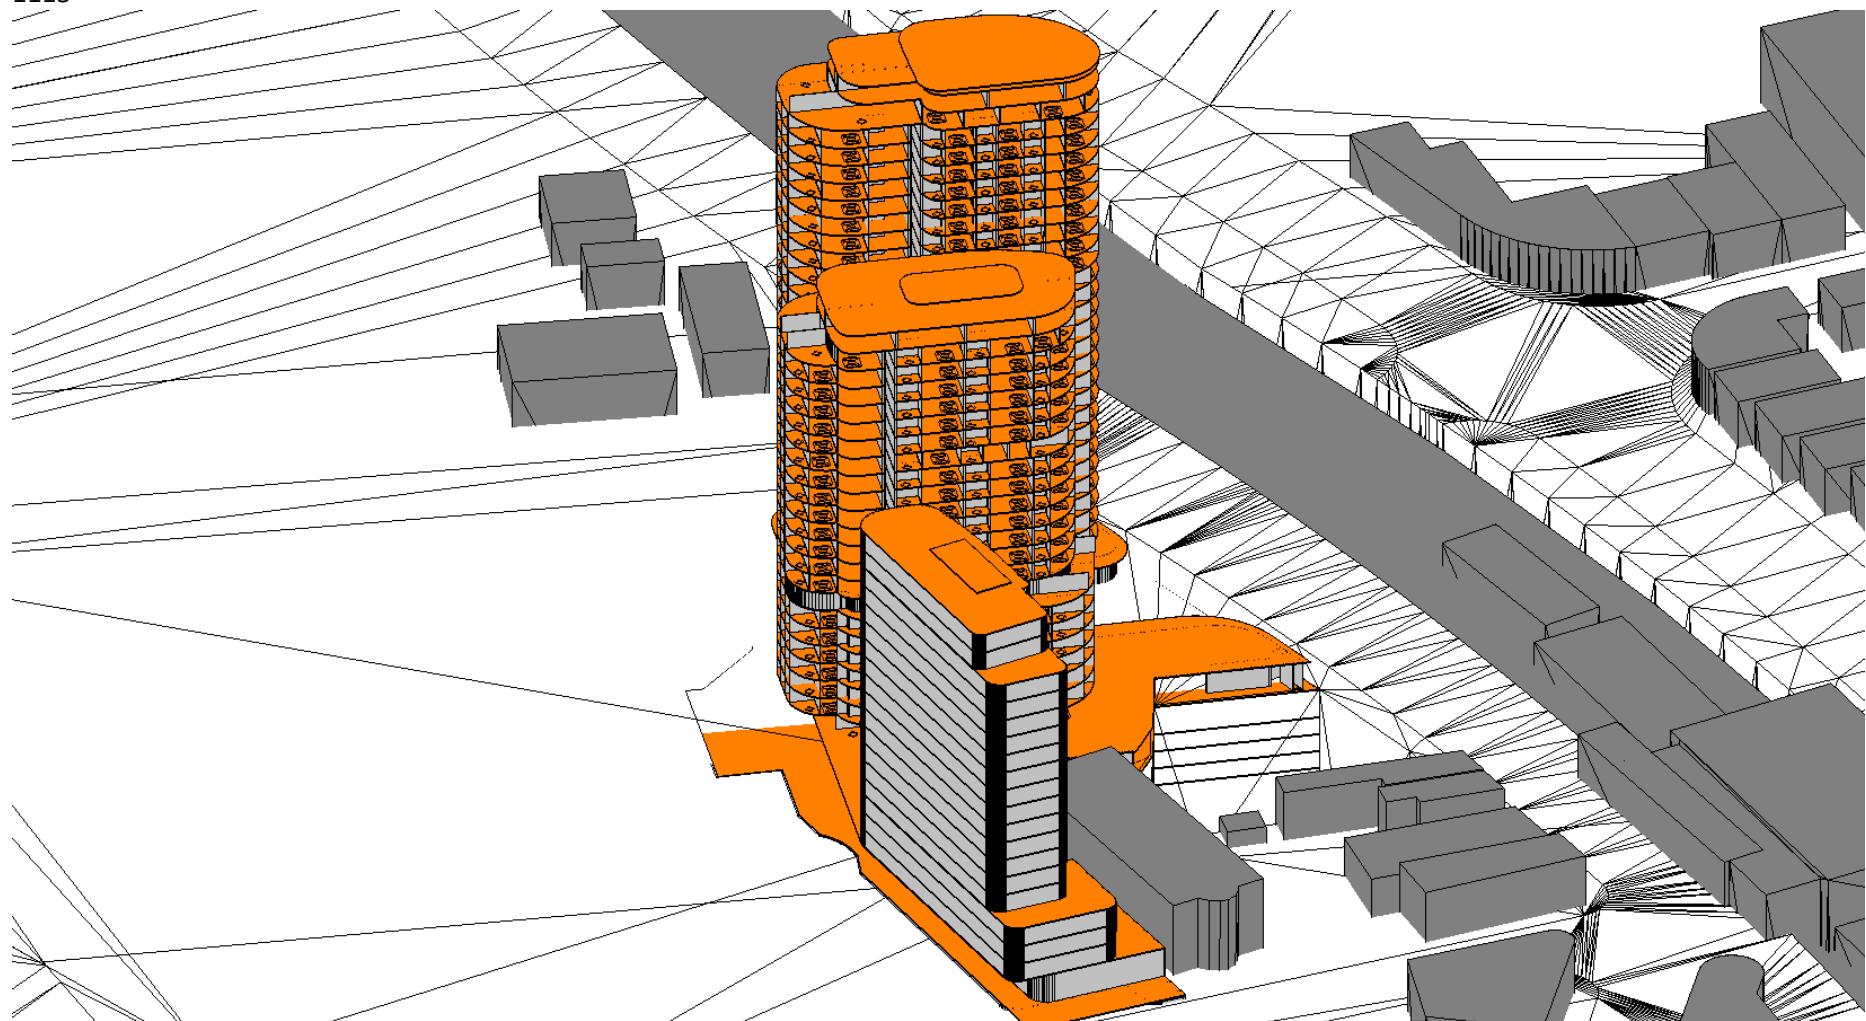
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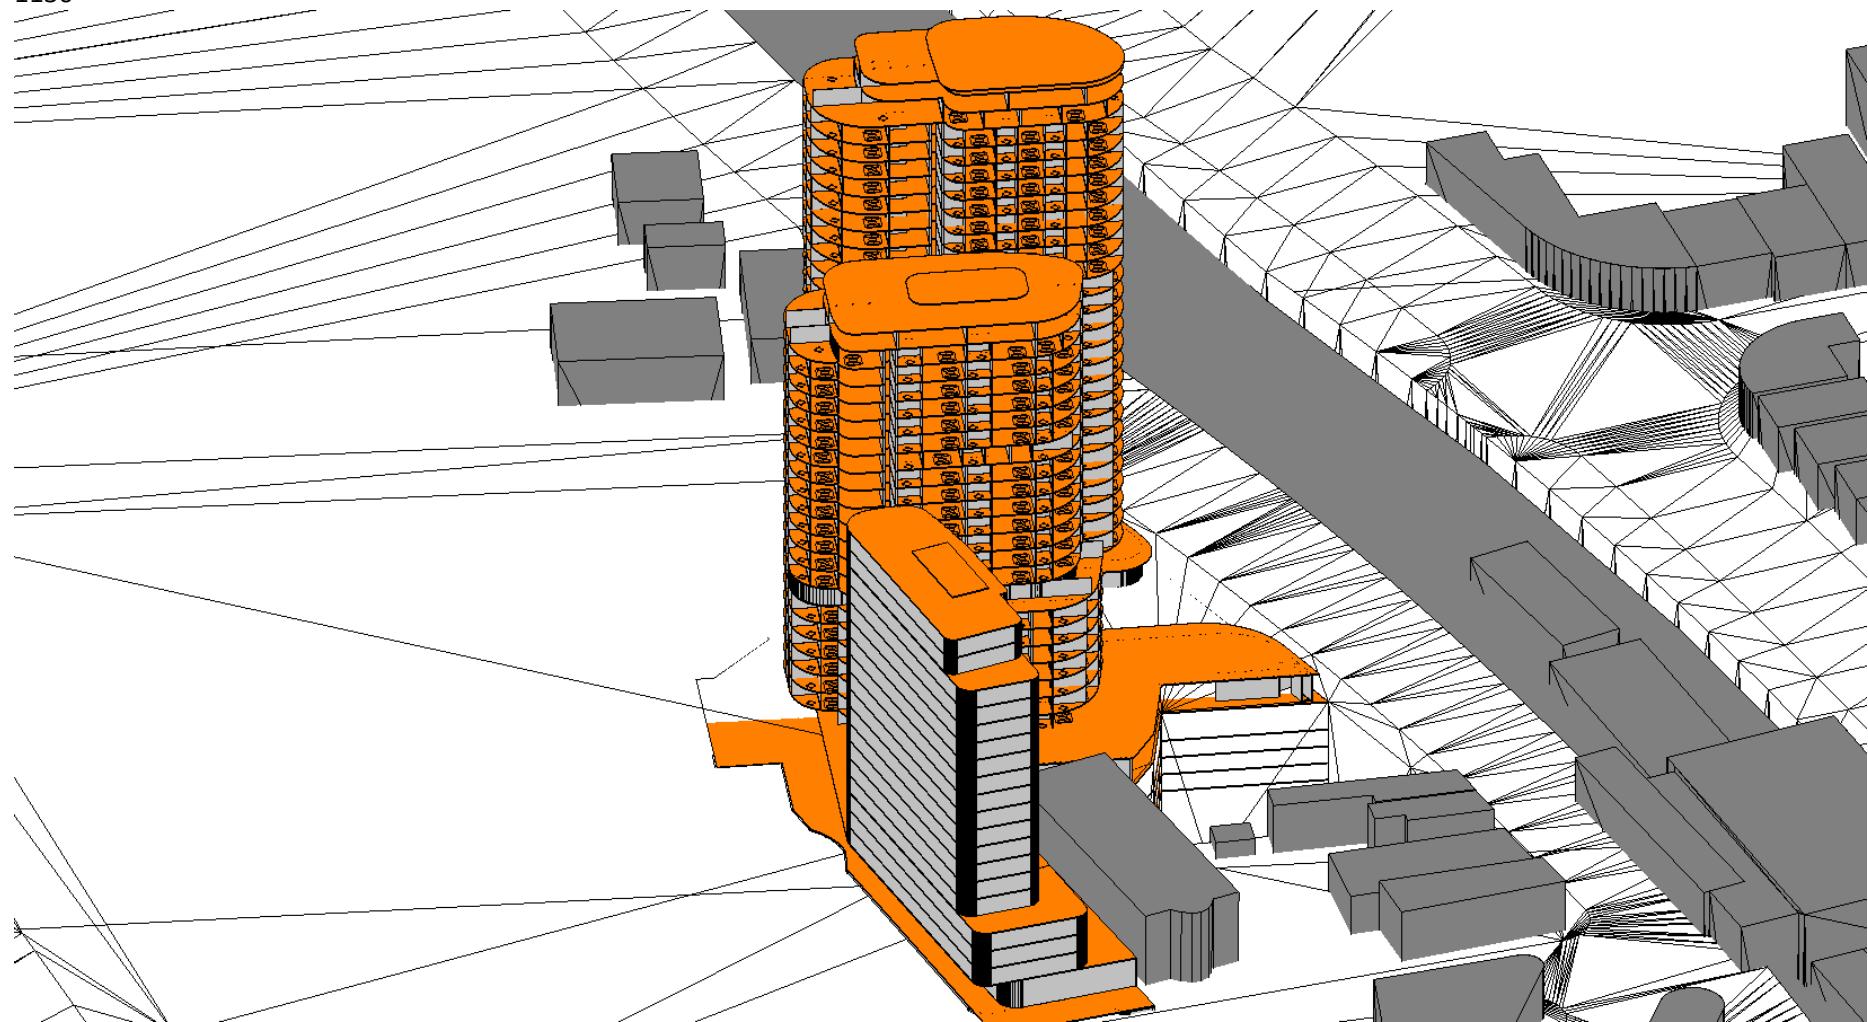
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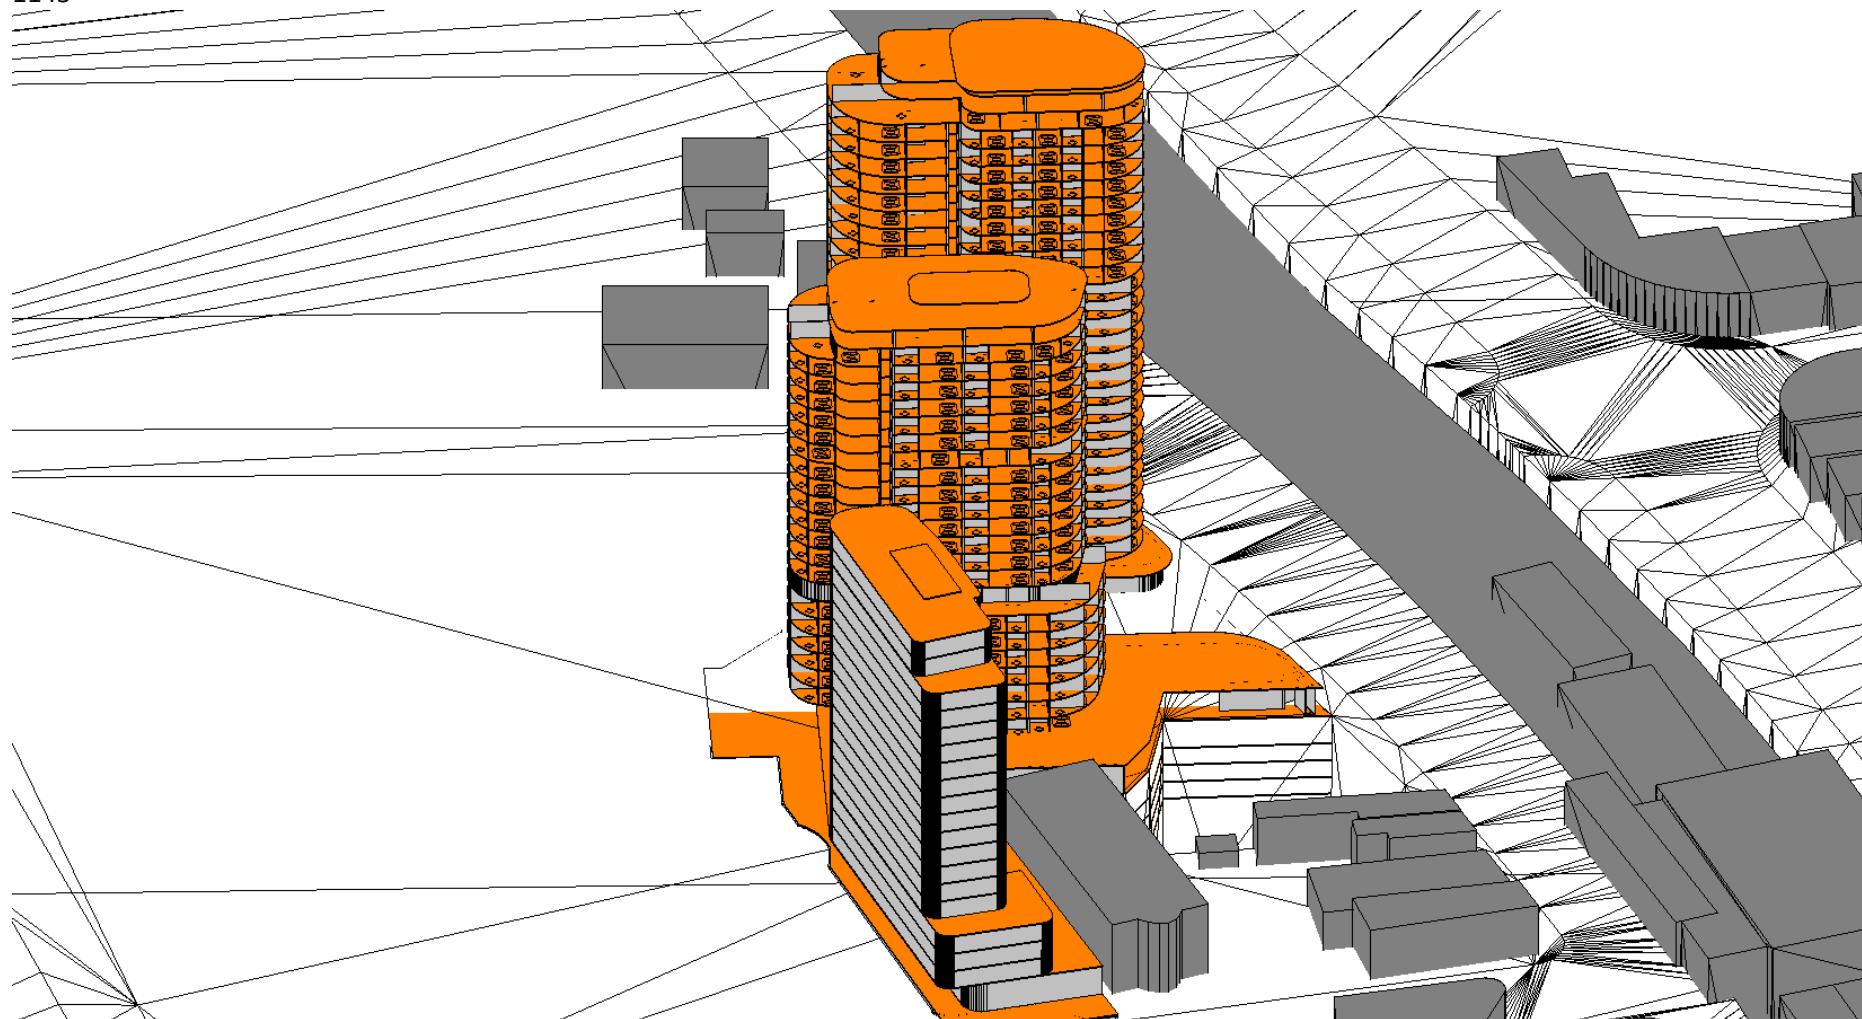
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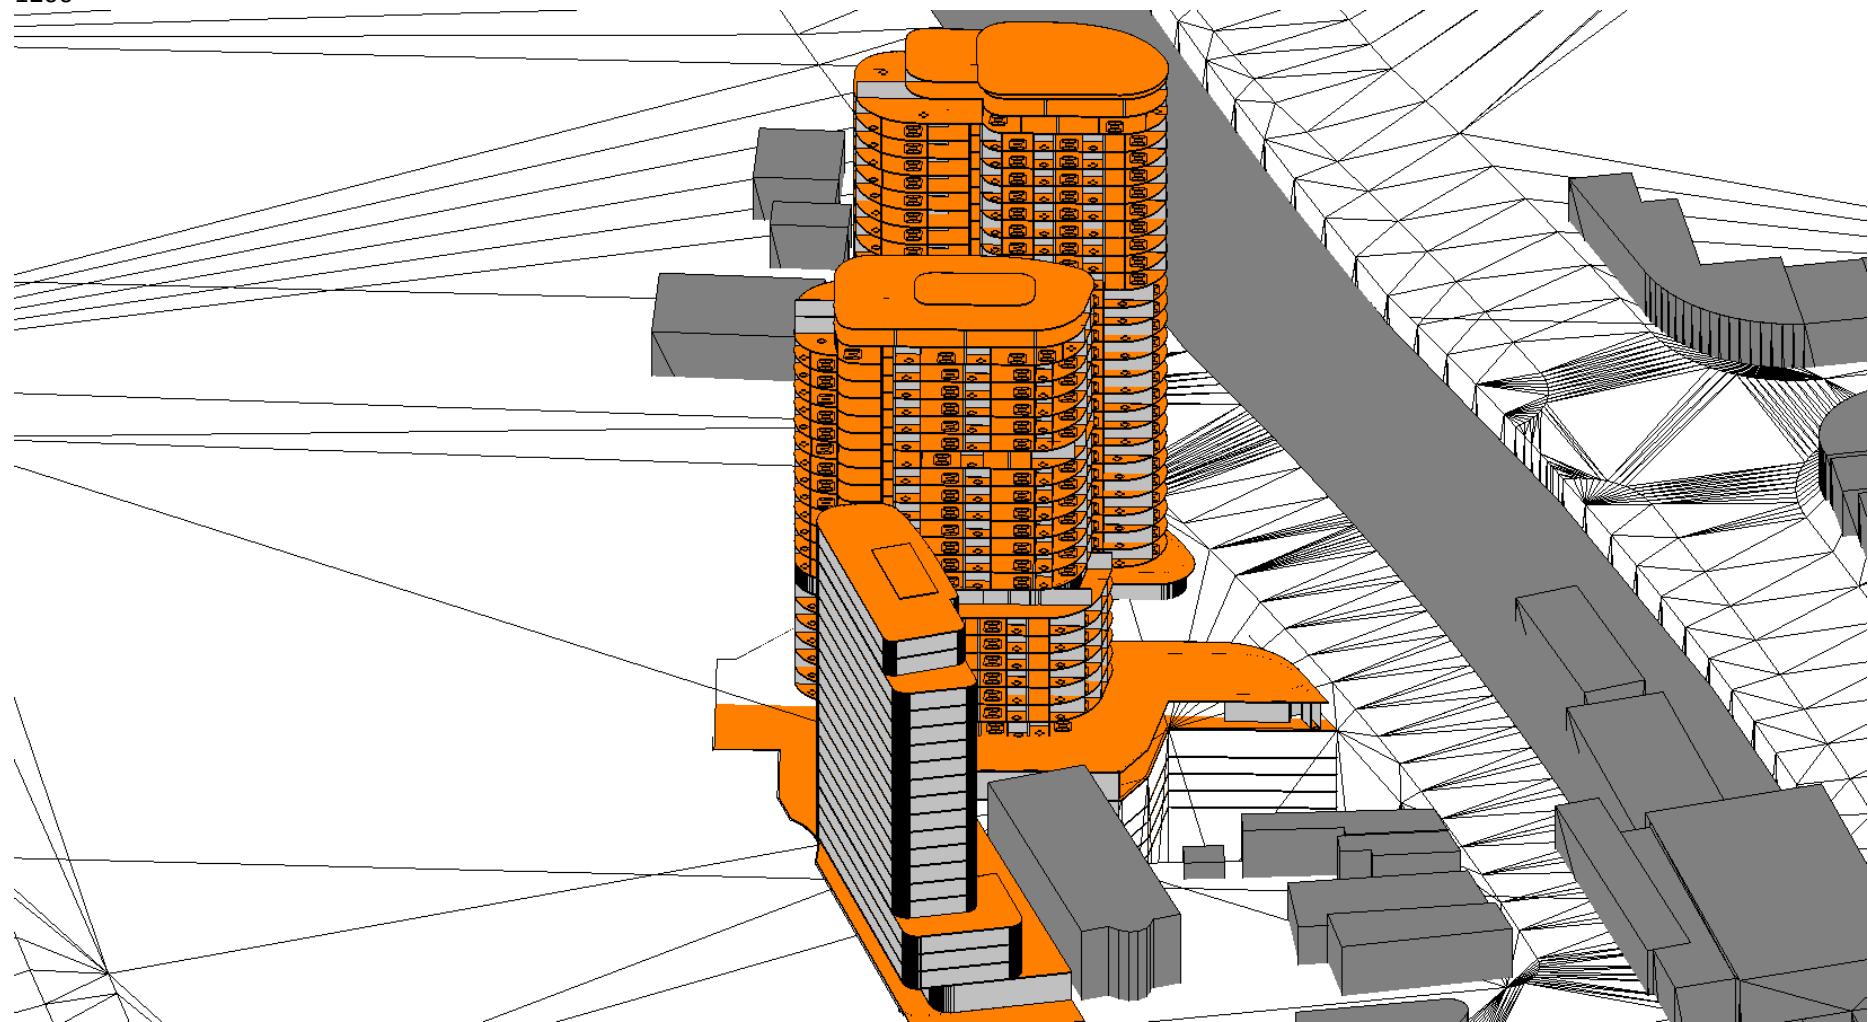
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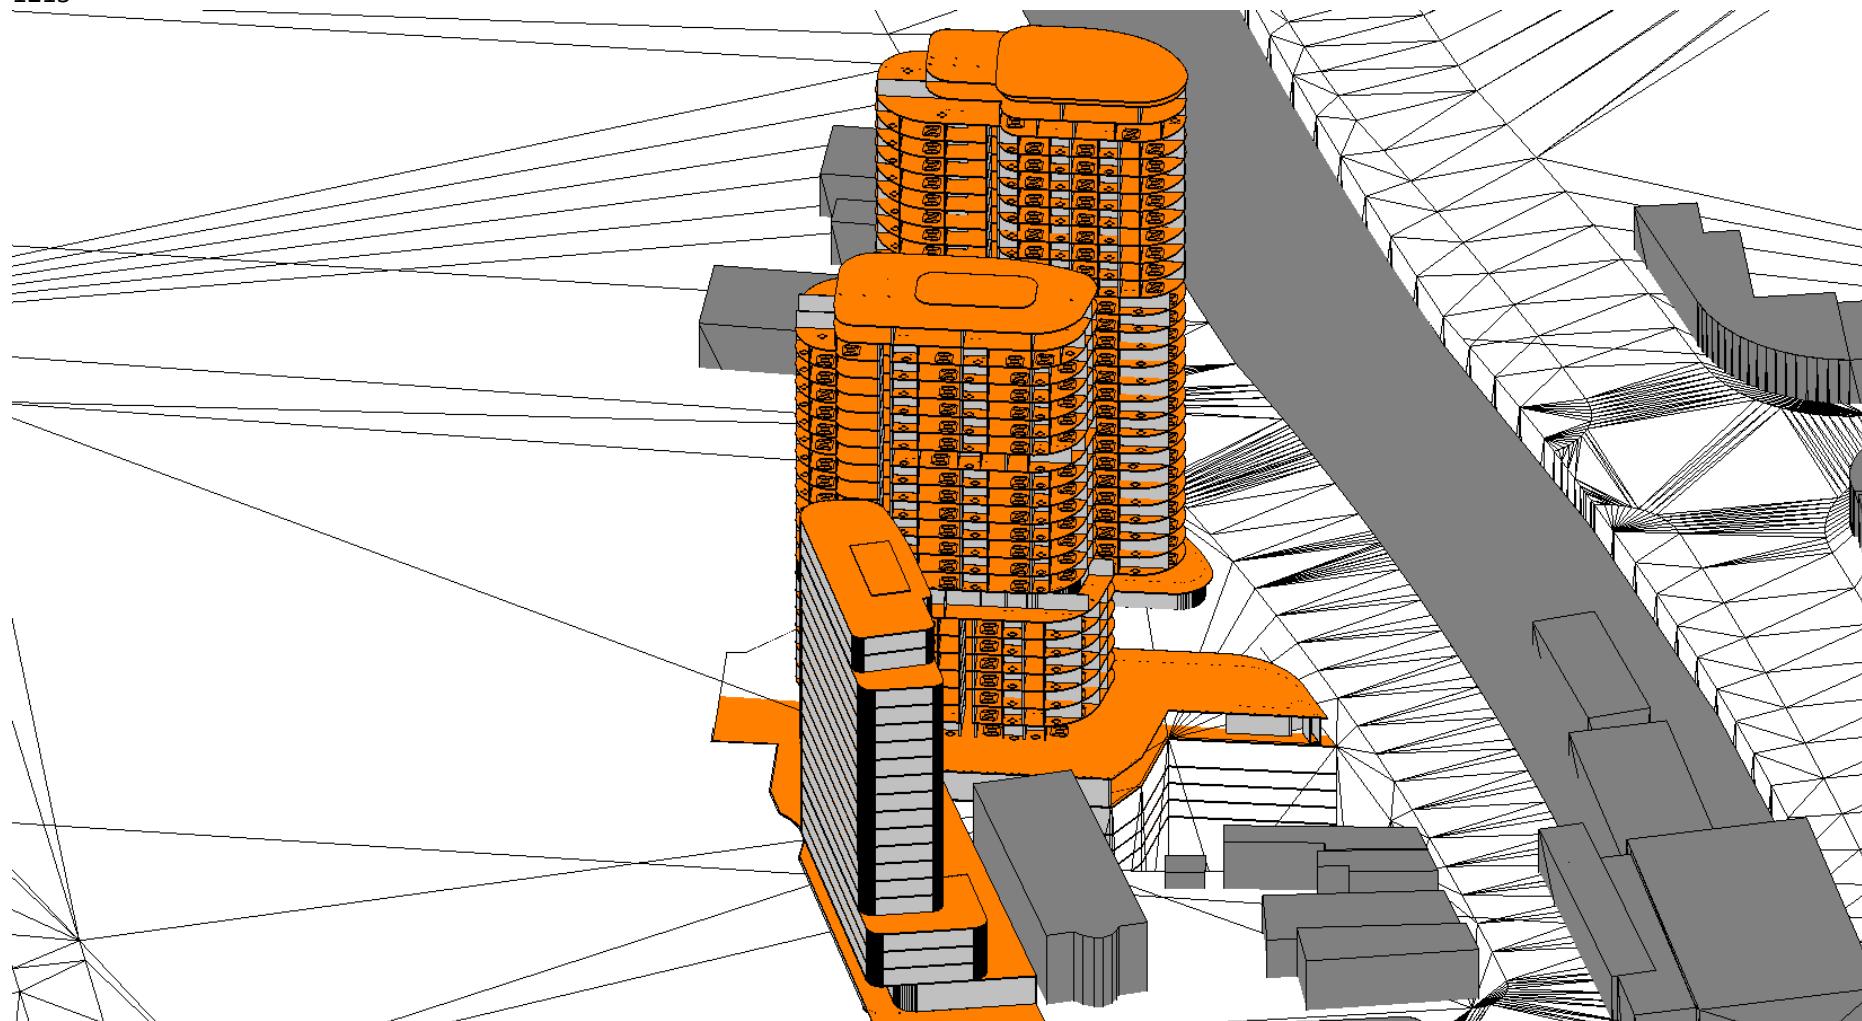
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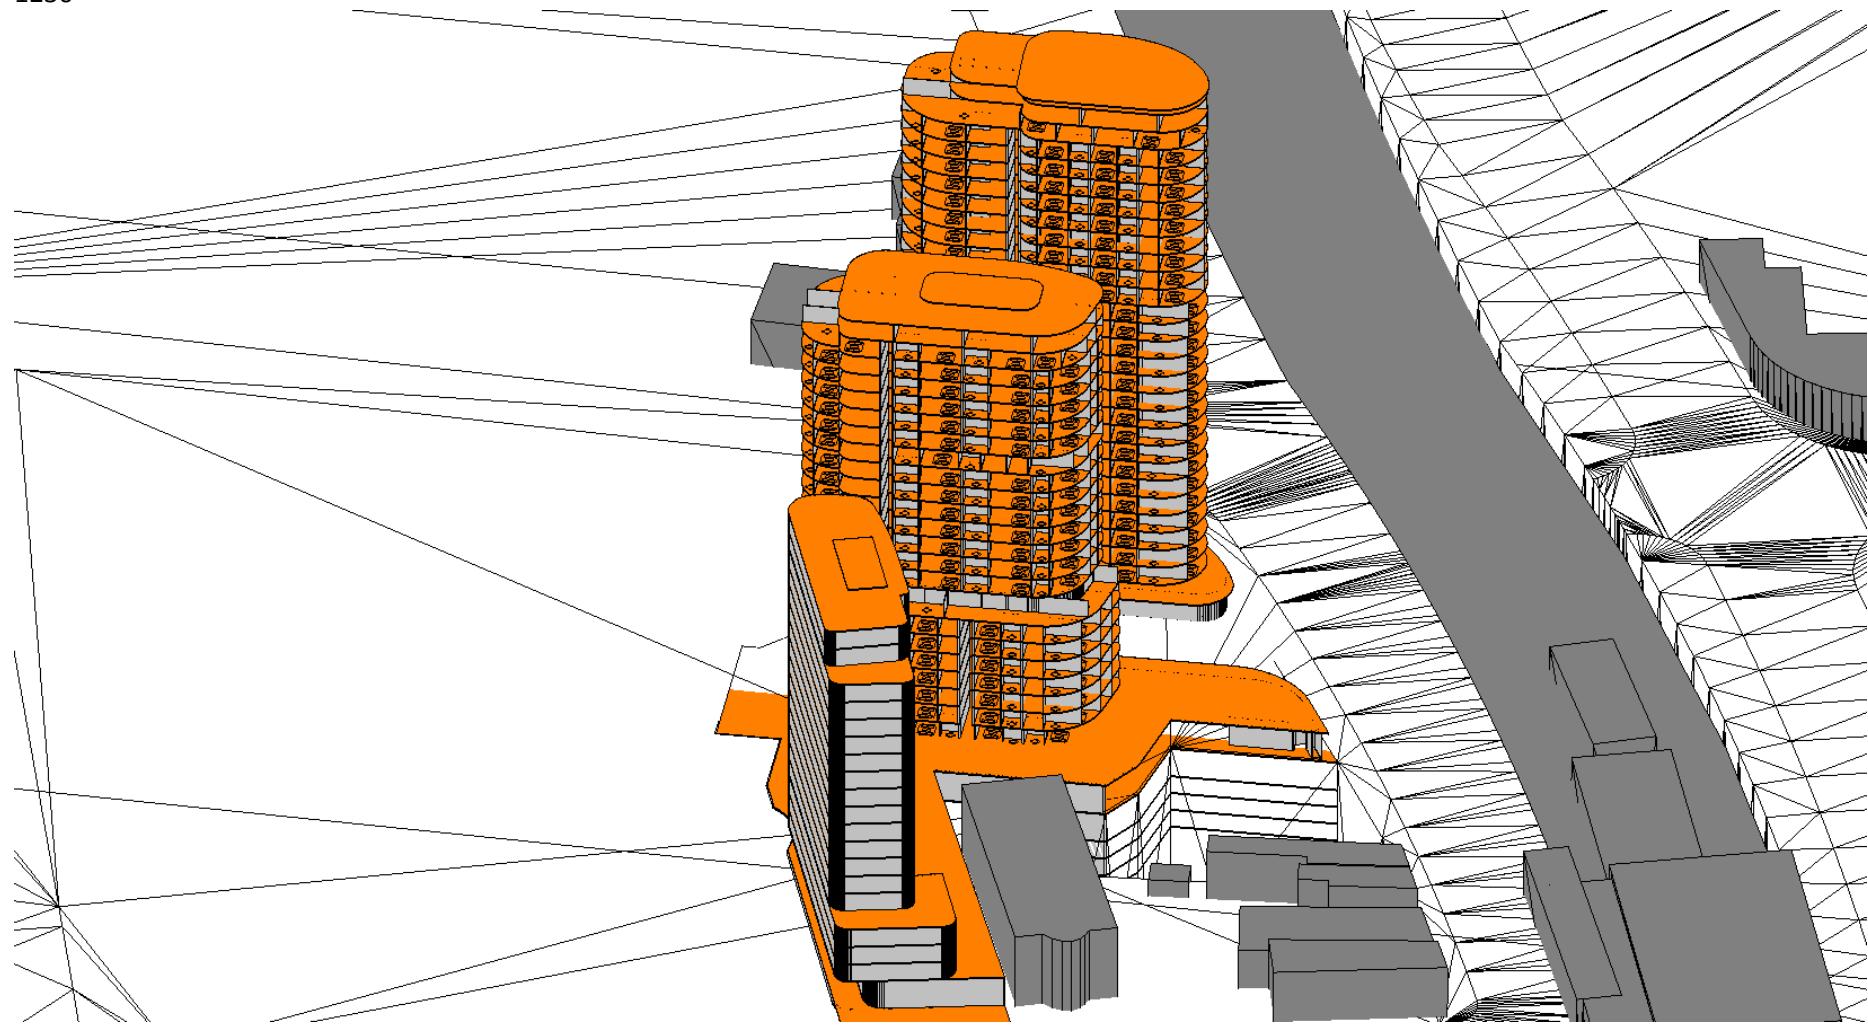
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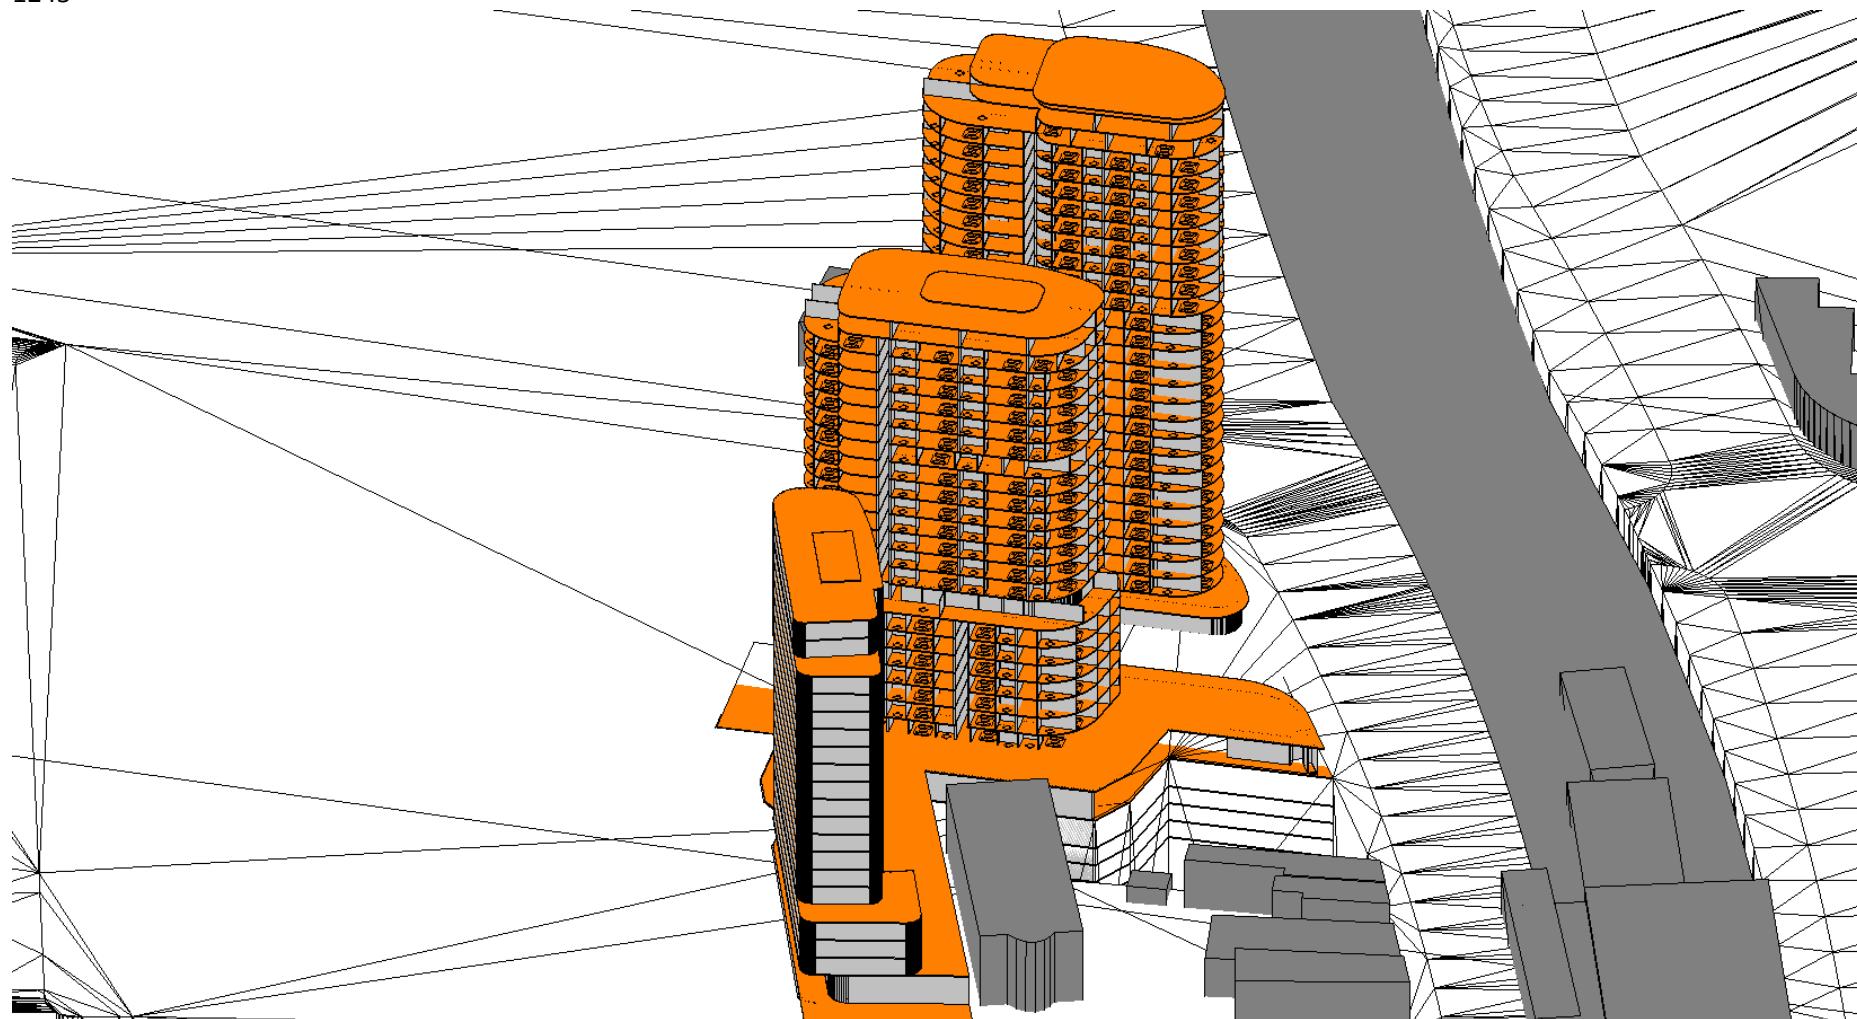
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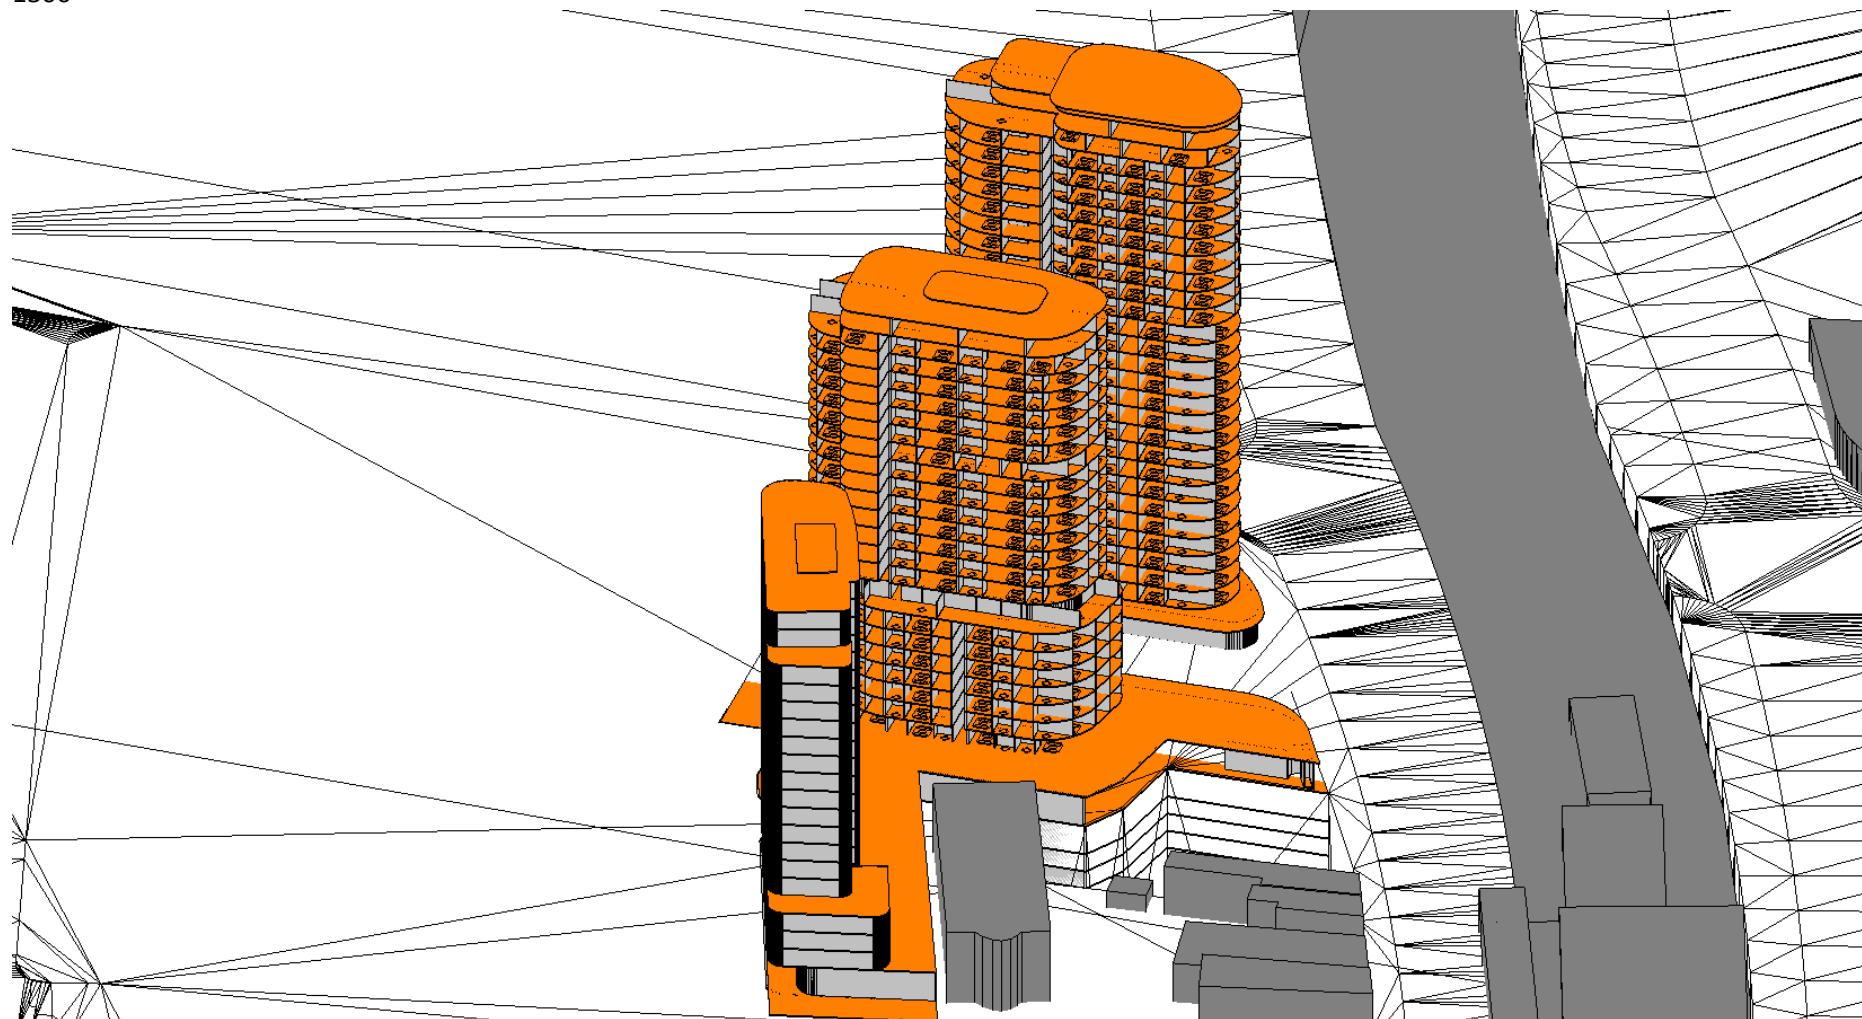
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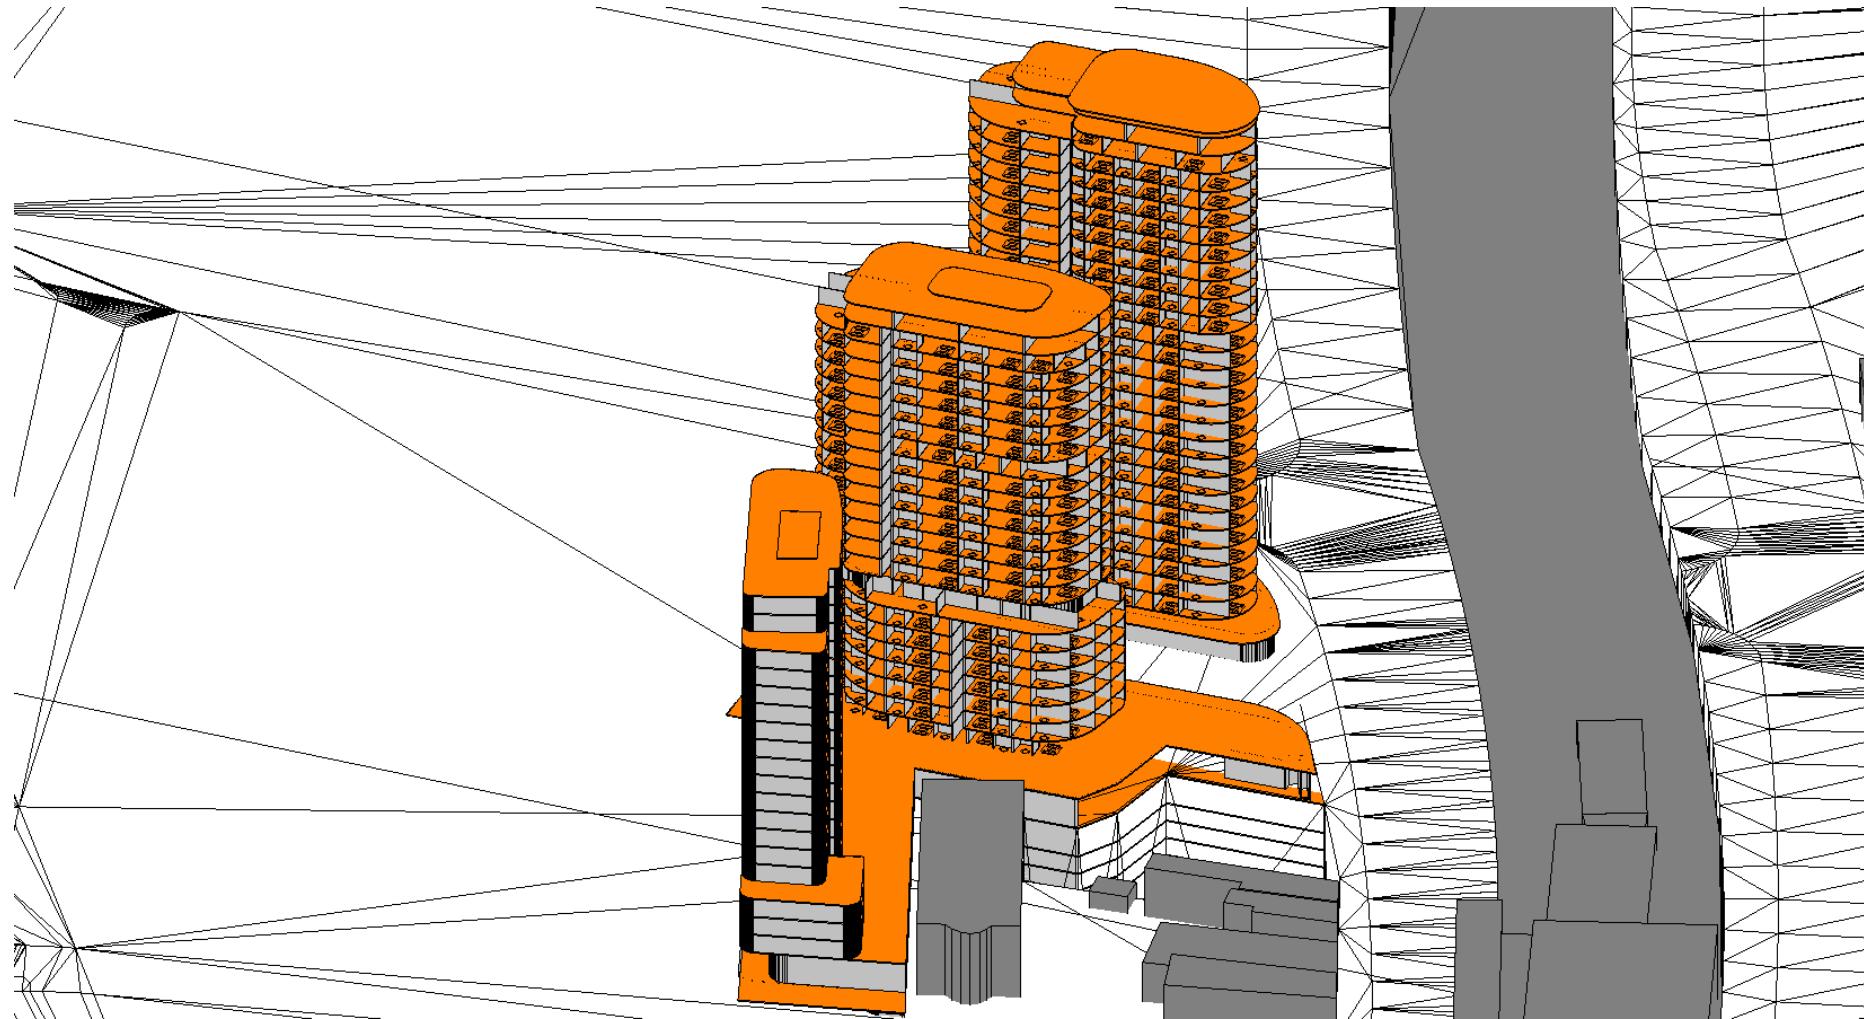
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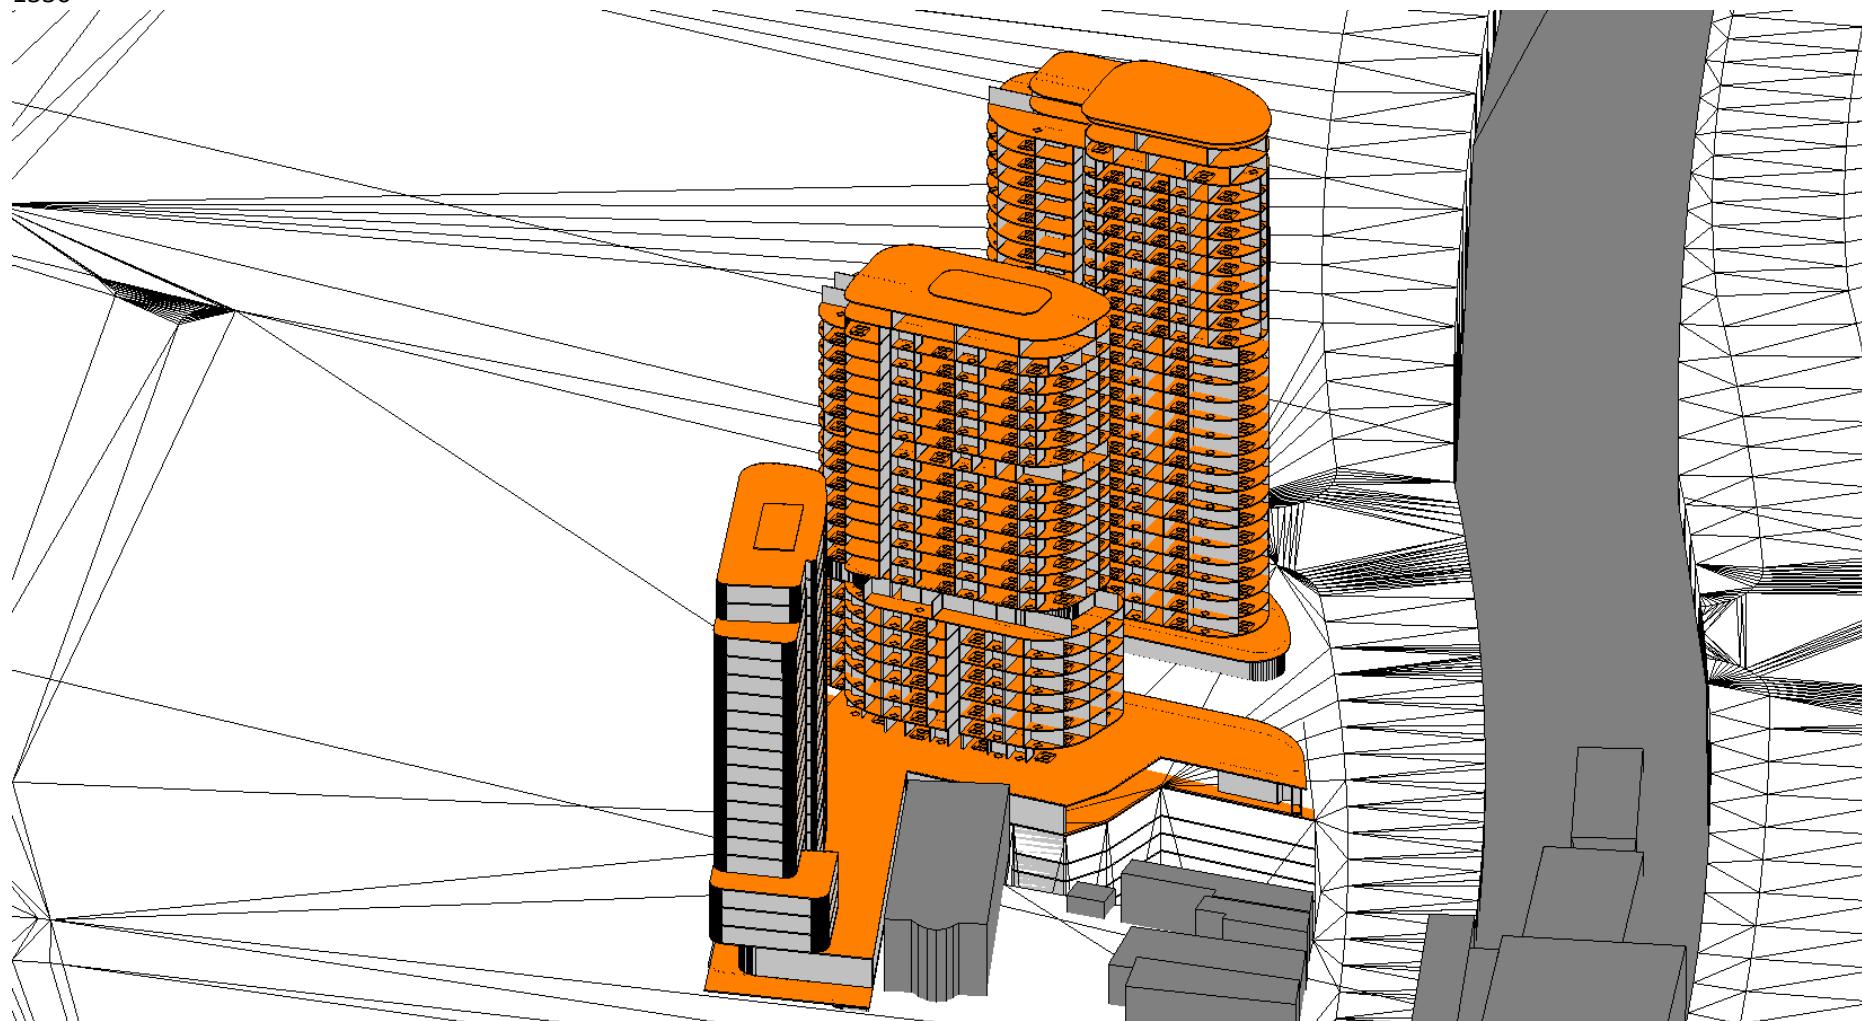
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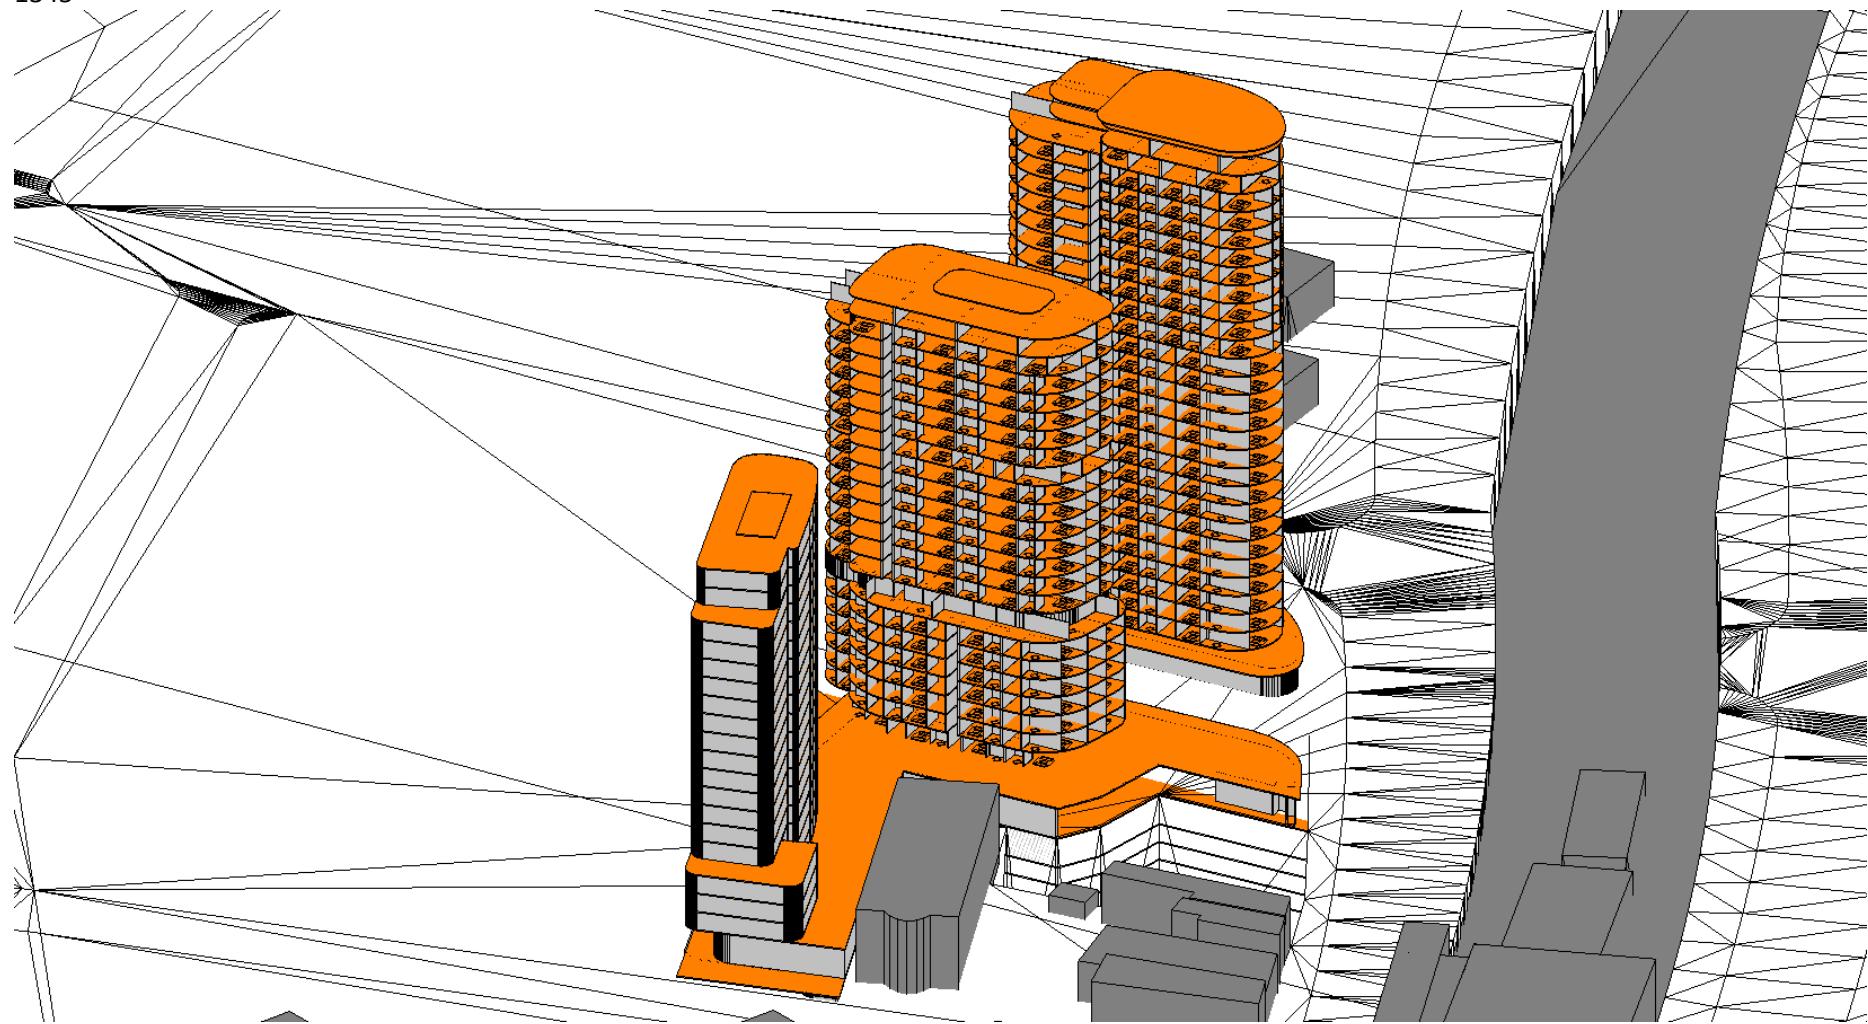
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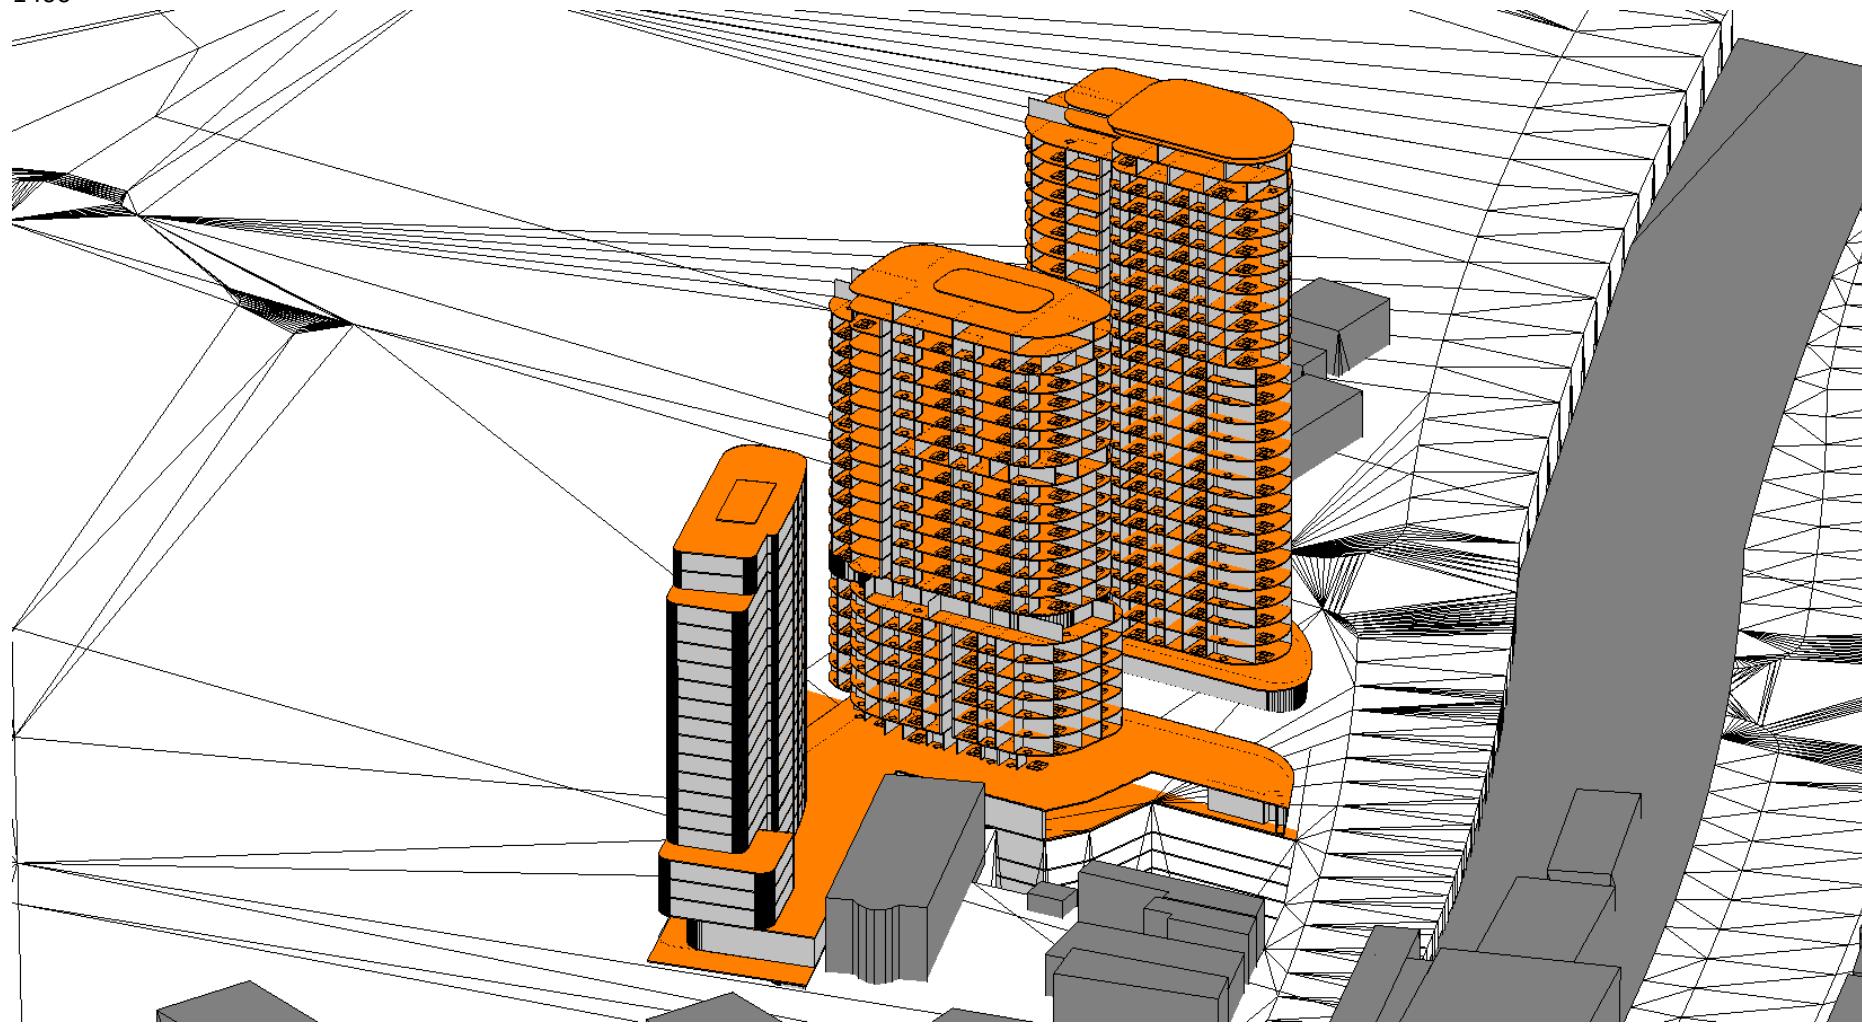
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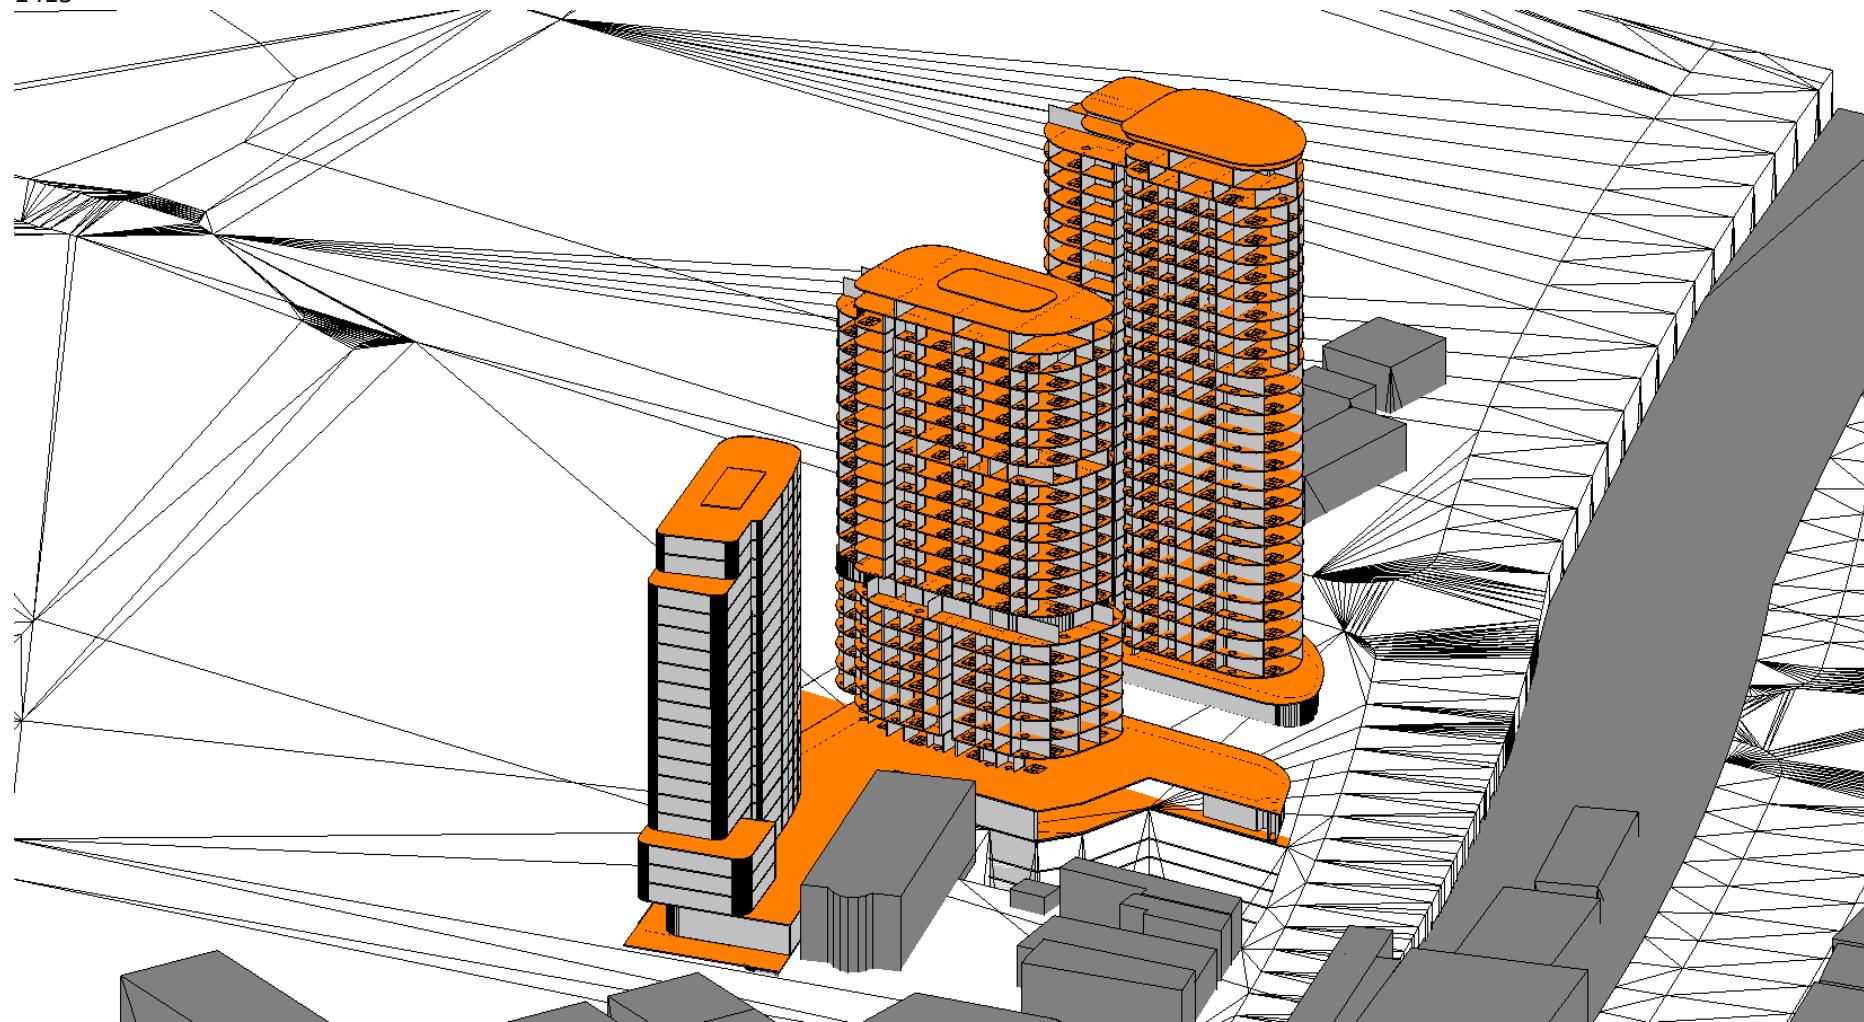
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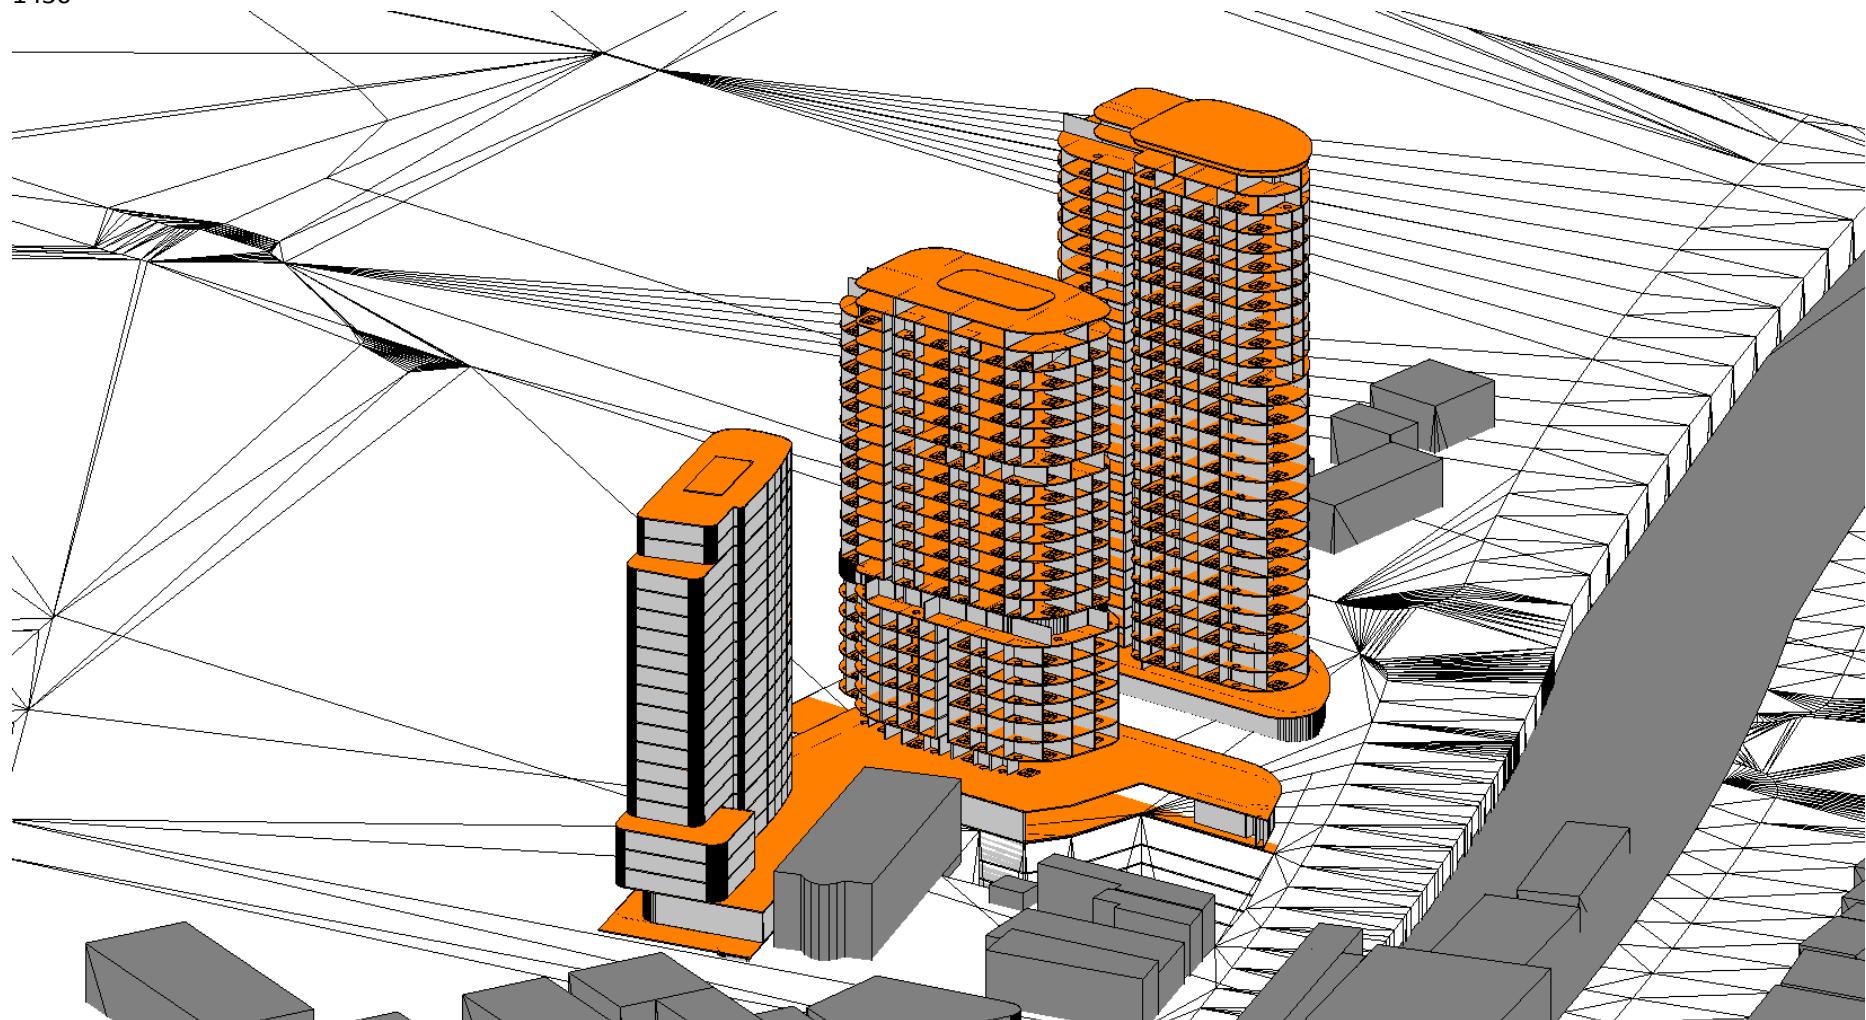
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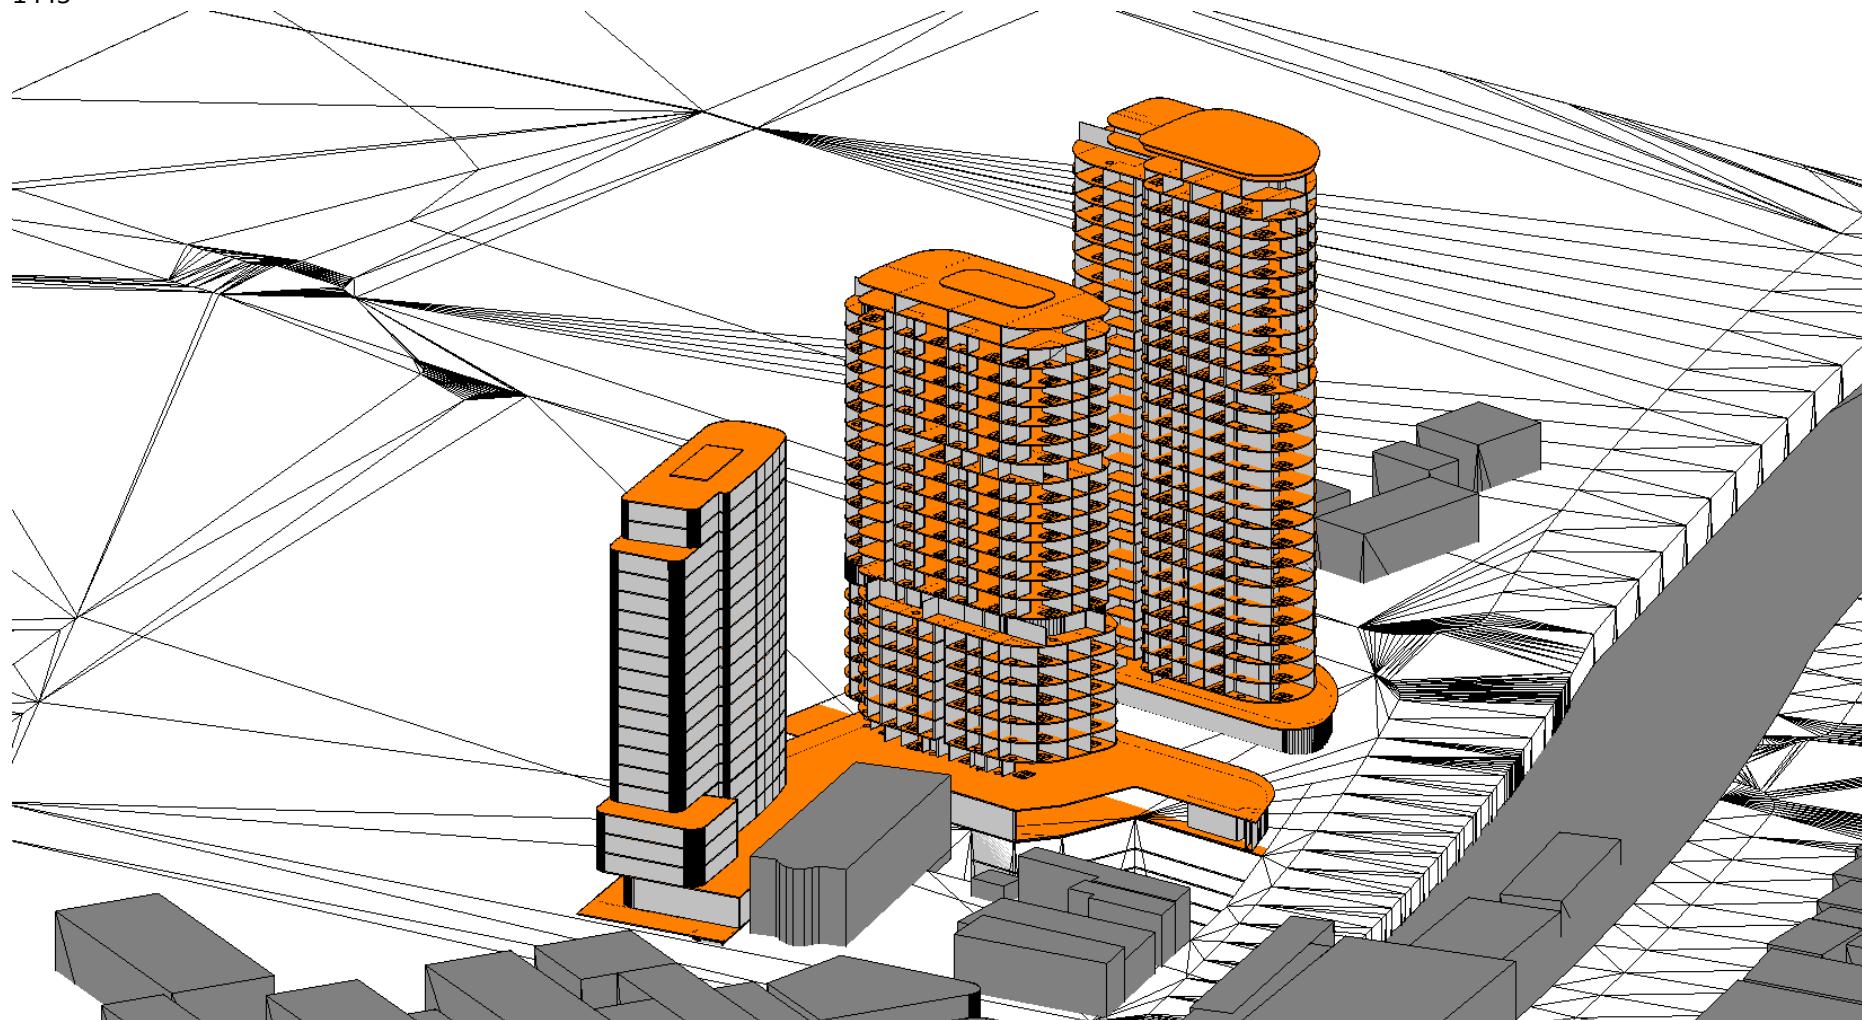
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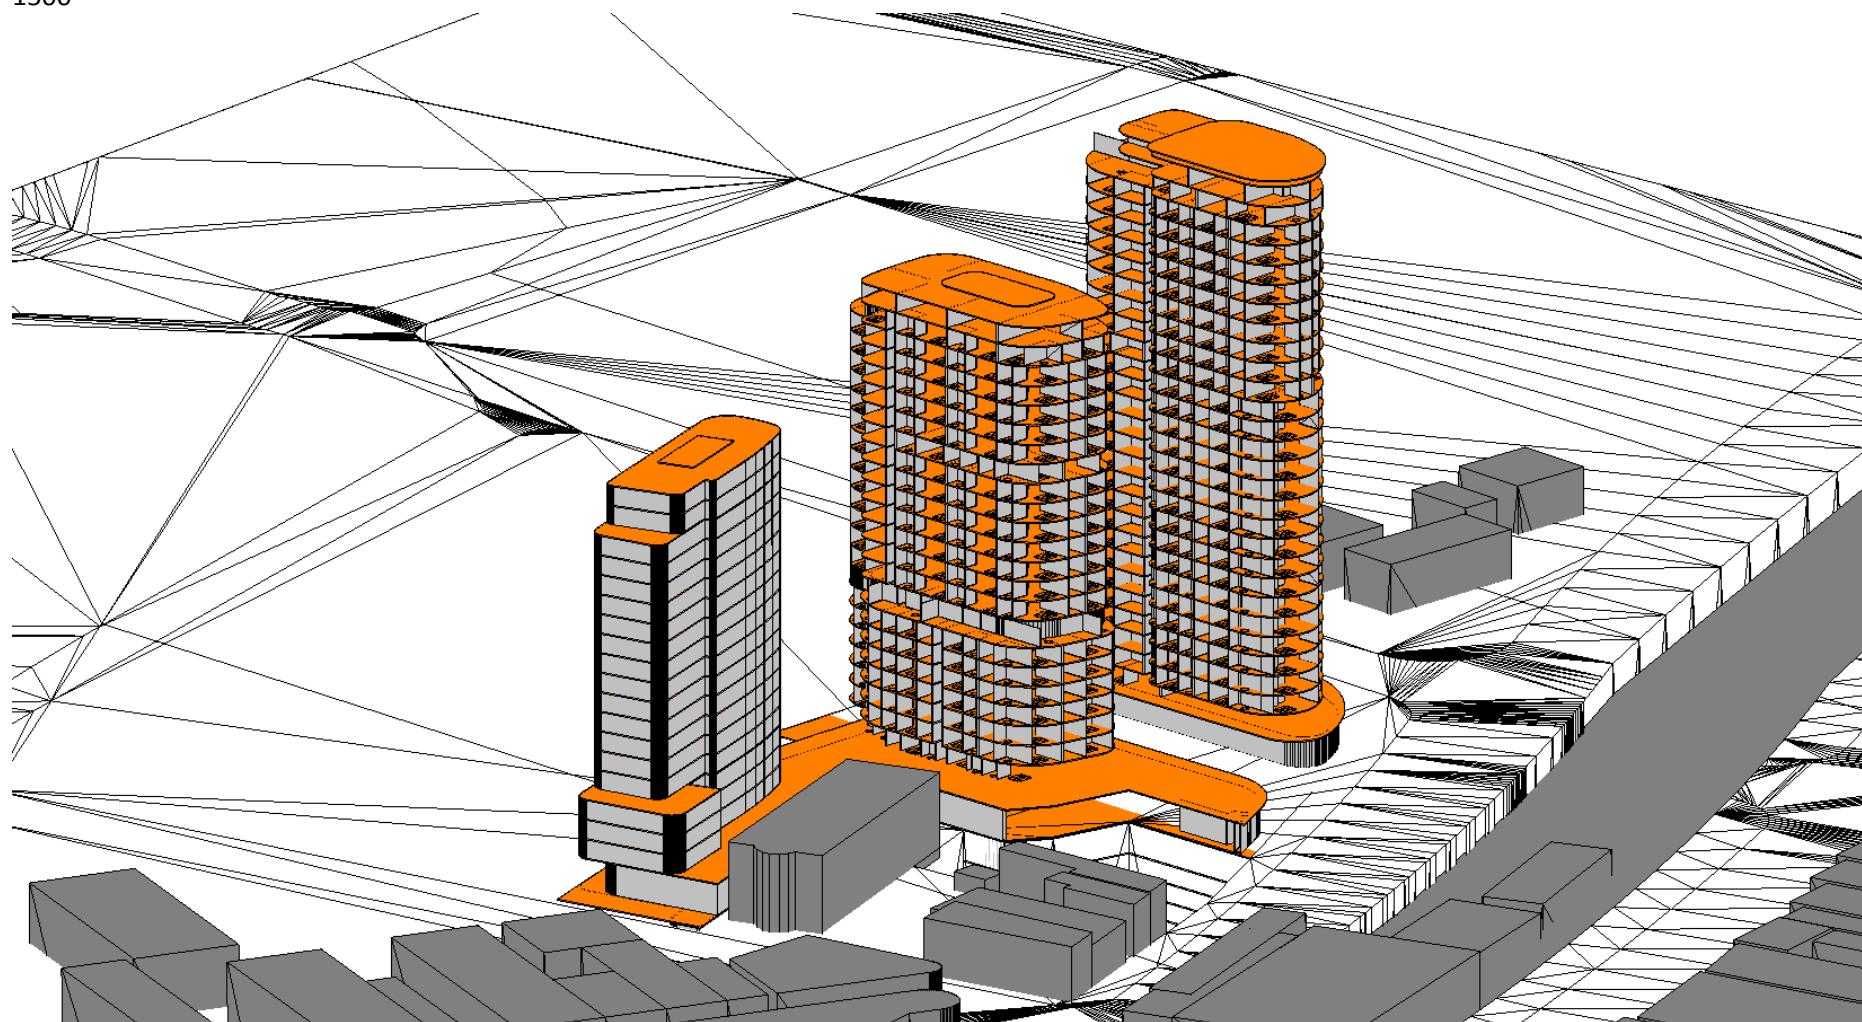
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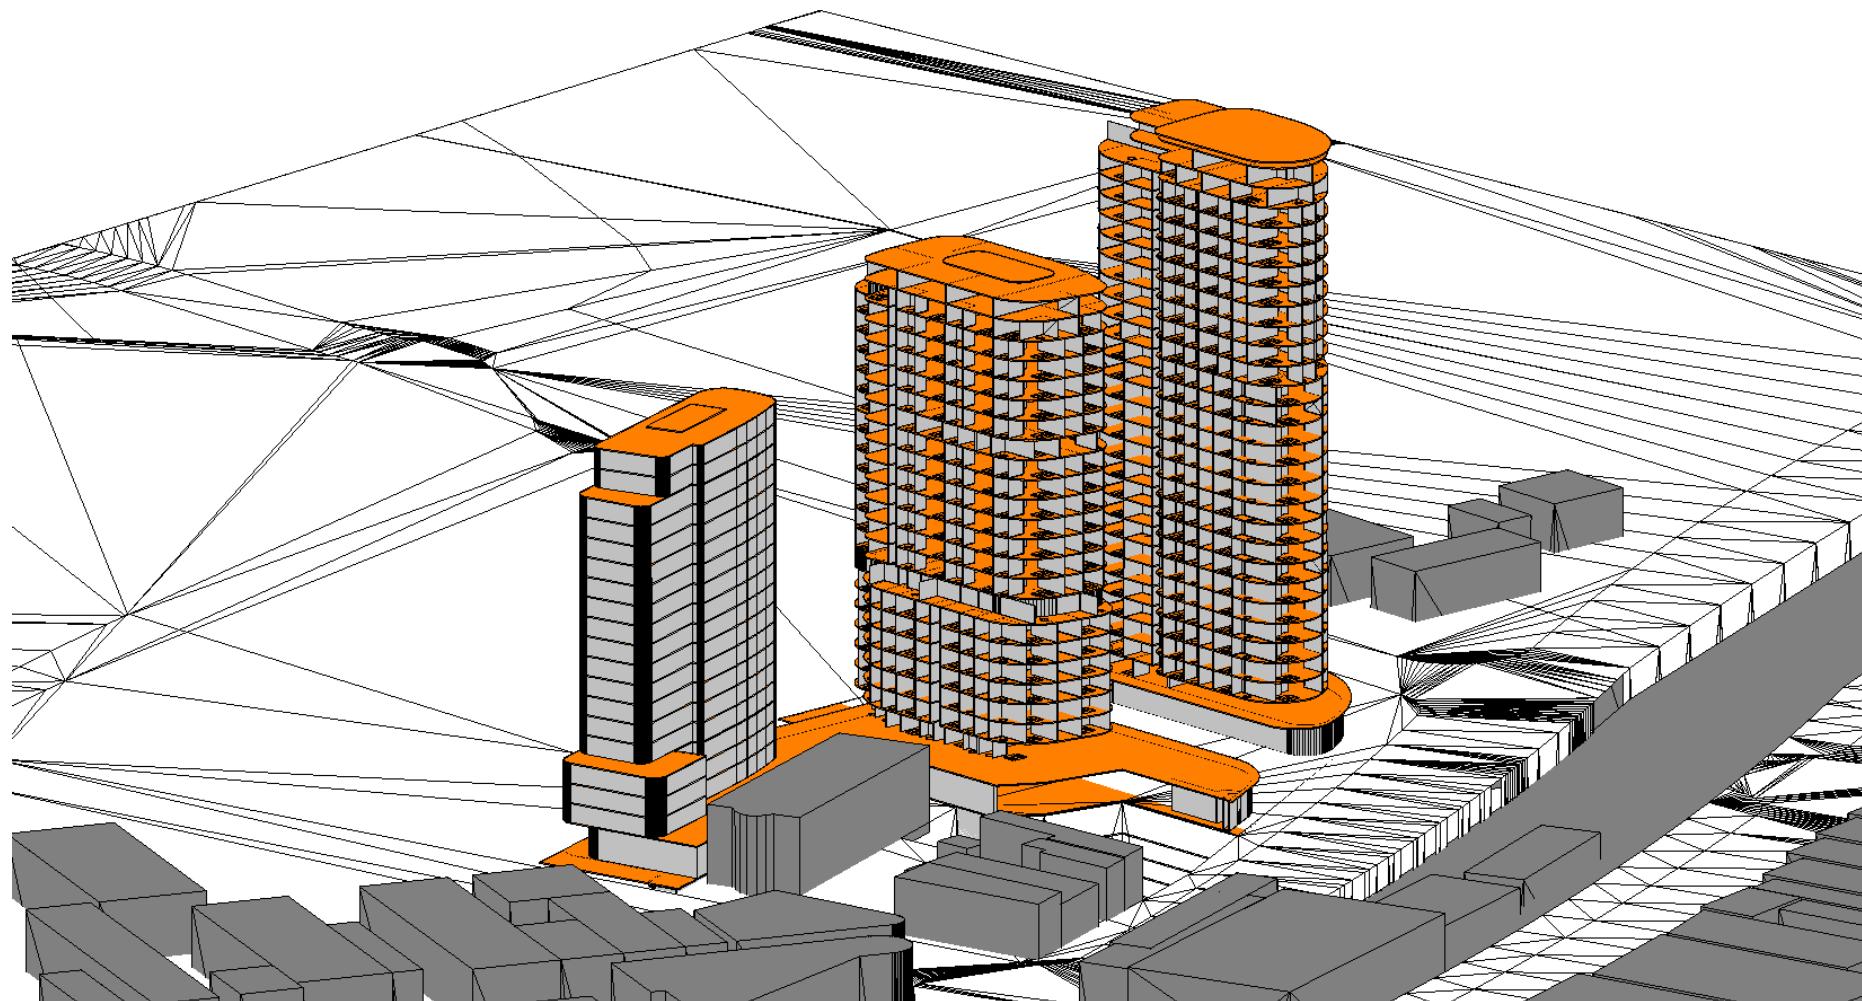


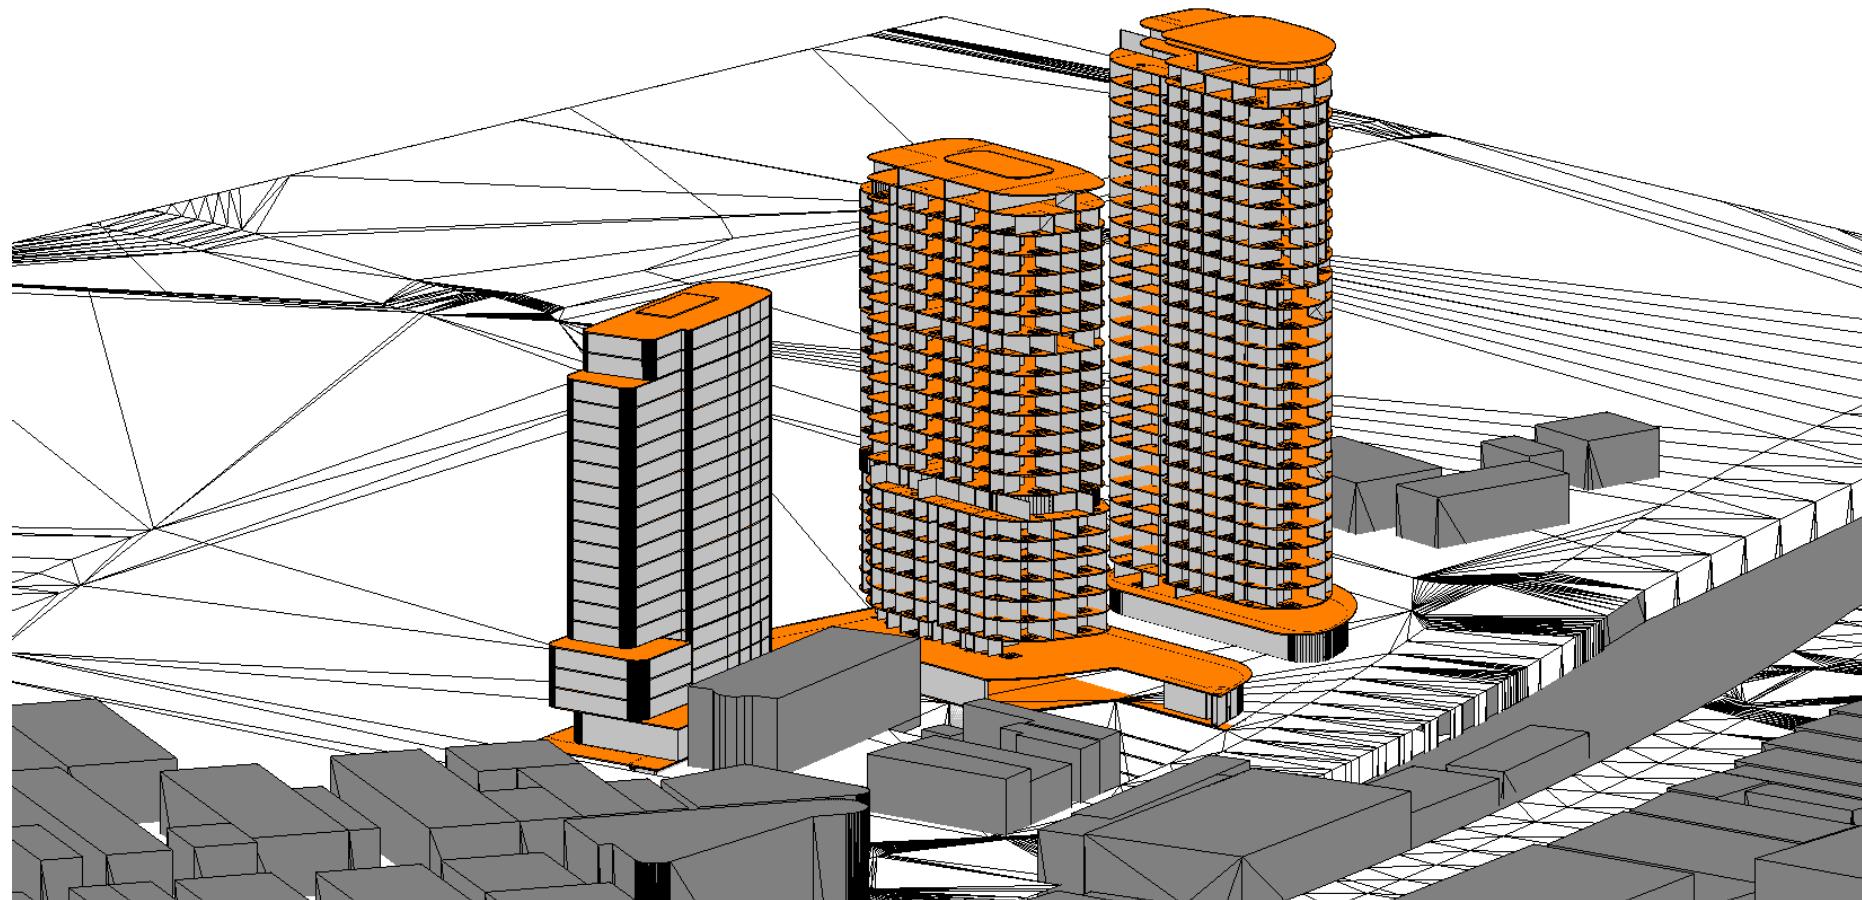
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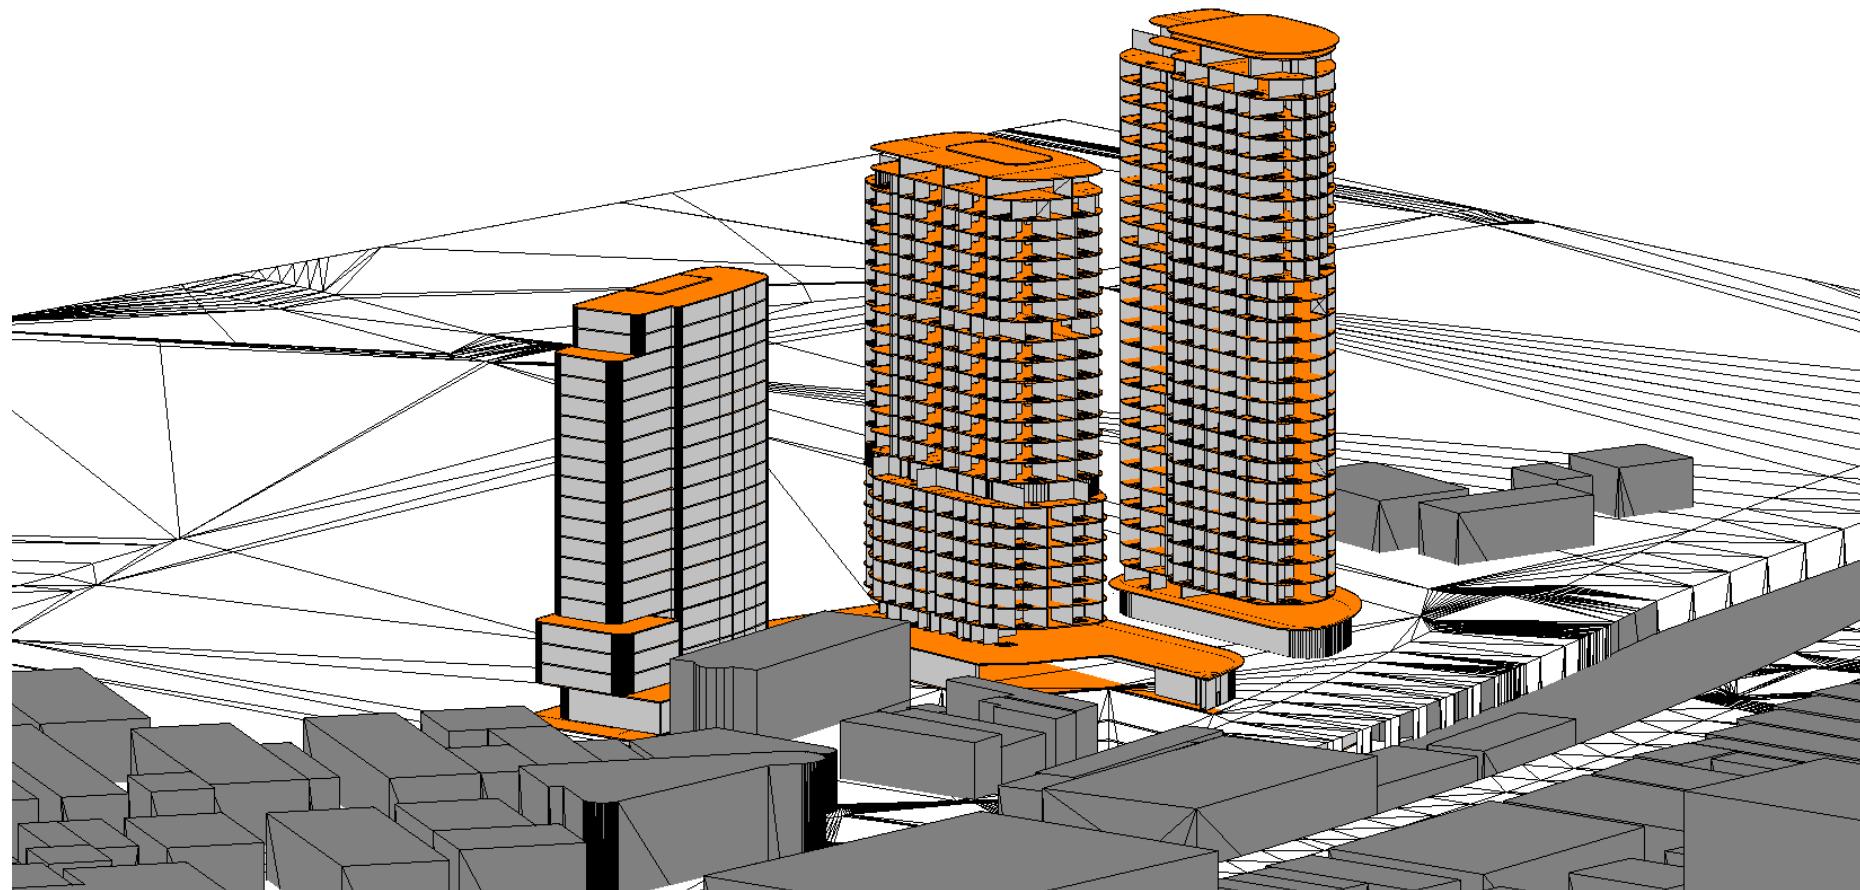


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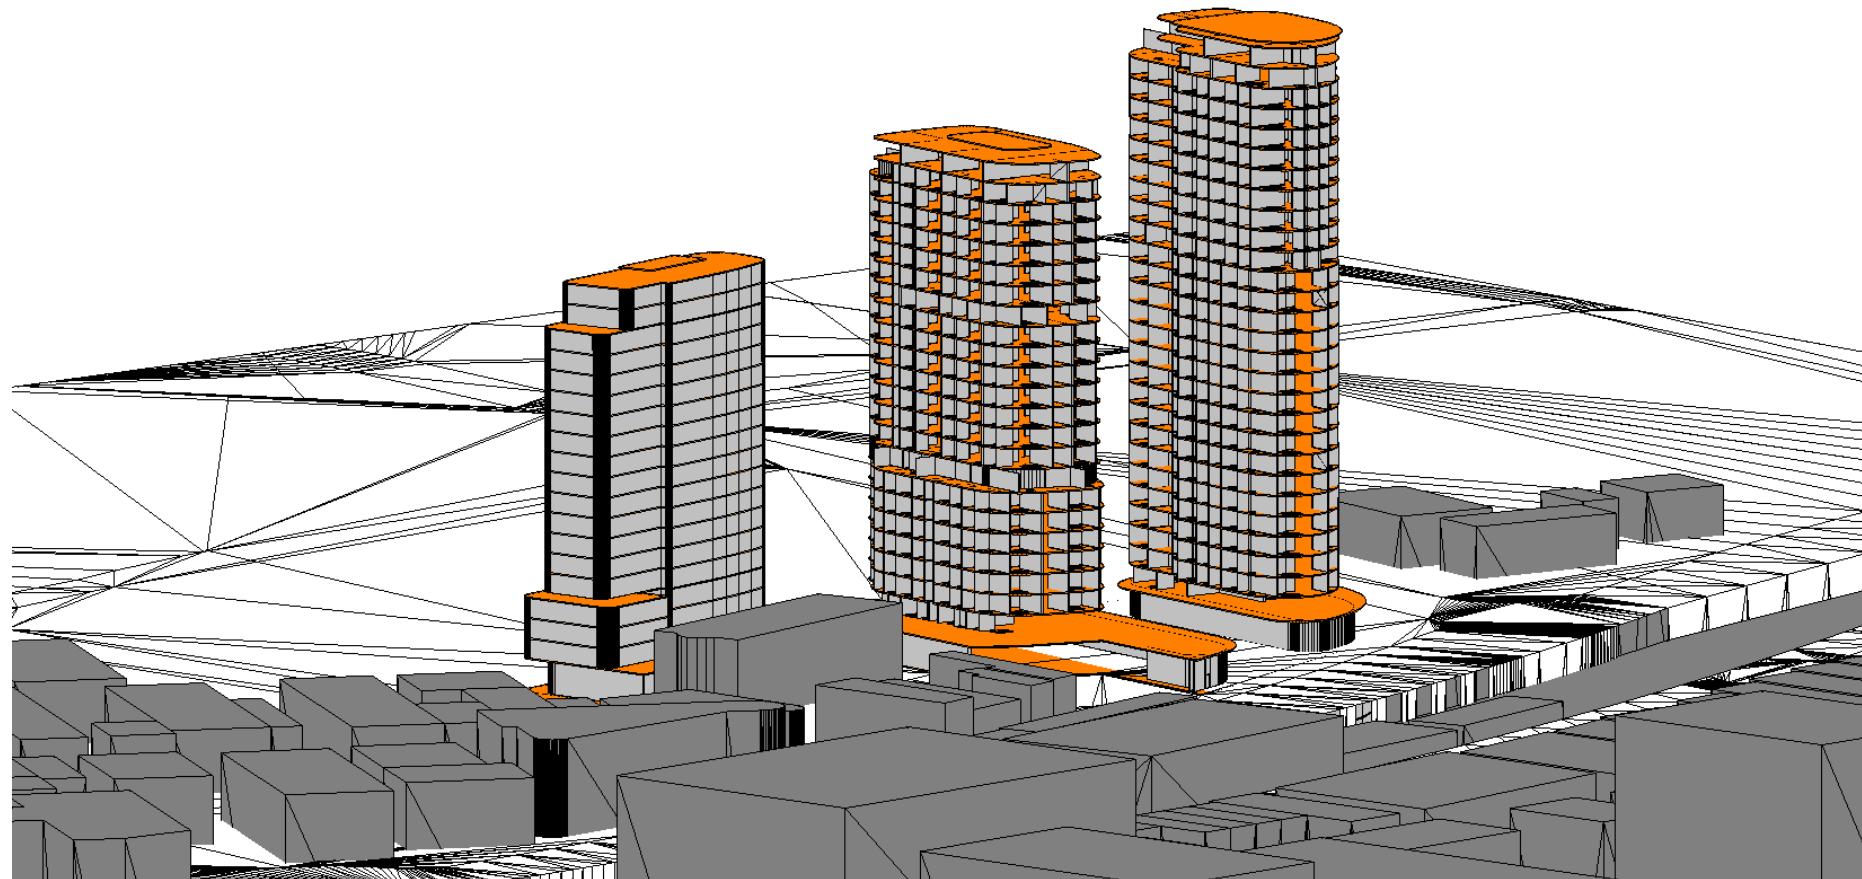








1600



## APPENDIX G

### Solar Access to Private Living Space Calculation - DA Scheme





Demonstrates when apartment balcony has achieved solar access through borrowing light from the living room  
Solar Access to one living area only (either balcony or living room)

## APPENDIX H

### Solar Access to Private Living Space Calculation - ADG Massing





Demonstrates when apartment balcony has achieved solar access through borrowing light from the living room  
Solar Access to one living area only (either balcony or living room)

# APPENDIX I

Solar Access to Private Living Space Calculation - ADG Massing + Future Northern Development





Demonstrates when apartment balcony has achieved solar access through borrowing light from the living room  
Solar Access to one living area only (either balcony or living room)

## APPENDIX J

Solar Access to Private Living Space Calculation - CBUS Development with no other Proposed Development





Demonstrates when apartment balcony has achieved solar access through borrowing light from the living room

## **APPENDIX K**

Shadow Diagrams Existing surrounds to Tower 1 and 2

0900



0915



0930



1000



1030



1045





1115





1145



1200



1215



1230



1245



1300



1315





1345



1400



1415



1430



1445





## **APPENDIX L**

Shadow Diagrams DA + Future Northern Development surrounds to Tower  
1 and 2

0900



0915



0930



0945



1000



1030



1045



1100



1115





1145



1200



1215



1230



1245



1300



1315



1330



1345



1400



1415



1430



1445



1500



## **APPENDIX M**

Shadow Diagrams ADG + Future Northern Development surrounds to Tower  
1 and 2

0900



0930



0945



1000



1015



1030



1045



1100



1130



1145



1200



1215



1230



1300



1315





1345



1400



1430



1445

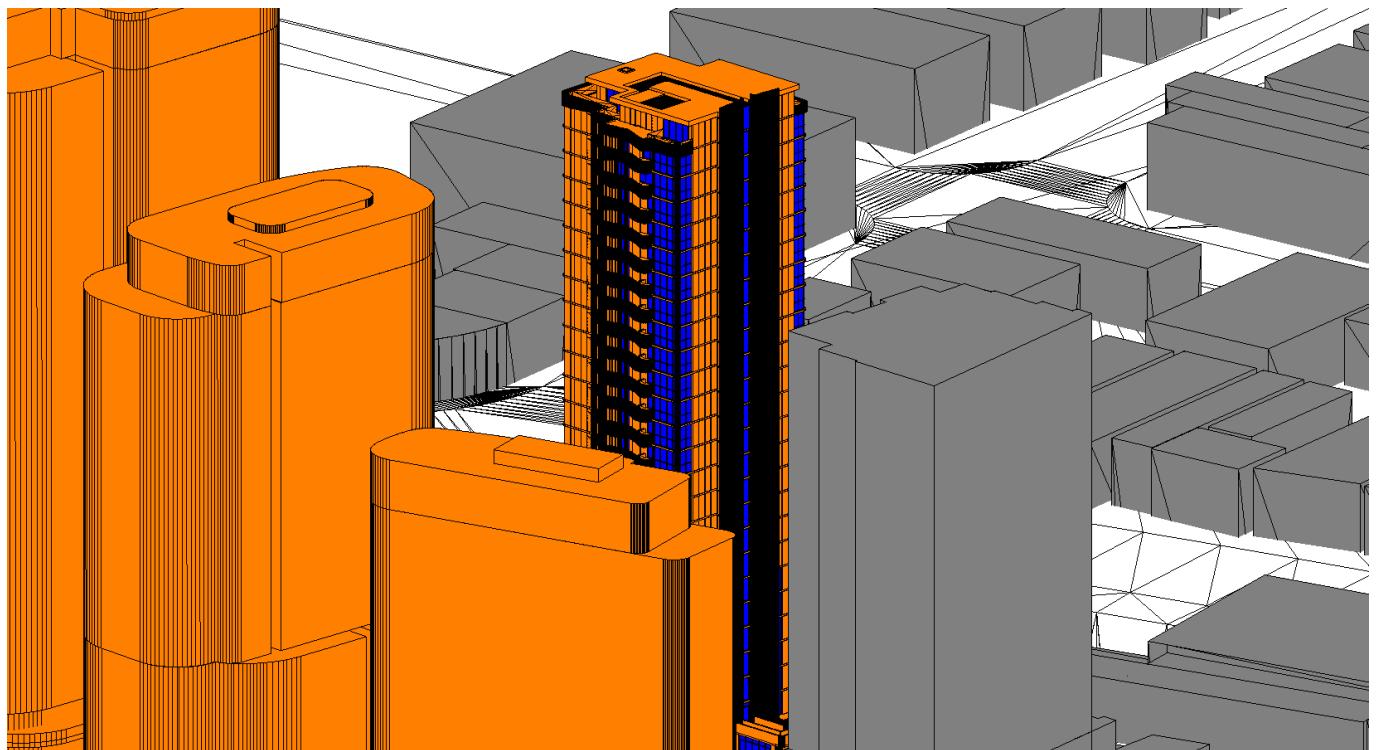




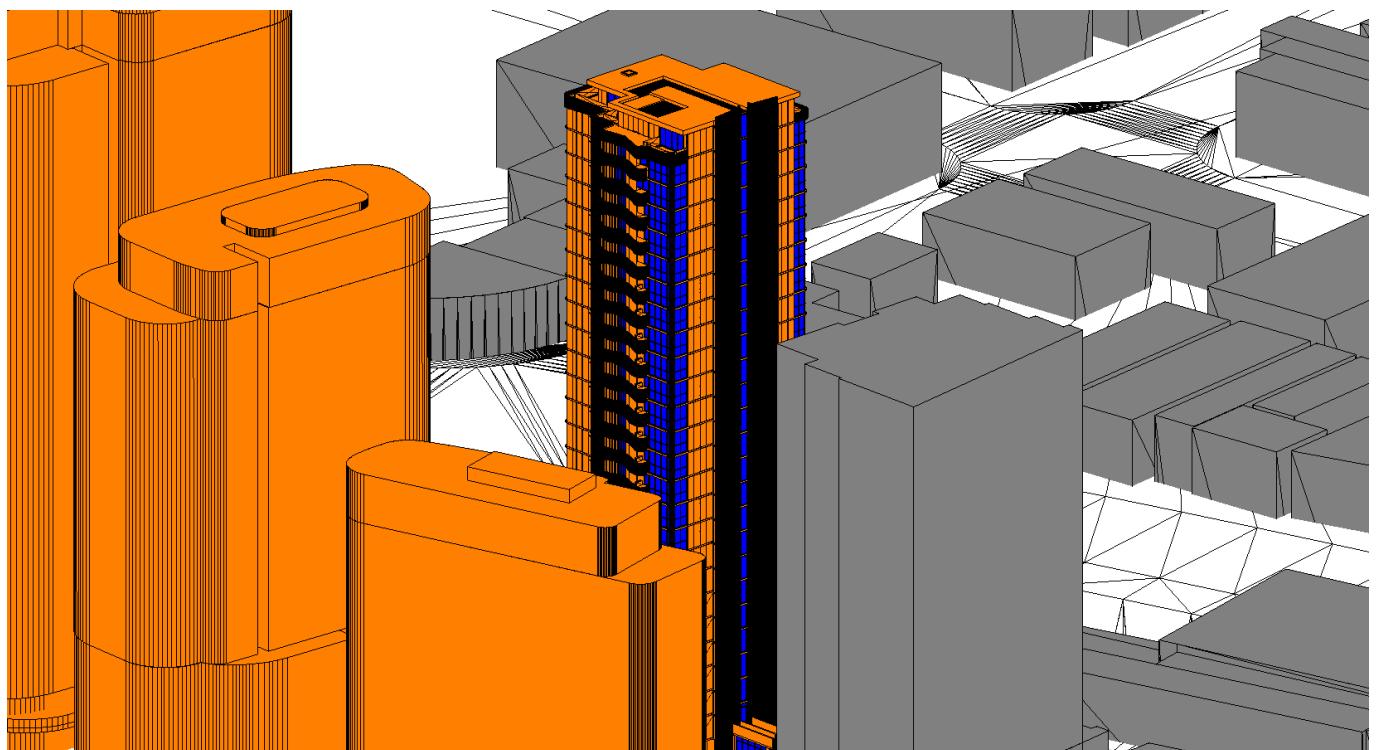
## **APPENDIX N**

**Sun Eye Views DA Scheme + Future Northern Development**

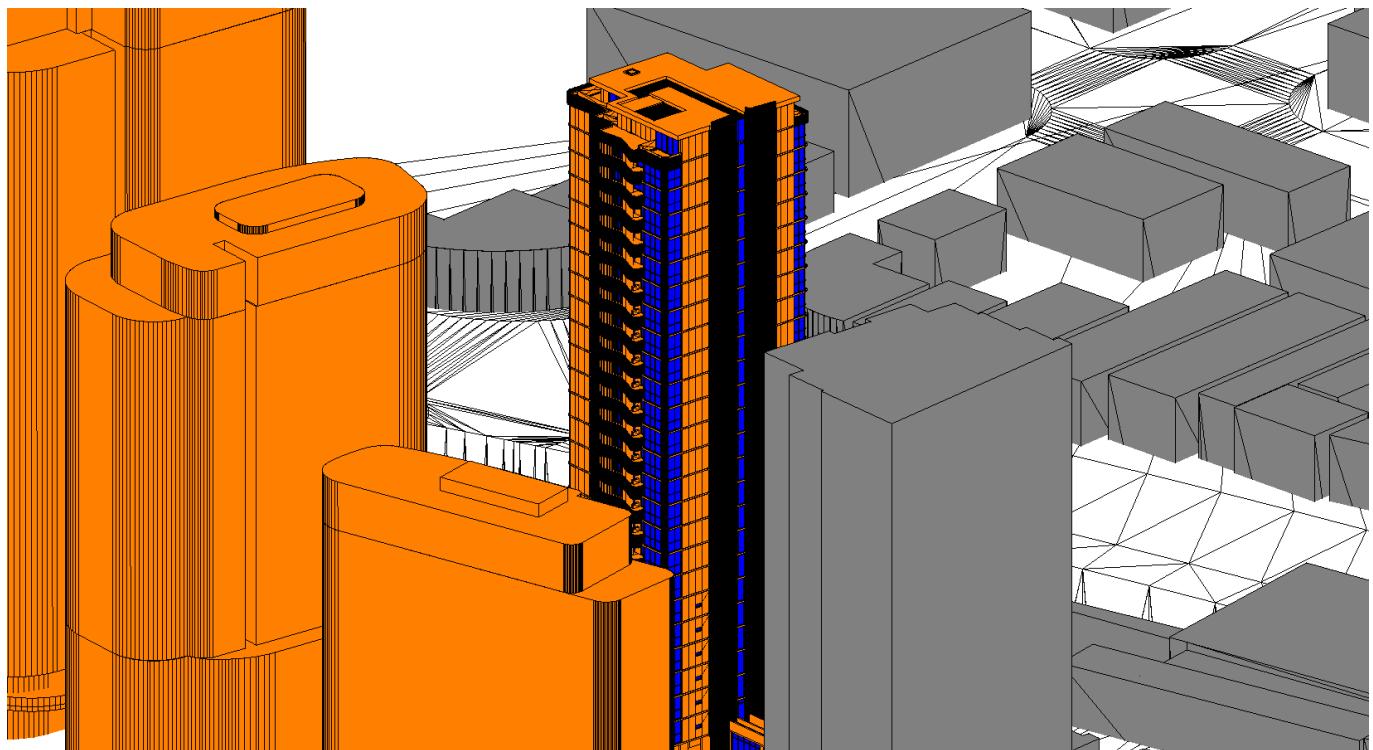
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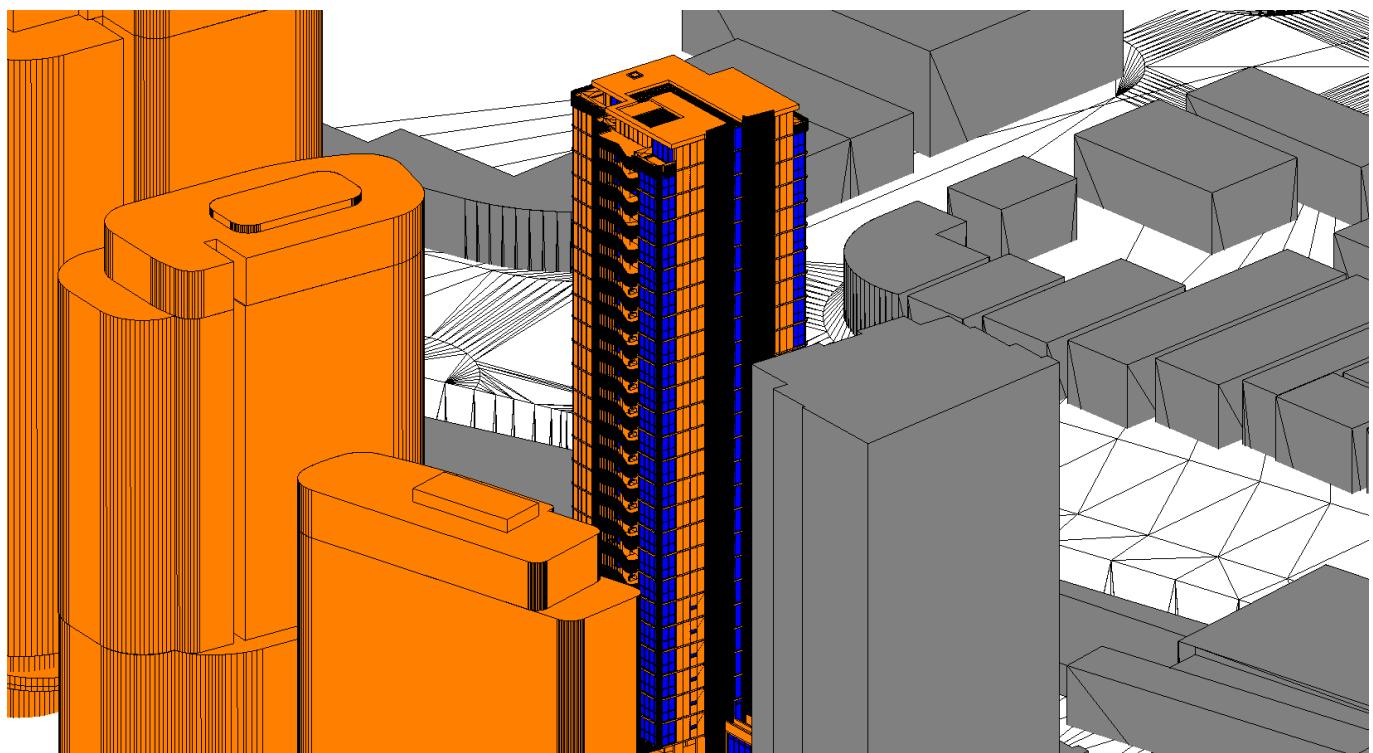
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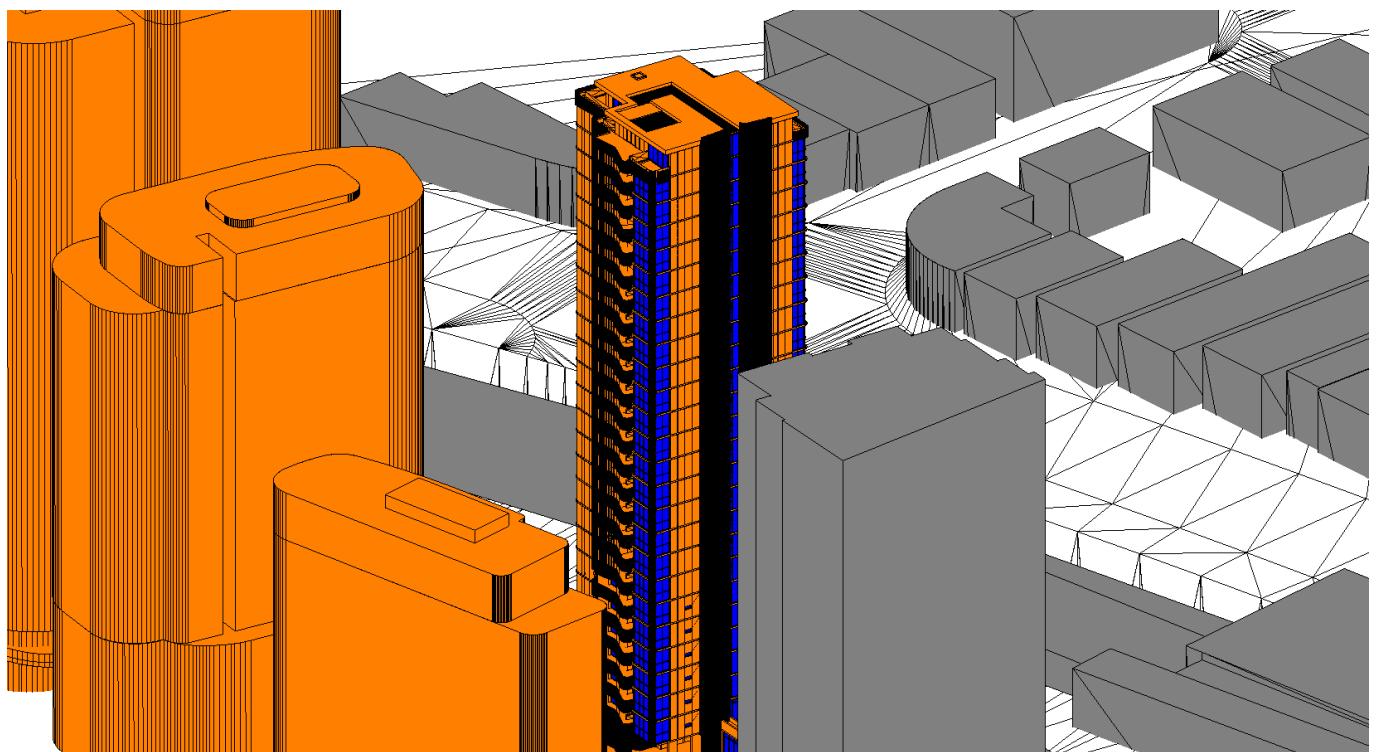
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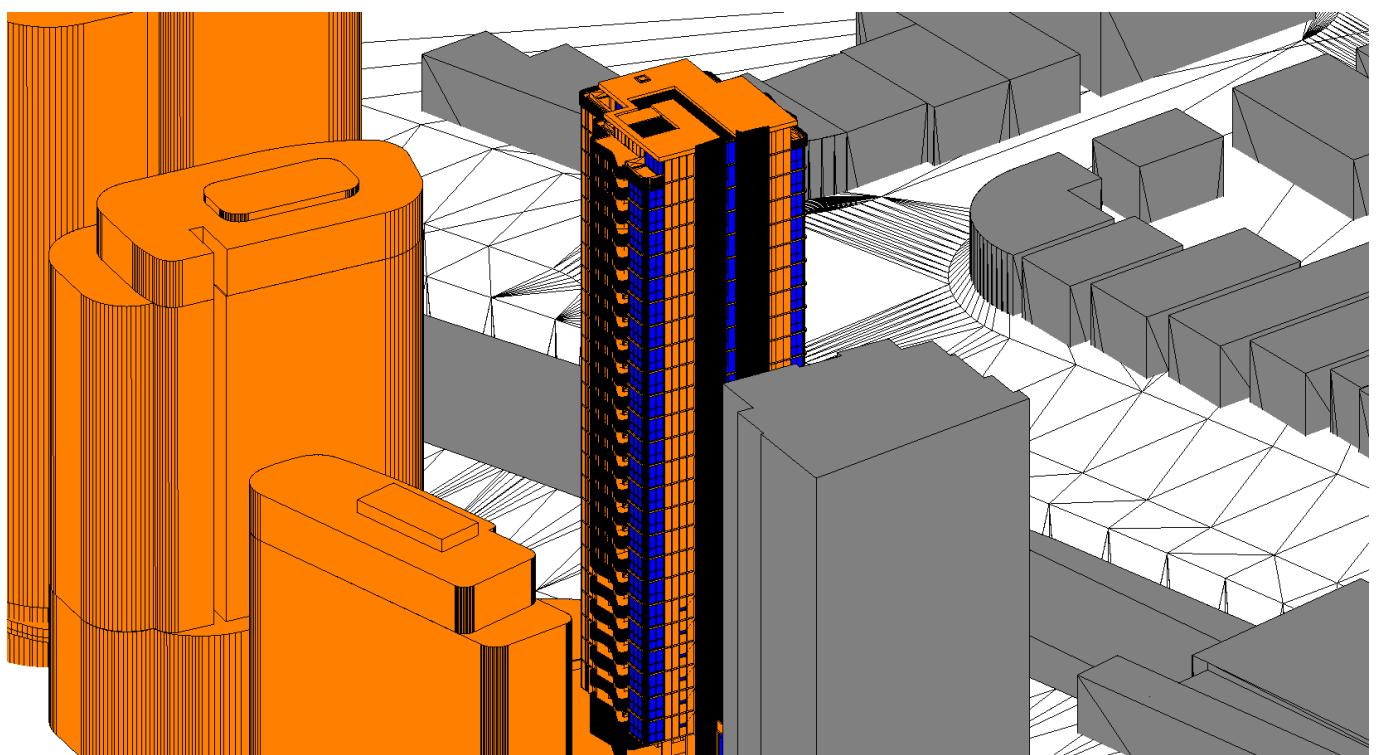
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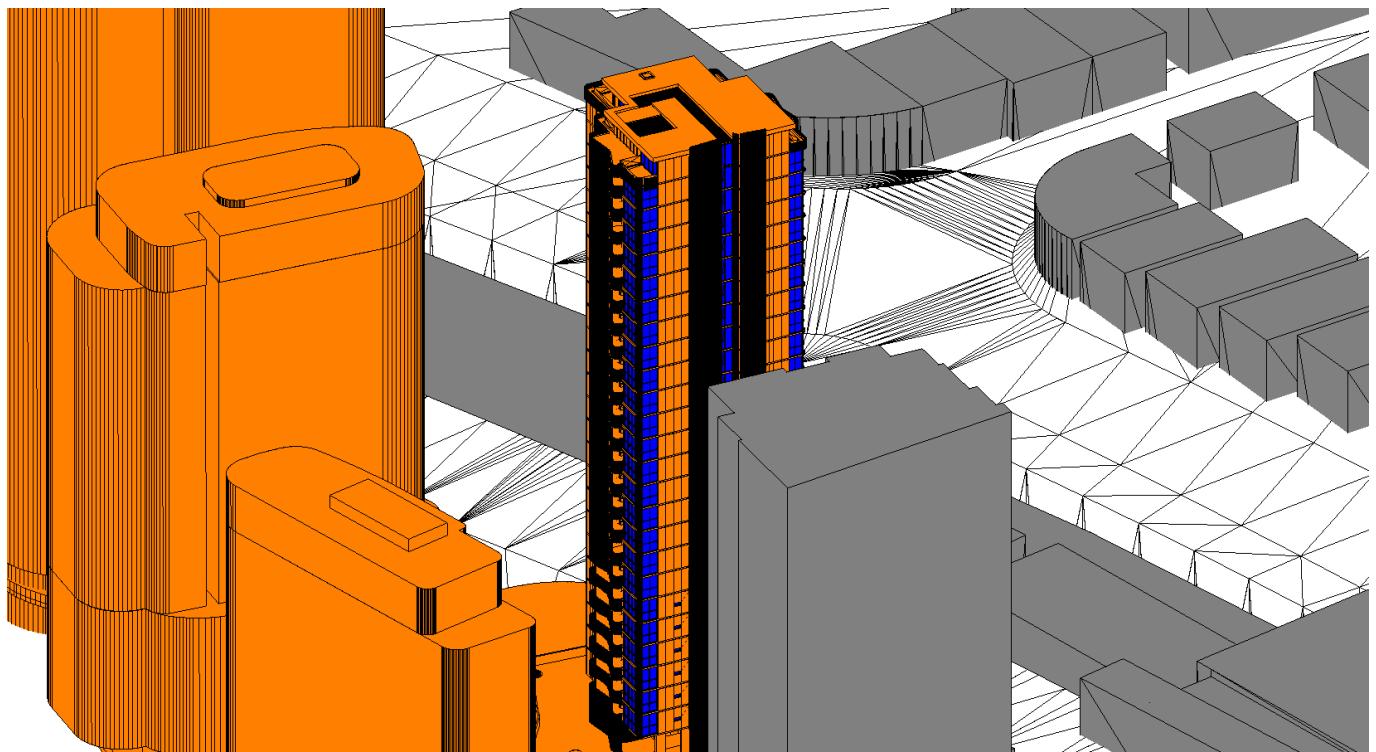
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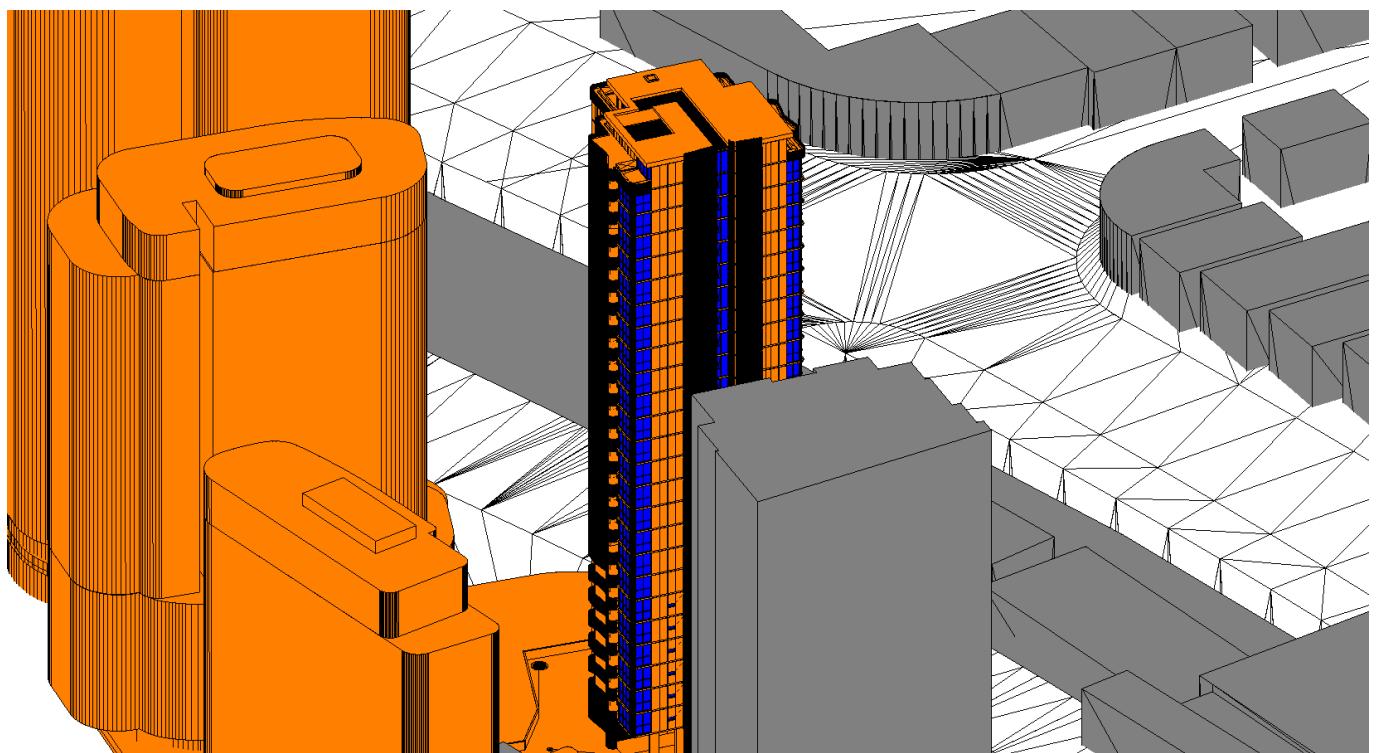
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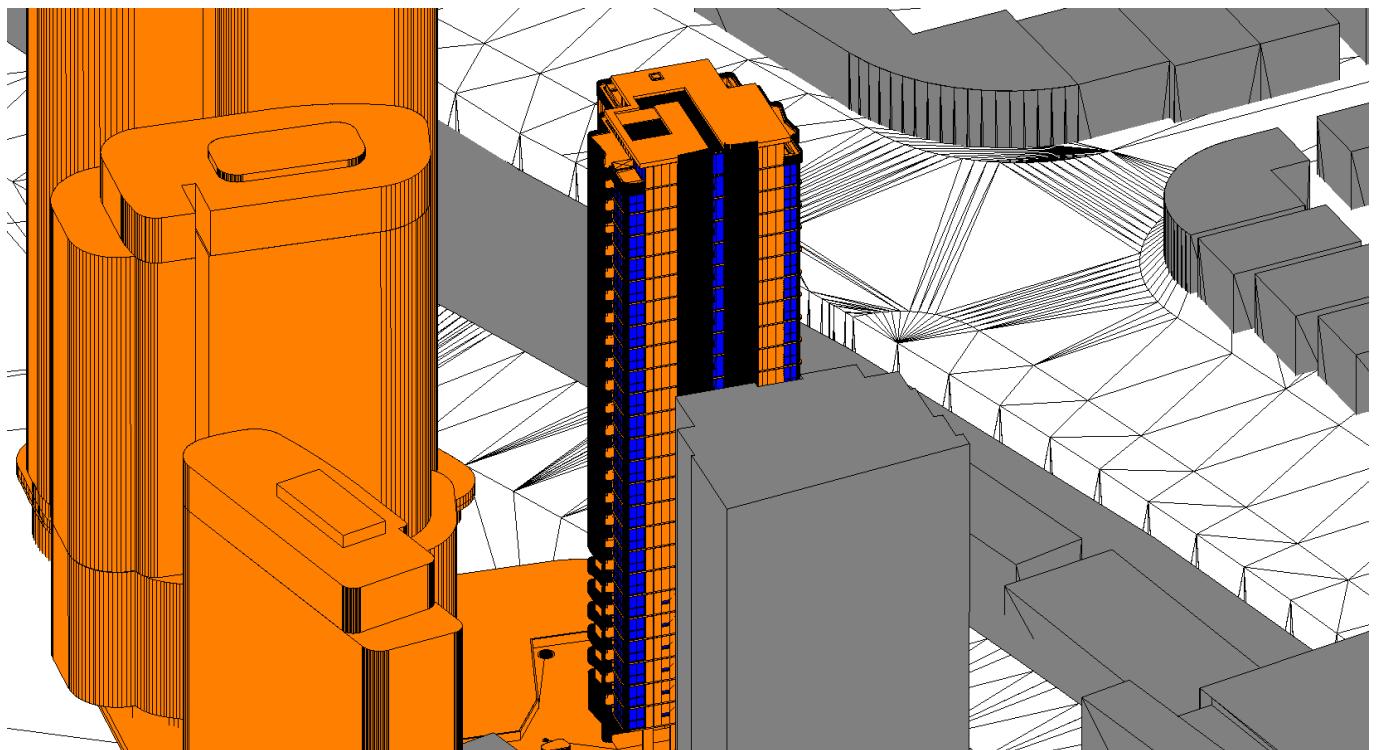
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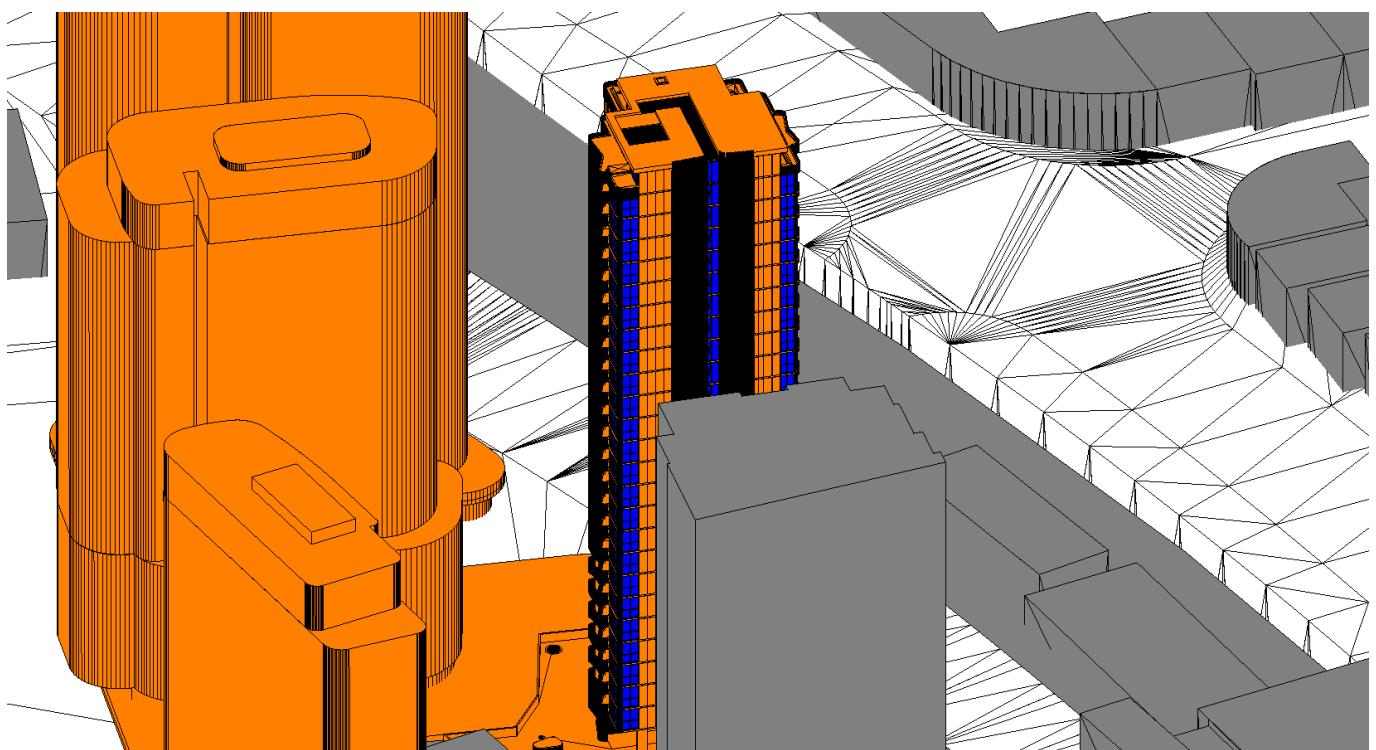
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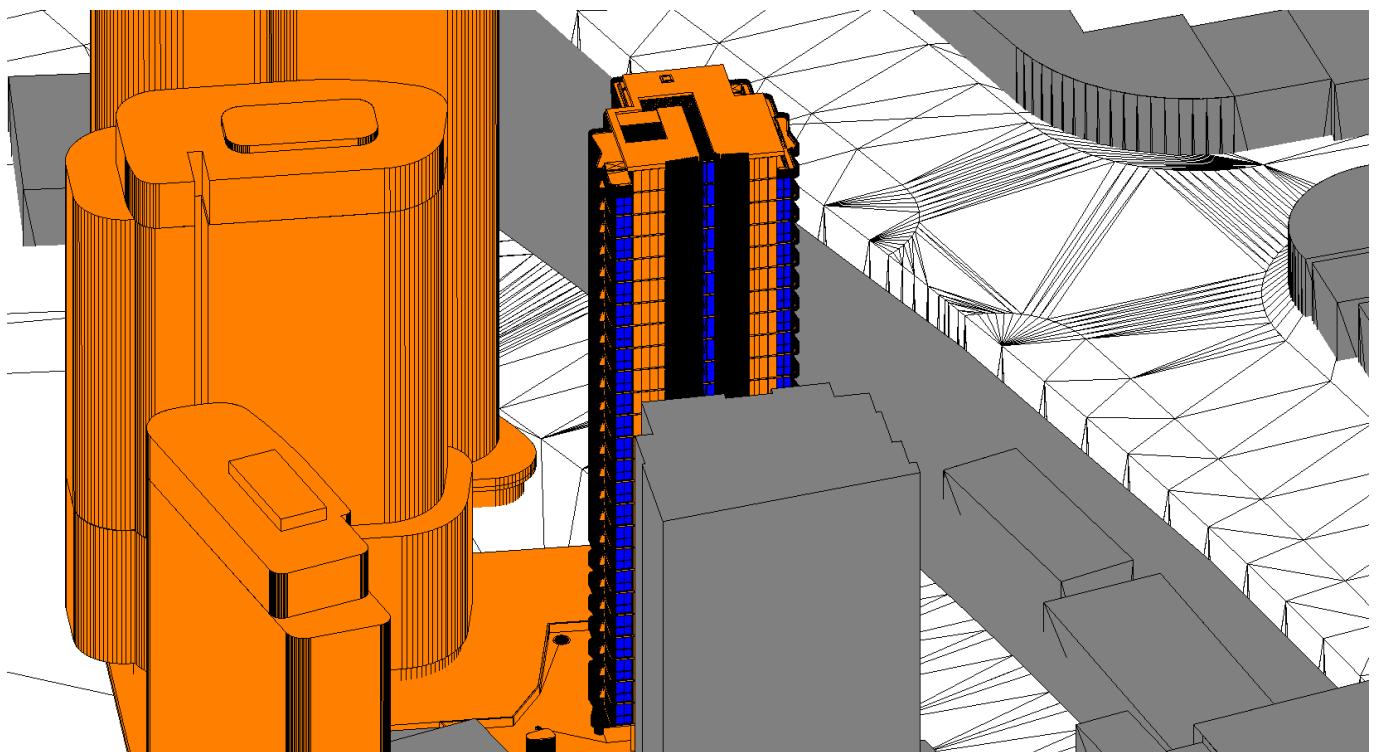
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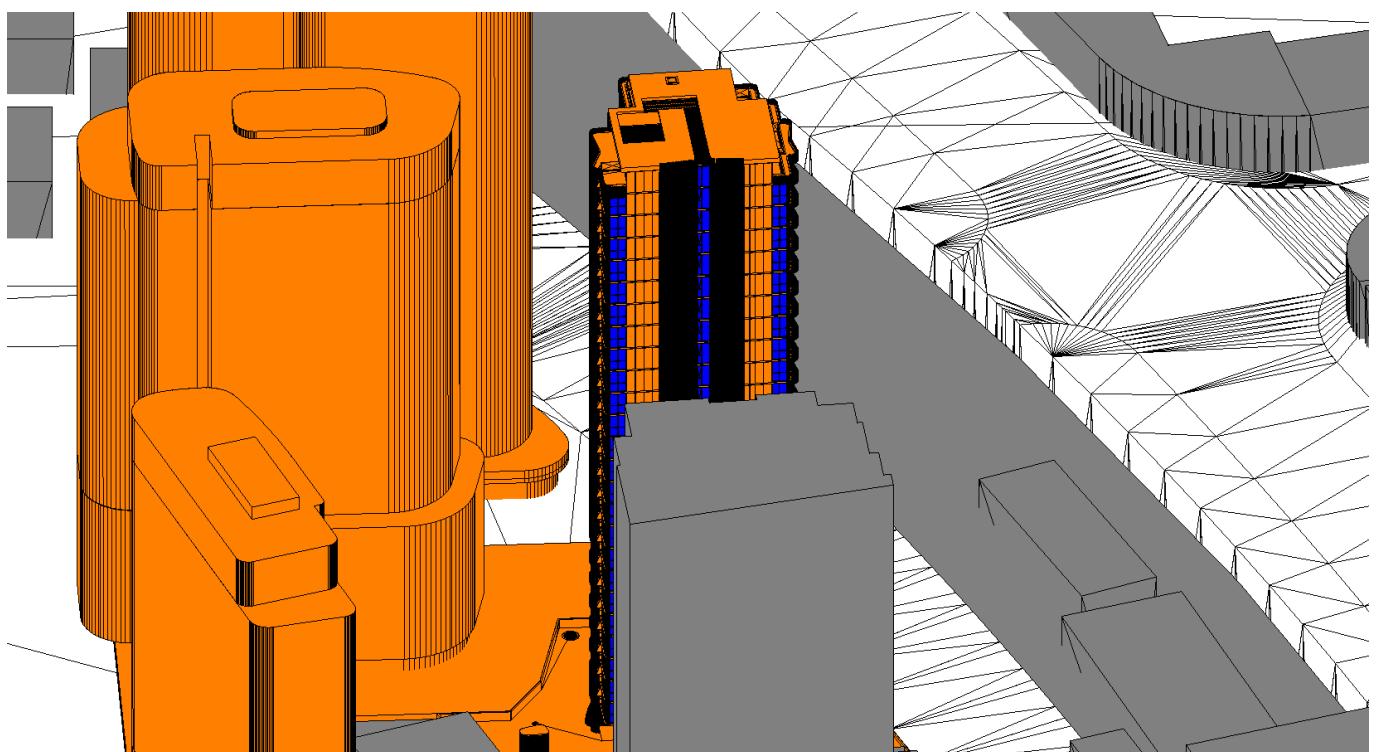
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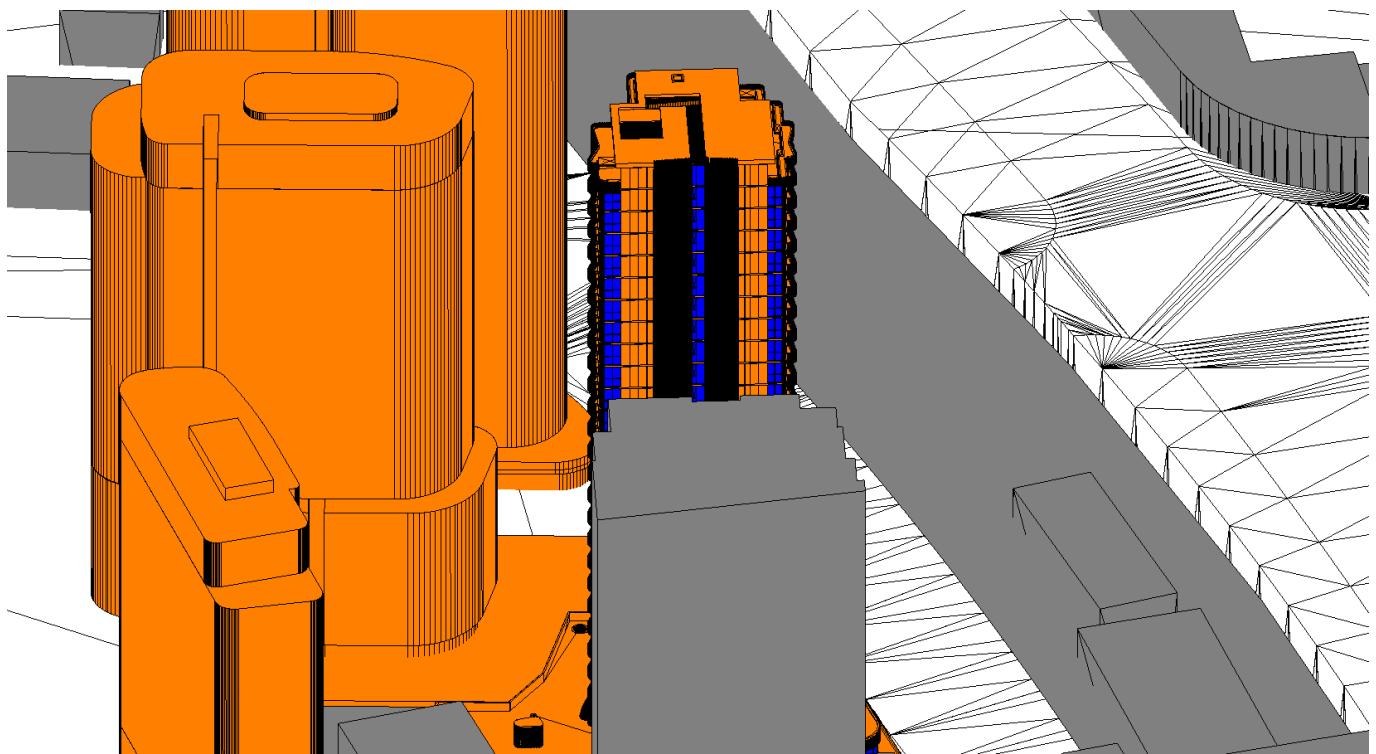
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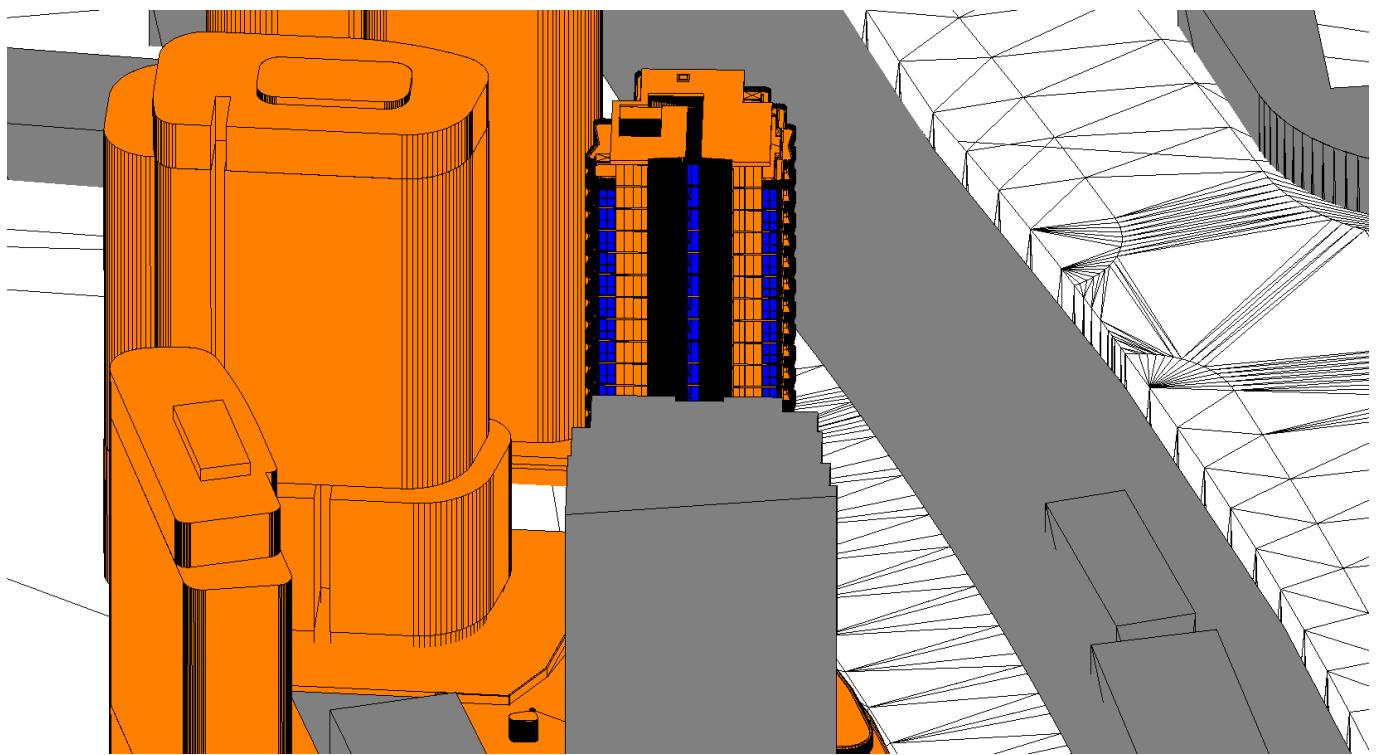
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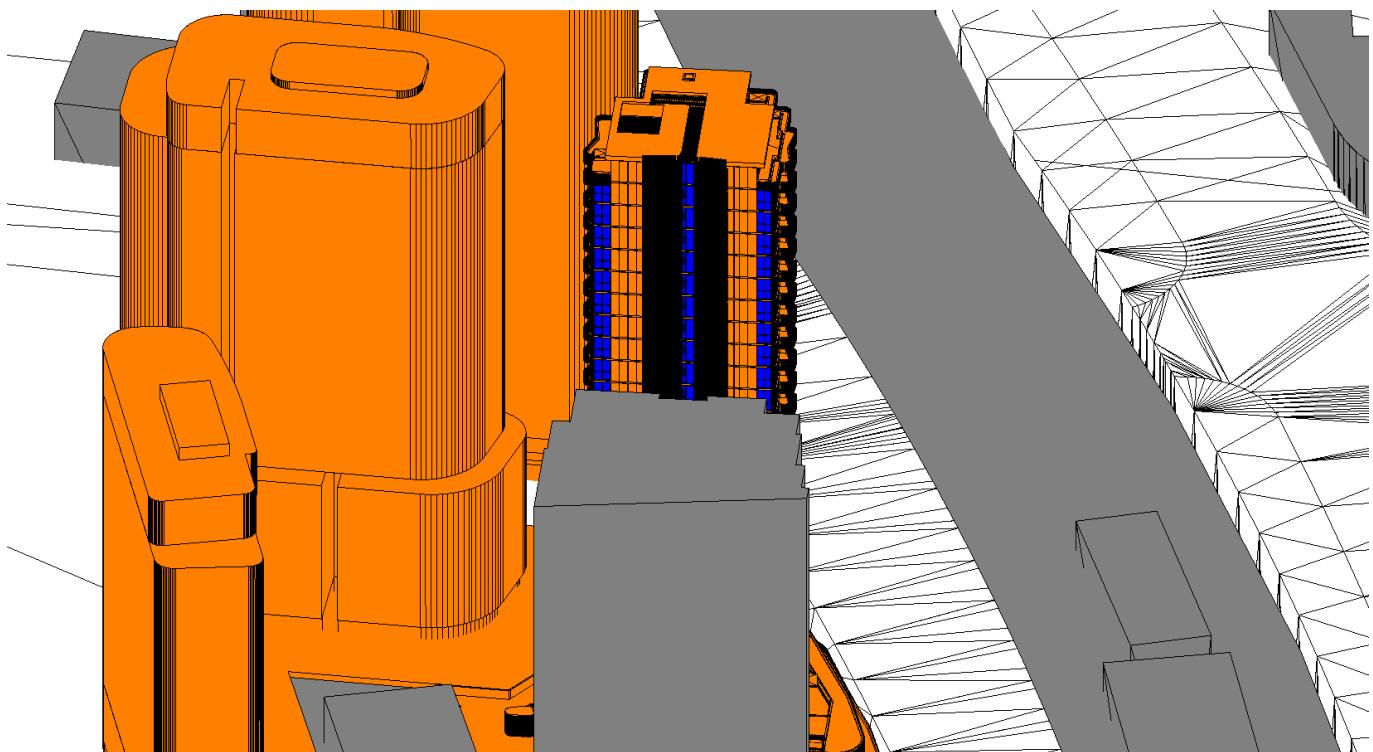
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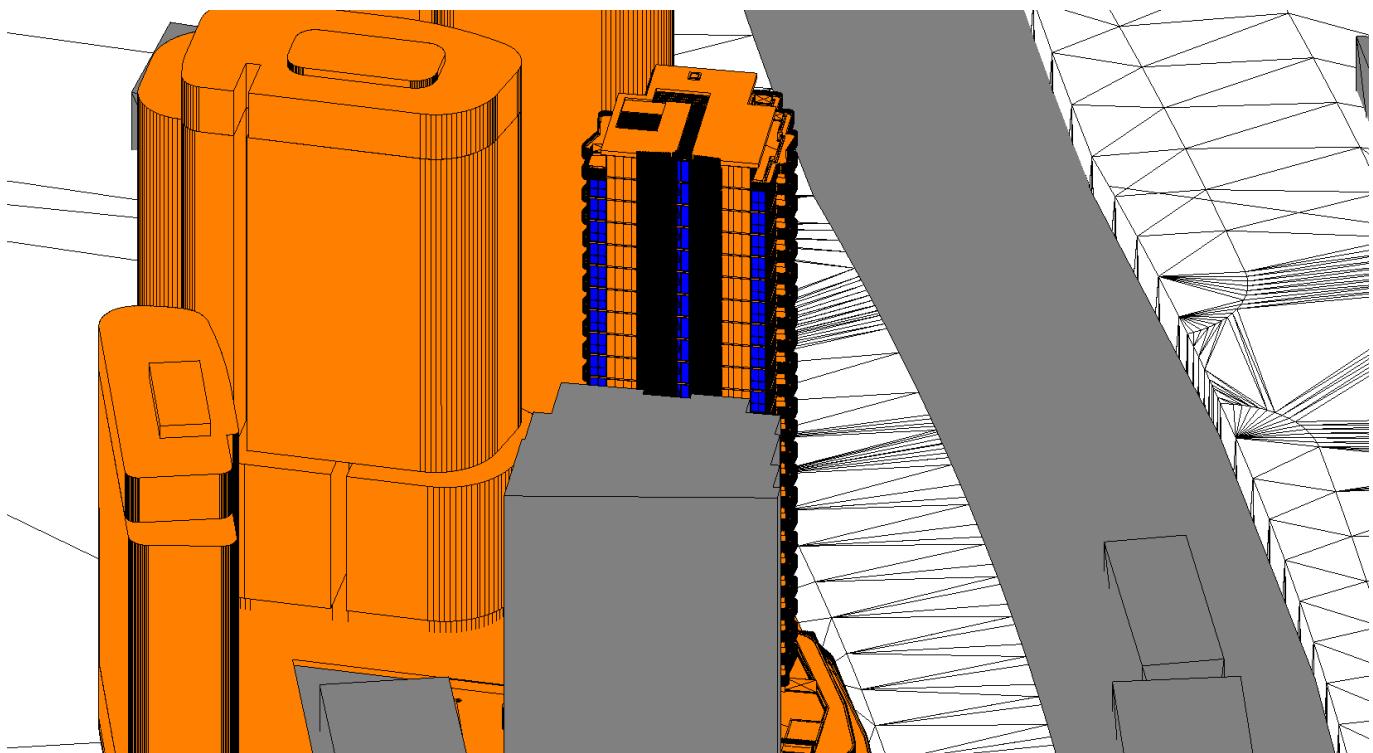
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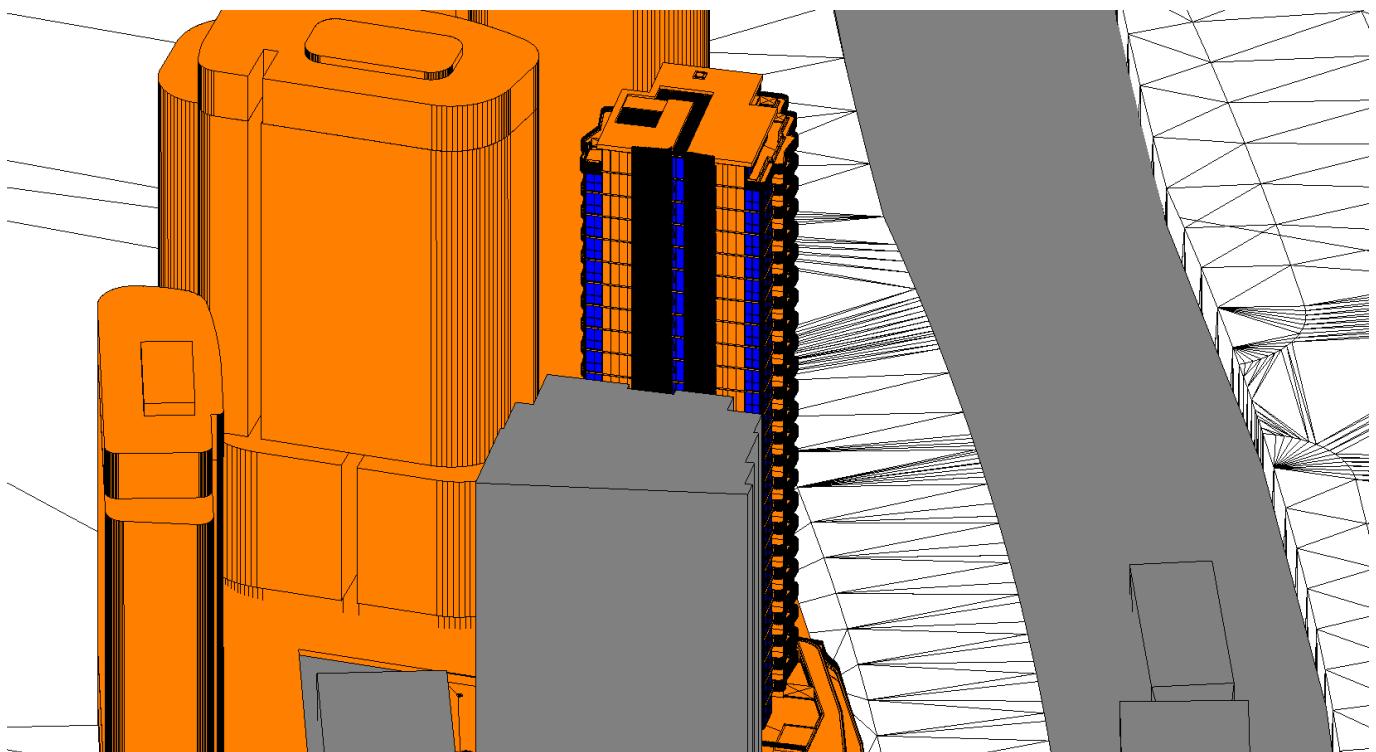
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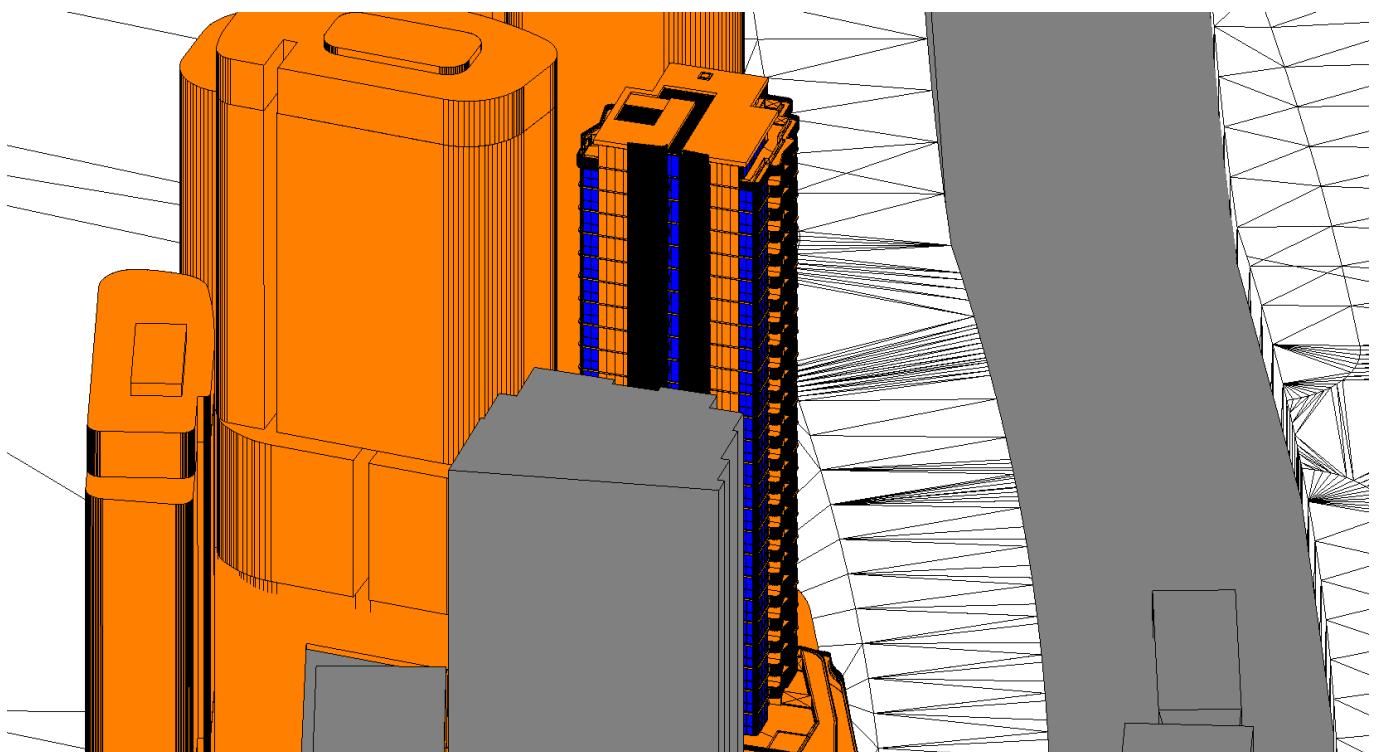
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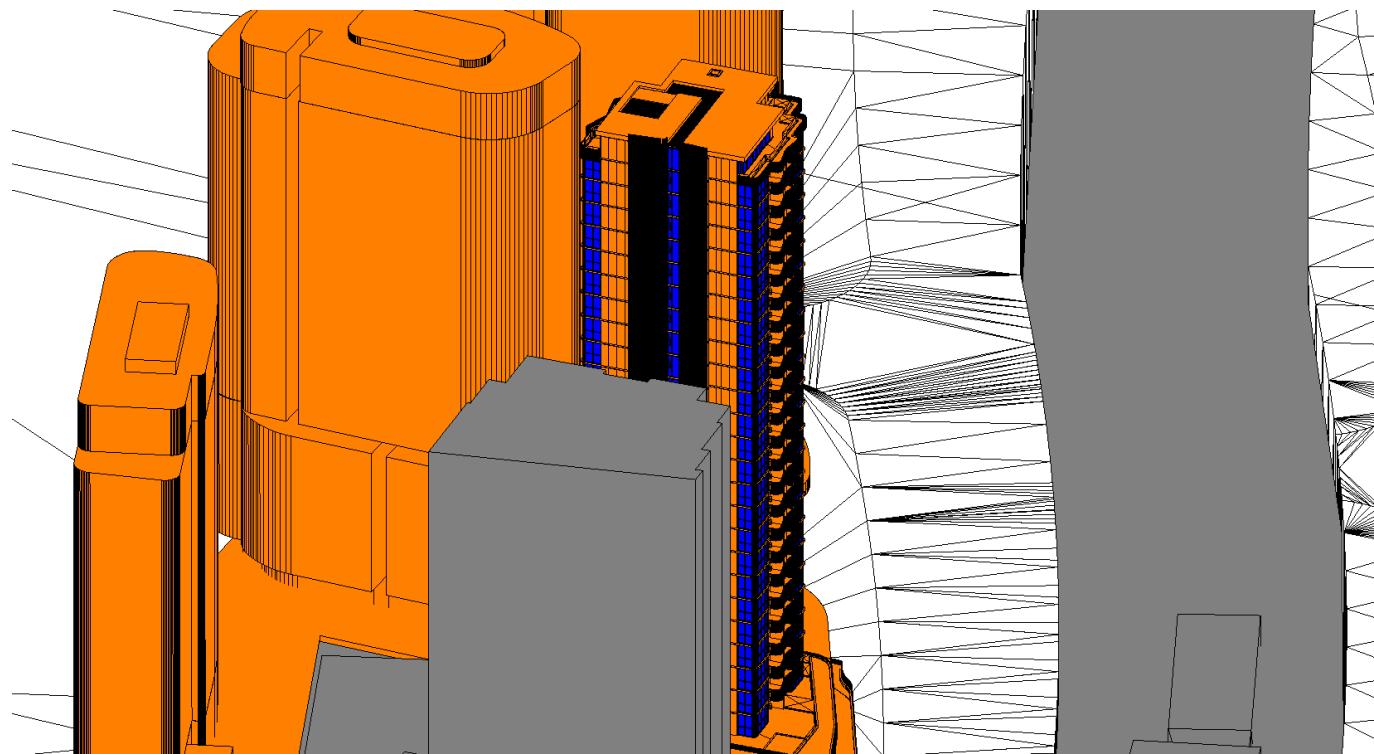
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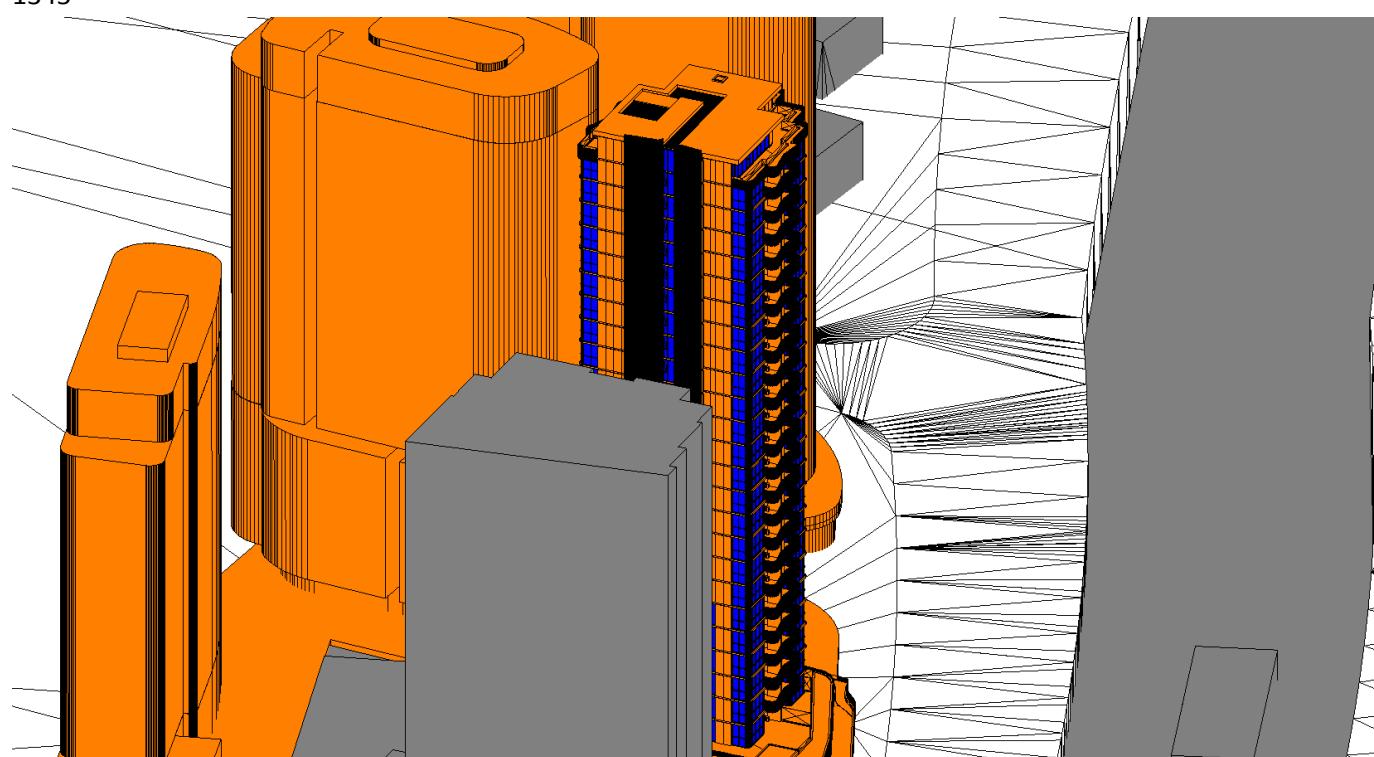
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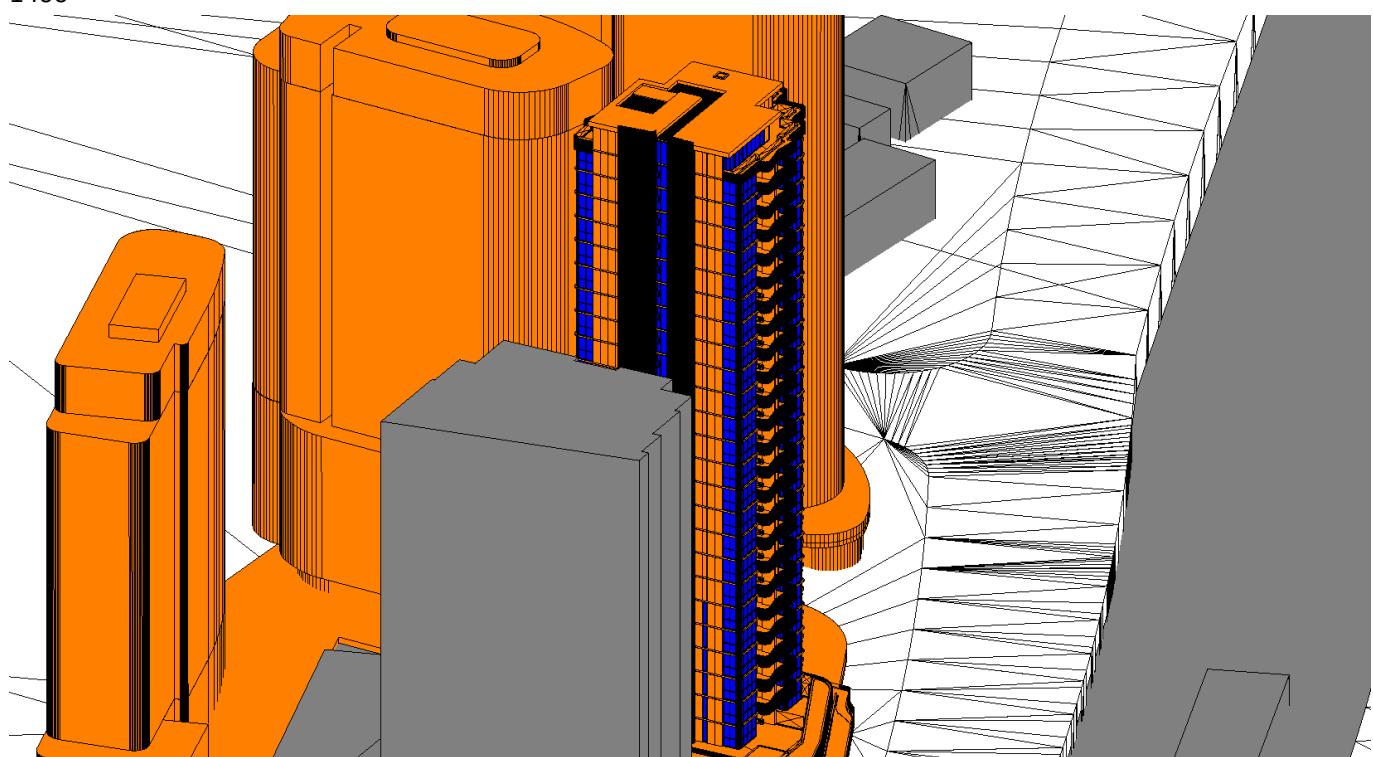
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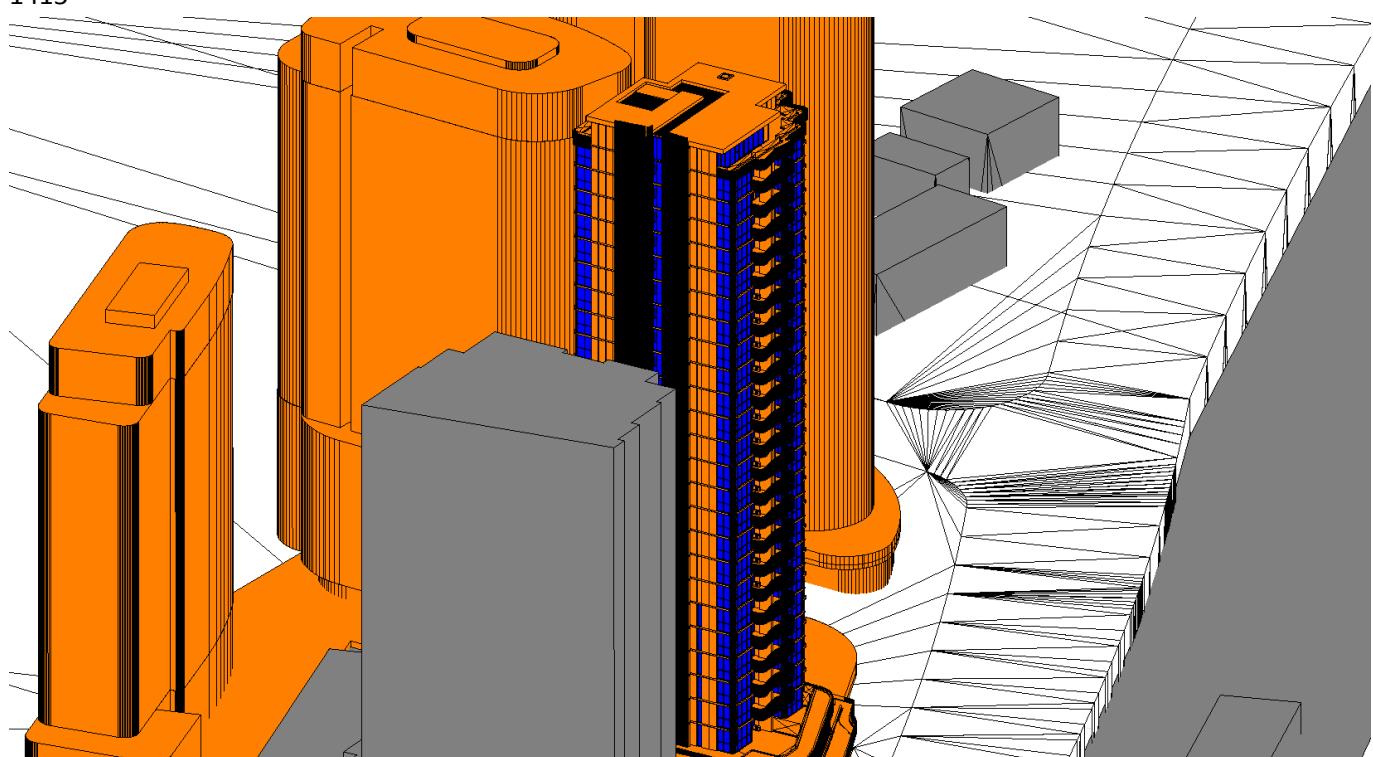
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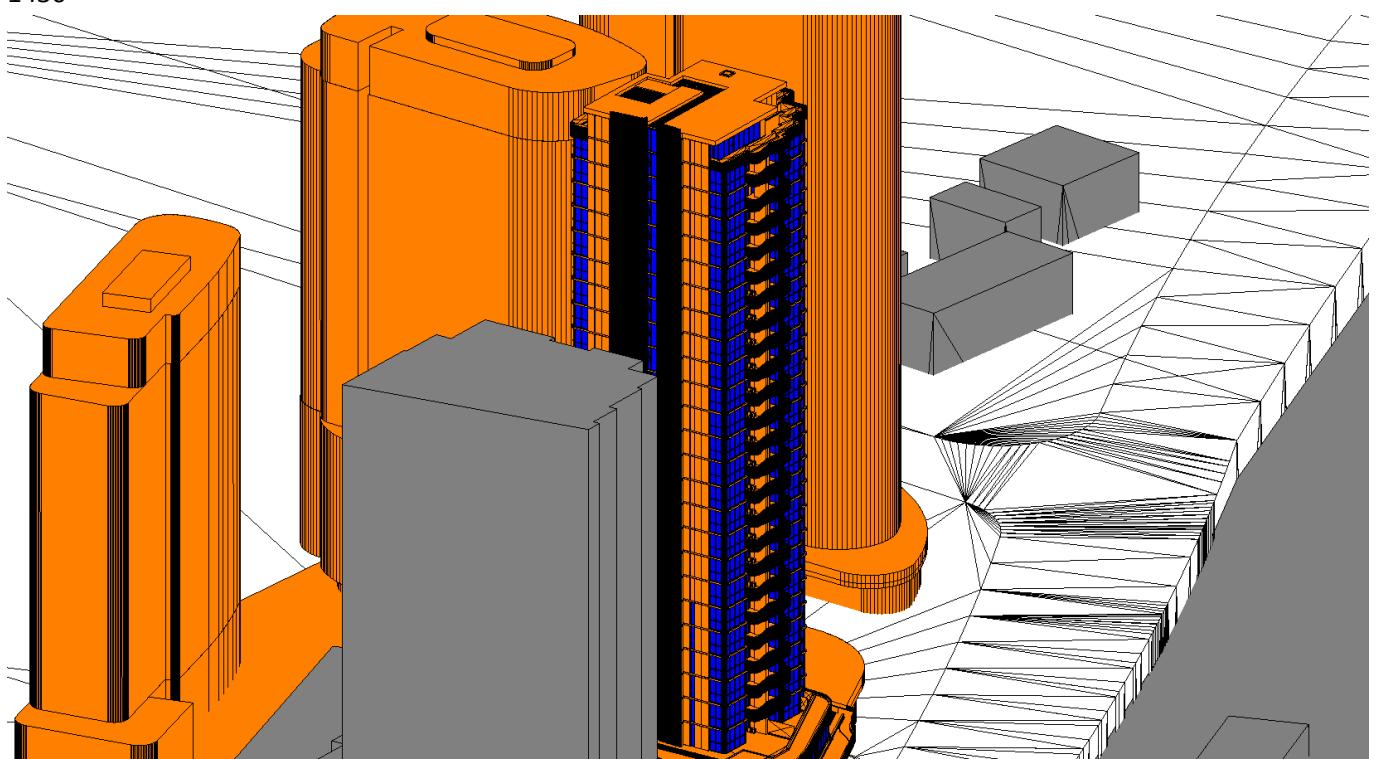
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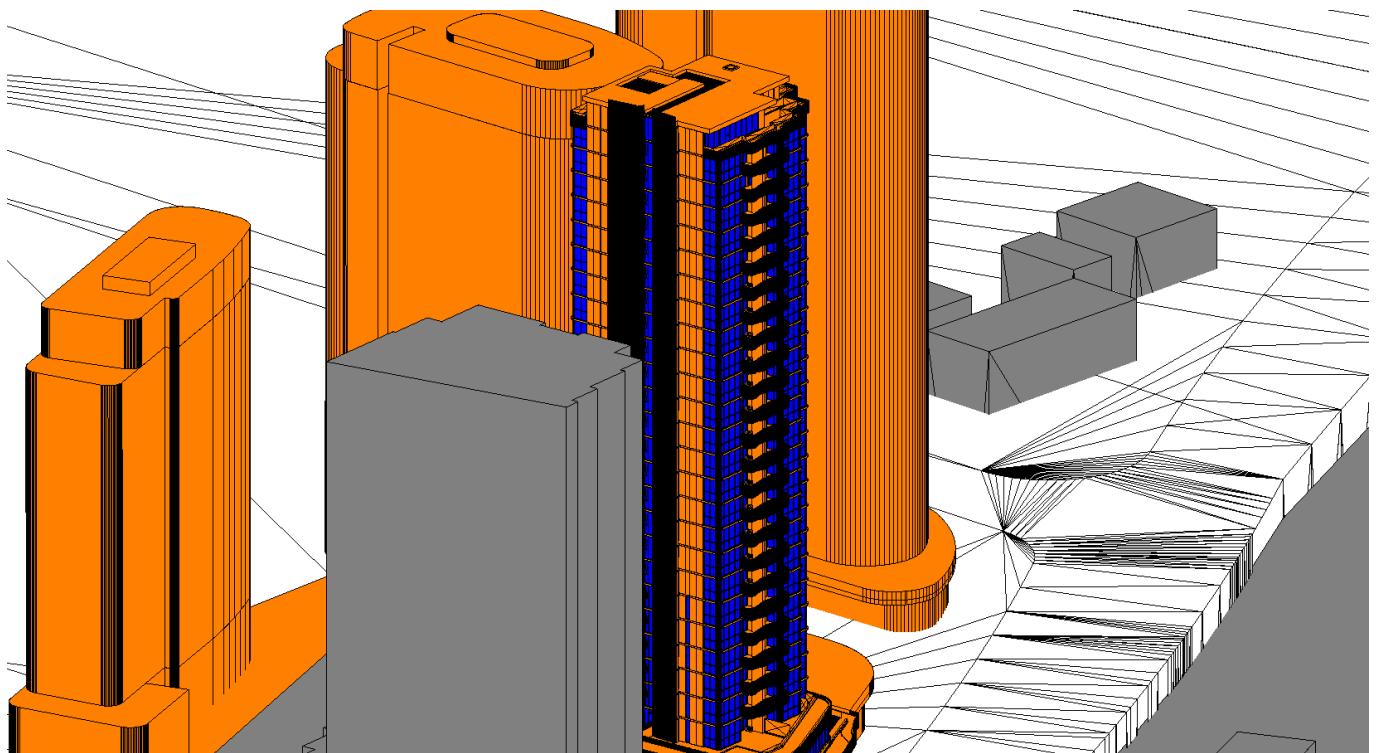
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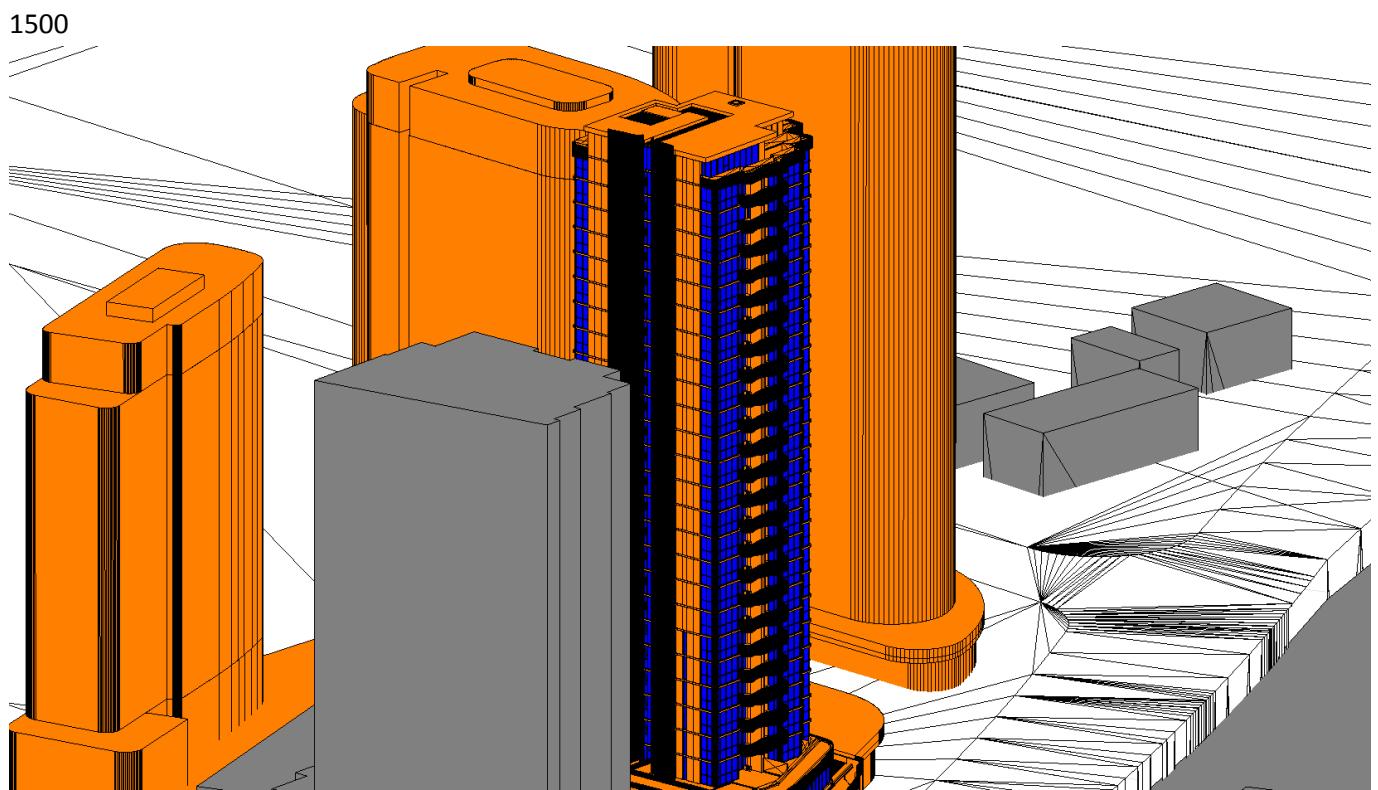


1430



1445





# APPENDIX O

Solar Access to Private Living Space Calculation 24-36 Langston Place

Building	Level	Unit	Solar access to one living area															Total apartments			Total hr of sunlight betw 9am-15:00	2hr sunlight betw 9:00-15:00	No direct sunlight														
			9:00	9:15	9:30	9:45	10:00	10:15	10:30	10:45	11:00	11:15	11:30	11:45	12:00	12:15	12:30	12:45	13:00	13:15	13:30	13:45	14:00	14:15	14:30	14:45	15:00	3pm									
1	2	1																0.25	0.25	0.25	0.25	0.25	0.25	0.25	0.25	0.25	0.25	0.25	0.25	0.25	0.25	0.25	0.25	2	1	0	
1	2	2																0.25															2	1	0		
1	2	3																0.25															0.25	0	0		
1	2	4																0.25	0.25	0.25	0.25	0.25	0.25	0.25	0.25	0.25	0.25	0.25	0.25	0.25	0.25	0.25	0.25	0	0	1	
1	2	5																0.25	0.25	0.25	0.25	0.25	0.25	0.25	0.25	0.25	0.25	0.25	0.25	0.25	0.25	0.25	0.25	2.25	1	0	
1	3	1																0.25	0.25	0.25	0.25	0.25	0.25	0.25	0.25	0.25	0.25	0.25	0.25	0.25	0.25	0.25	0.25	2	1	0	
1	3	2																0.167	0.25	0.25	0.25	0.25	0.25	0.25	0.25	0.25	0.25	0.25	0.25	0.25	0.25	0.25	0.25	0.25	0.25	0.25	0
1	3	3																0.25															0.25	0	0		
1	3	4																0.25															0.25	0	1		
1	3	5																0.25	0.25	0.25	0.25	0.25	0.25	0.25	0.25	0.25	0.25	0.25	0.25	0.25	0.25	0.25	0.25	2.25	1	0	
1	4	1																0.167	0.25	0.25	0.25	0.25	0.25	0.25	0.25	0.25	0.25	0.25	0.25	0.25	0.25	0.25	0.25	0.25	0.25	0.25	0
1	4	2																0.25															0.25	0	0		
1	4	3																0.25															0.25	0	0		
1	4	4																0.25															0.25	0	1		
1	4	5																0.25															0.25	0	0		
1	5	1																0.167	0.25	0.25	0.25	0.25	0.25	0.25	0.25	0.25	0.25	0.25	0.25	0.25	0.25	0.25	0.25	0.25	0.25	0.25	0
1	5	2																0.25															0.25	0	1		
1	5	3																0.25															0.25	0	0		
1	5	4																0.25															0.25	0	1		
1	5	5																0.25															0.25	0	0		
1	6	1																0.167	0.25	0.25	0.25	0.25	0.25	0.25	0.25	0.25	0.25	0.25	0.25	0.25	0.25	0.25	0.25	0.25	0.25	0.25	0
1	6	2																0.25															0.25	0	0		
1	6	3																0.25															0.25	0	0		
1	6	4																0.25															0.25	0	1		
1	6	5																0.25															0.25	0	0		
1	7	1																0.167	0.25	0.25	0.25	0.25	0.25	0.25	0.25	0.25	0.25	0.25	0.25	0.25	0.25	0.25	0.25	0.25	0.25	0.25	0
1	7	2																0.25															0.25	0	1		
1	7	3																0.25															0.25	0	0		
1	7	4																0.25															0.25	0	0		
1	7	5																0.25															0.25	0	0		
1	8	1																0.25															0.25	0	0		
1	8	2																0.25	0.25	0.25	0.25	0.25	0.25	0.25	0.25	0.25	0.25	0.25	0.25	0.25	0.25	0.25	0.25	0.25	0.25	0.25	0
1	8	3																0.25															0.25	0	0		
1	8	4																0.25															0.25	0	0		
1	9	1																0.25															0.25	0	0		
1	9	2																0.25	0.25	0.25	0.25	0.25	0.25	0.25	0.25	0.25	0.25	0.25	0.25	0.25	0.25	0.25	0.25	0.25	0.25	0.25	0
1	9	3																0.25															0.25	0	0		
1	9	4																0.25															0.25	0	0		
1	10	1																0.25															0.25	0	0		
1	10	2																0.25															0.25	0	0		
1	10	3																0.25															0.25	0	0		
1	10	4																0.25															0.25	0	0		
1	11	1																0.25															0.25	0	0		
1	11	2																0.25	0.25	0.25	0.25	0.25	0.25	0.25	0.25	0.25	0.25	0.25	0.25	0.25	0.25	0.25	0.25	0.25	0.25	0.25	0
1	11	3																0.25															0.25	0	0		
1	12	1																0.25															0.25	0	0		
1	12	2																0.25	0.25	0.25	0.25	0.25	0.25	0.25	0.25	0.25	0.25	0.25	0.25	0.25	0.25	0.25	0.25	0.25	0.25	0.25	0
1	12	3																0.25															0.25	0	0		
1	12	4																0.25															0.25	0	0		
1	13	1																0.25															0.25	0	0		
1	13	2																0.25	0.25	0.25	0.25	0.25	0.25	0.25	0.25	0.25	0.25	0.25	0.25	0.25	0.25	0.25	0.25	0.25	0.25	0.25	0
1	13	3																0.25	0.25	0.25	0.25	0.25	0.25	0.25	0.25	0.25	0.25	0.25	0.25	0.25	0.25	0.25	0.25	0.25	0.25	0.25	0
1	14	1																0.25															0.25	0	0		
1	14	2																0.25															0.25	0	0		
1	14	3																0.25															0.25	0	0		
1	14	4																0.25															0.25	0	0		
1	15	1																0.25															0.25	0	0		
1	15	2																0.25															0.25	0	0		
1	15	3																																			

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